


STATE ROAD NO. 5
U.S. HIGHWAY NO. 1

SITE DEMOLITION PLAN


DEMOLITION NOTES & LEGEND

- | | | |
|---|--------------------------------------|--|
| 1. NO TREES TO BE REMOVED AS PART OF THIS PERMIT. | 6. --- DENOTES TO BE REMOVED | 11. [Symbol] COLUMN AT BUILDING ENTRANCE TO REMAIN |
| 2. ALL EXISTING PAVEMENT MARKINGS AND SIGNS WITHIN PROPERTY LINES TO BE REMOVED. REFER TO C-7 FOR NEW SIGNS AND PAVEMENT MARKINGS. | 7. [Symbol] DENOTES TO REMAIN | 12. [Symbol] COLUMN AT BUILDING ENTRANCE TO REMAIN |
| 3. EXISTING ASPHALT PAVEMENT AND BASE TO BE REMOVED (DEPTH OF BASE REMOVAL BASED ON PROPOSED GRADES). REFER TO SHADED AREA LEGEND #8. | 8. [Symbol] ASPHALT TO BE REMOVED | 13. [Symbol] COLUMN AT BUILDING ENTRANCE TO REMAIN |
| 4. CURBS, CONC. WALKS, HAND RAILS, BOLLARDS, LIGHTS, PLANTERS, OVERHANGS, TO BE REMOVED ON THE BUILDING EXPANSION SIDE. | 9. [Symbol] CONCRETE TO BE REMOVED | |
| 5. = = = = CONCRETE CURB TO BE REMOVED | 10. [Symbol] LANDSCAPE TO BE REMOVED | |

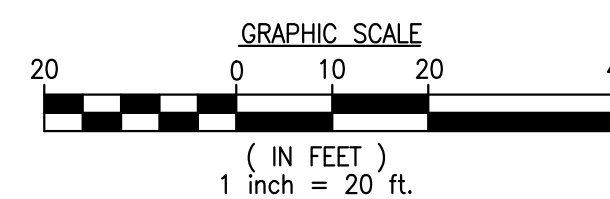

DEMOLITION SCHEDULE - GC TO VERIFY

ASPHALT TO BE REMOVED	17,897.68 SQ. FT.
LANDSCAPE TO BE REMOVED	5,094.24 SQ. FT.
CONC. SIDEWALK TO BE REMOVED	1,315.50 SQ. FT.
CONC. CURB TO BE REMOVED	1,324.69 LF
RETAINING WALL TO BE REMOVED	103.00 LF
SAWCUT (ASPHALT & CONCRETE)	1,491.27 LF

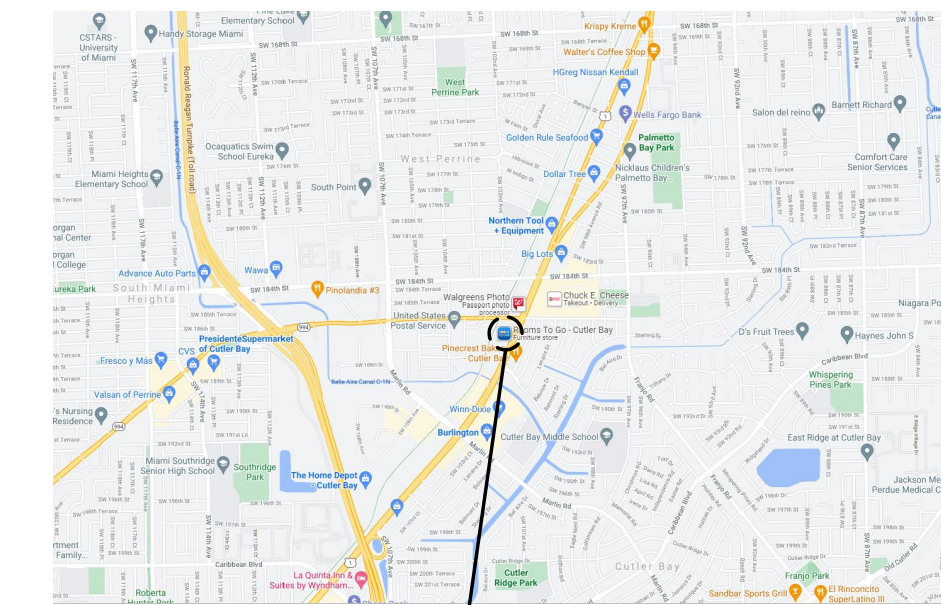

LOCATION MAP

THIS SITE LIES IN SECTION 5, TOWNSHIP 56 SOUTH, RANGE 40 EAST, CITY OF CUTLER BAY, MIAMI-DADE COUNTY, FLORIDA.

LEGAL DESCRIPTION:

PARCEL 1: (ORIGINAL LEASE - ROOMS TO GO FURNITURE SHOWROOM): All of Lot 4 and portions of Lots 1, 2 and 3 of Block 6 of POINT WEST FOURTH ADDITION, according to the Plat thereof recorded in Plat Book 107, Page 67 of the Public Records of Miami-Dade County, Florida, being particularly described as follows:

Beginning at the Southeast corner of said Lot 4; thence N69°39'45"W along the Southwesterly line of said Lot 4 for 286.90 feet to the Southwest corner of said Lot 4; thence N22°31'22"E along the Northwesterly line of said POINT WEST FOURTH ADDITION for 244.00 feet; thence S22°32'11"W for 60.02 feet; thence S22°32'11"W for 12.82 feet; thence S67°27'49"E for 100.00 feet; thence S22°32'11"W for 31.17 feet; thence S67°27'49"E for 99.00 feet; thence S22°32'11"W for 22.00 feet; thence S67°27'49"E for 28.00 feet to a point on the Southeastery line of said POINT WEST FOURTH ADDITION; thence run the following courses and distances along the said Southeastery line of said POINT WEST FOURTH ADDITION: S22°32'11"W for 102.50 feet to a point of curvature of a circular curve to the right; thence to the right along-said curve having for its elements a radius of 7606.49 feet and a central angle of 0°29'09" for an arc distance of 64.51 feet to the Point of Beginning.

PARCEL 2: (ADDITIONAL LANDS 8/12/1993 AMENDMENT TO LEASE)

A portion of 1, 2 and 3 of Block 6 of POINT WEST FOURTH ADDITION, according to the Plat thereof recorded in Plat Book 107, at Page 67 of the Public Records of Miami-Dade County, Florida; a portion of Lot 10 of Block 6 of POINT WEST SEVENTH ADDITION, according to the Plat thereof recorded in Plat Book 116, at Page 58 of the Public Records of Miami-Dade County, Florida; AND a portion of Tract 12 of PERRINE GRANT SUBDIVISION of Section 5, Township 56 South, Range 40 East, according to the Plat thereof recorded in Plat Book 1, at Page 4 of the Public Records of Miami-Dade County, Florida, ALL being particularly described as follows:

Beginning at the Southwest corner of Lot 4 of Block 6 of said POINT WEST FOURTH ADDITION; thence N67°28'38"W for 50.00 feet to a point on the Southeastery Right-of-Way line of the Florida Department of Transportation Limited Access Corridor; thence N22°31'22"E along the said Southeastery Right-of-Way line of the Florida Department of Transportation Limited Access Corridor for 298.87 feet; thence N89°59'10"E for 54.13 feet to a point on the boundary line of said Lot 10 of Block 6; thence continue N89°59'10"E along the said boundary line of Lot 10 for 54.13 feet; thence S22°31'22"W for 3.05 feet; thence S67°27'49"E for 237.04 feet to the Southeastery line of said Lot 1 of Block 6; thence S22°32'11"W along the Southeastery lines of said Lots 1, 2 and 3 of Block 6 of 159.31 feet; thence N67°27'49"W for 28.00 feet; thence N22°32'11"E for 22.00 feet; thence N67°27'49"W for 99.00 feet; thence N22°32'11"E for 31.17 feet; thence N67°27'49"W for 100.00 feet; thence N22°32'11"E for 12.82 feet; thence N67°28'38"W for 60.02 feet to a point on the Northwesterly line of said Lot 1 of Block 6; thence S22°31'22"W along the Northwesterly lines of said Lots 1, 2, 3 and 4 of Block 6 for 244.00 feet to the Point of Beginning, LESS AND EXCEPT THEREFROM those lands included in the right-of-way of the State of Florida, Florida Department of Transportation Limited Access Corridor.

PARCEL 3: (TROPICAL FINANCIAL CREDIT UNION LAND TO BE ADDED TO LEASE)

Lot 5, Block 6, POINT WEST FOURTH ADDITION, according to the Plat thereof recorded in Plat Book 107, page 67, of the Public Records of Miami-Dade County, Florida.

PAVEMENT BID NOTE:
BIDDERS SHALL PROVIDE ALTERNATIVE BID TO MILL AND OVERLAY EXISTING ASPHALT.

GENERAL NOTES

- SEE SURVEY FOR DESCRIPTION OF EXISTING FEATURES WITHIN SITE.
- THE CONTRACTOR SHALL BE FULLY RESPONSIBLE FOR THE DEMOLITION OF EXISTING ON SITE FACILITIES ABOVE AND UNDERGROUND. THE CONTRACTOR IS RESPONSIBLE FOR THE REMOVAL FROM THE SITE OF ALL DEMOLISHED MATERIALS. THE FILLING OF ALL DEPRESSIONS CAUSED BY DEMOLITION, AND THE GRADING OF THESE AREAS SO AS NOT TO BE OBJECTIONABLE TO VIEW. THE CONTRACTOR SHALL OBSERVE ALL REQUIRED SAFETY PRECAUTIONS IN THE PERFORMANCE OF HIS WORK.
- REMOVE ALL VEGETATION, ROLL AND COMPACT AREAS BEFORE REPLACING FILL. FILL SHALL BE LOCALLY ACCEPTABLE AND SUITABLE FOR FILL PURPOSES, IN ACCORDANCE WITH THE GEOTECHNICAL ENGINEERING REPORT DATED DECEMBER 8, 2021, PREPARED BY ECS FLORIDA, LLC (PROJECT NO. 25.3768), AND PROJECT SPECIFICATIONS SECTIONS IN DIVISION 2.
- THE CONTRACTOR SHALL BE REQUIRED TO STABILIZE SLOPED AREAS. THE CONTRACTOR SHALL GRADE AND SOD THE AREA WITH THE PROVISION THAT HE SHALL MAINTAIN THE SODDED AREA AS REQUIRED UNTIL SUCH TIME THAT THERE IS SUITABLE GROWTH TO ADEQUATELY PROTECT THE EMBANKMENT. THE MAXIMUM ALLOWABLE SLOPE SHALL BE 2 : 1. CONTRACTOR SHALL MATCH EXISTING GRADES AND ALL PROPERTY LINES AROUND SITE, UNLESS OTHERWISE SHOWN ON GRADING PLAN. FINISHED GRADING AND LANDSCAPING BY LANDSCAPE CONTRACTOR. GENERAL CONTRACTOR IS TO GRADE ALL LANDSCAPED AREAS TO WITHIN 4" (.33') OF FINISHED GRADES. ALL GRADES SHOWN ON GRADING PLAN ARE FINISHED GRADES.
- DIMENSIONS, BUILDING LOCATION AND GRADING OF THIS SITE ARE BASED ON AVAILABLE INFORMATION AT TIME OF LAYOUT. DEVIATIONS MAY BE NECESSARY IN THE FIELD. ANY SUCH CHANGES OR CONFLICTS BETWEEN THIS PLAN AND FIELD CONDITIONS ARE TO BE REPORTED TO THE ENGINEER PRIOR TO STARTING CONSTRUCTION.
- ALL CONSTRUCTION OF UTILITIES TO BE IN ACCORDANCE WITH LOCAL BUILDING CODES.
- CONCRETE SIDEWALKS TO BE 4,000 P.S.I. CONCRETE, 4" CONCRETE SLAB ON GRADE REINFORCED WITH MINIMUM 1.0 LBS./YARD POLYPROPYLENE, FIBRILLATED FIBERS - SEE PROJECT SPECIFICATIONS, COMPACTED SUB-BASE PER GEOTECHNICAL REPORT. SEE ARCHITECTURAL DRAWINGS FOR JOINTS & PLAN LAYOUT.
- ALL CONCRETE CURB TO BE CONSTRUCTED OF 4,000 P.S.I. CONCRETE.
- ALL WORK TO BE PERFORMED THAT IS NOT COVERED BY THESE PLANS SHALL BE CONSTRUCTED IN ACCORDANCE WITH APPLICABLE STATE, COUNTY, OR LOCAL CODES. ALL WORK IN PUBLIC RIGHT OF WAYS SHALL BE IN ACCORDANCE WITH ALL STATE AND LOCAL REQUIREMENTS AND STANDARDS.
- THE CONTRACTOR IS ADVISED THAT THE SOILS REPORT IS A PART OF THE BIDDING DOCUMENTS. IT IS THE BIDDER'S RESPONSIBILITY TO REVIEW THE SOILS REPORT PRIOR TO SUBMITTING A BID.

CKE GROUP
INCORPORATED
engineering • architecture • planning
(CERTIFICATE OF AUTHORIZATION - 4488)

19722
S. DIXIE HWY.
CUTLER BAY,
FLORIDA

ROOMS TO GO

11/29/2023 BID
03/13/2023 CITY COMMENTS
01/27/2023 CITY COMMENTS



revisions seal

ADD#2: 11-29-23
bid date: 11-09-23
permit:
owner date: 7-6-22

project no: 1789
scale: AS NOTED
date: 7-1-2022
drawn by: AG

17190 ROYAL PALM BLVD. • SUITE 2 • WESTON, FLORIDA 33326 • (954) 982-7211 - (305) 558-4124

SD-1

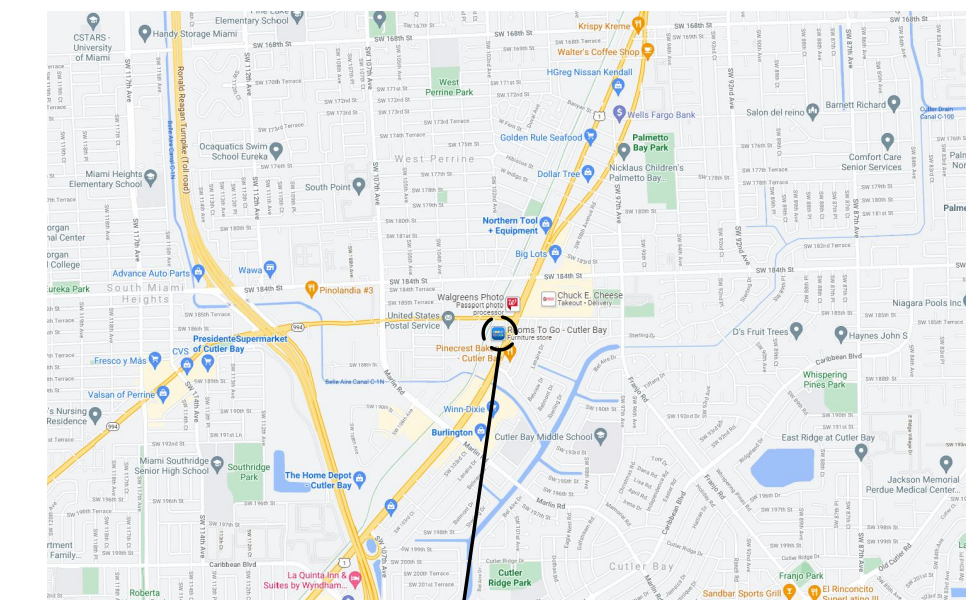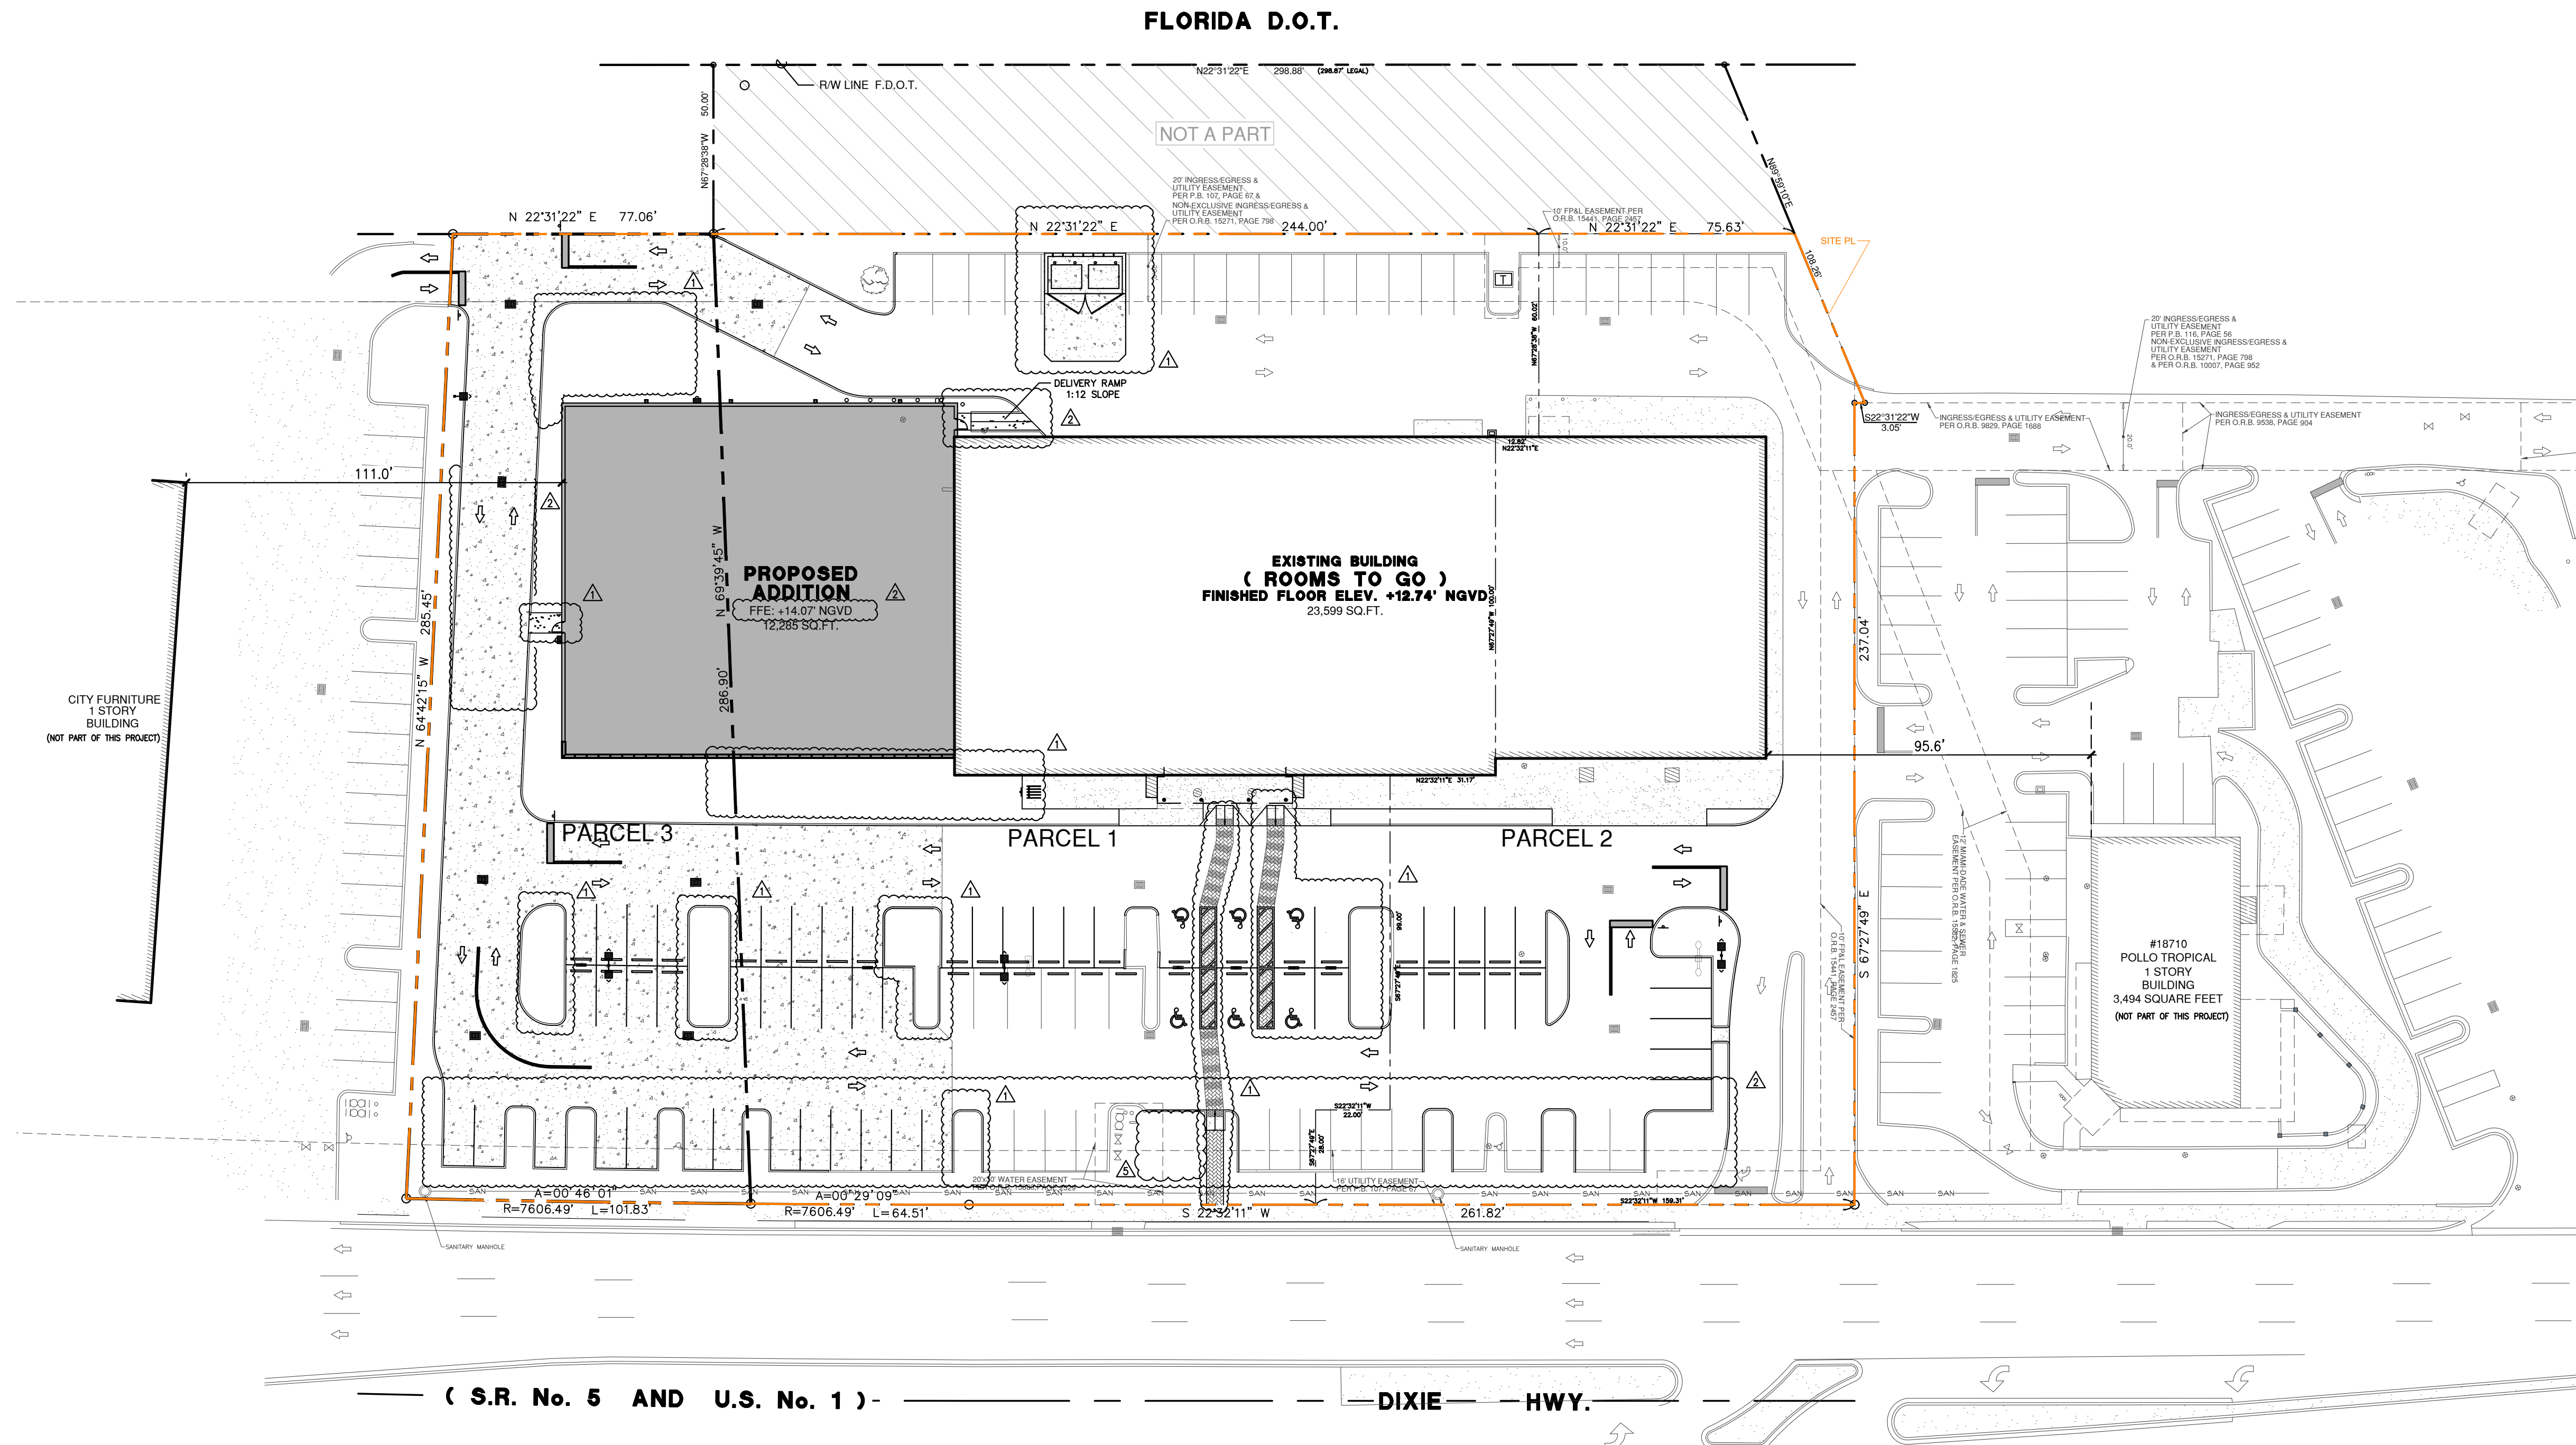


LEGAL DESCRIPTION:


PARCEL 1: (ORIGINAL LEASE - ROOMS TO GO FURNITURE SHOWROOM):
All of Lot 4 and portions of Lots 1, 2 and 3 of Block 6 of POINT WEST FOURTH ADDITION, according to the Plat thereof recorded in Plat Book 107, Page 67 of the Public Records of Miami-Dade County, Florida, being particularly described as follows:
Beginning at the Southeast corner of said Lot 4; thence N69°39'45"W along the Southwesterly line of said Lot 4 for 286.90 feet to the Southwest corner of said Lot 4; thence N22°31'22"E along the Northwesterly line of said POINT WEST FOURTH ADDITION for 244.00 feet; thence S67°28'38"E for 60.02 feet; thence S22°32'11"W for 12.82 feet; thence S67°27'49"E for 100.00 feet; thence S22°32'11"W for 31.17 feet; thence S67°27'49"E for 80.00 feet; thence S22°32'11"W for 22.00 feet; thence S67°27'49"E for 28.00 feet to a point on the Southeastery line of said POINT WEST FOURTH ADDITION; thence run the following courses and distances along the said Southeastery line of POINT WEST FOURTH ADDITION: S22°32'11"W for 102.50 feet to a point of curvature of a circular curve to the right; thence to the right along-said curve having for its elements a radius of 7606.49 feet and a central angle of 0°29'09" for an arc distance of 64.51 feet to the Point of Beginning.

PARCEL 2: (ADDITIONAL LANDS 8/12/1993 AMENDMENT TO LEASE)
A portion of 1, 2 and 3 of Block 6 of POINT WEST FOURTH ADDITION, according to the Plat thereof recorded in Plat Book 107, at Page 67 of the Public Records of Miami-Dade County, Florida; a portion of Lot 10 of Block 6 of POINT WEST SEVENTH ADDITION, according to the Plat thereof recorded in Plat Book 116, at Page 56 of the Public Records of Miami-Dade County, Florida; AND a portion of Tract 12 of FERRINE GRANT SUBDIVISION of Section 5, Township 56 South, Range 40 East, according to the Plat thereof recorded in Plat Book 1, at Page 4 of the Public Records of Miami-Dade County, Florida, ALL being particularly described as follows:
Beginning at the Southwest corner of Lot 4 of Block 6 of said POINT WEST FOURTH ADDITION; thence N67°28'38"W for 50.00 feet to a point on the Southeastery Right-of-Way line of the Florida Department of Transportation Limited Access Corridor; thence N22°31'22"E along the said Southeastery Right-of-Way line of the Florida Department of Transportation Limited Access Corridor for 298.87 feet; thence N89°59'10"E for 54.13 feet to a point on the boundary line of said Lot 10 of Block 6; thence continue N89°59'10"E along the said boundary line of Lot 10 for 54.13 feet; thence S22°31'22"W for 3.05 feet; thence S67°27'49"E for 237.04 feet to a point on the Southeastery line of said Lot 1 of Block 6; thence S22°32'11"W along the Southeastery lines of said Lots 1, 2 and 3 of Block 6 of 159.31 feet; thence N67°27'49"W for 28.00 feet; thence N22°32'11"E for 22.00 feet; thence N67°27'49"W for 93.00 feet; thence N22°32'11"E for 31.17 feet; thence N67°27'49"W for 100.00 feet; thence N22°32'11"E for 12.82 feet; thence N67°28'38"W for 60.02 feet to a point on the Northwesterly line of said Lot 1 of Block 6; thence S22°31'22"W along the Northwesterly lines of said Lots 1, 2, 3 and 4 of Block 6 for 244.00 feet to the Point of Beginning. LESS AND EXCEPT THEREFROM those lands included in the right-of-way of the State of Florida, Florida Department of Transportation Limited Access Corridor.

PARCEL 3: (TROPICAL FINANCIAL CREDIT UNION LAND TO BE ADDED TO LEASE)
Lot 5, Block 6, POINT WEST FOURTH ADDITION, according to the Plat thereof recorded in Plat Book 107, page 67, of the Public Records of Miami-Dade County, Florida.

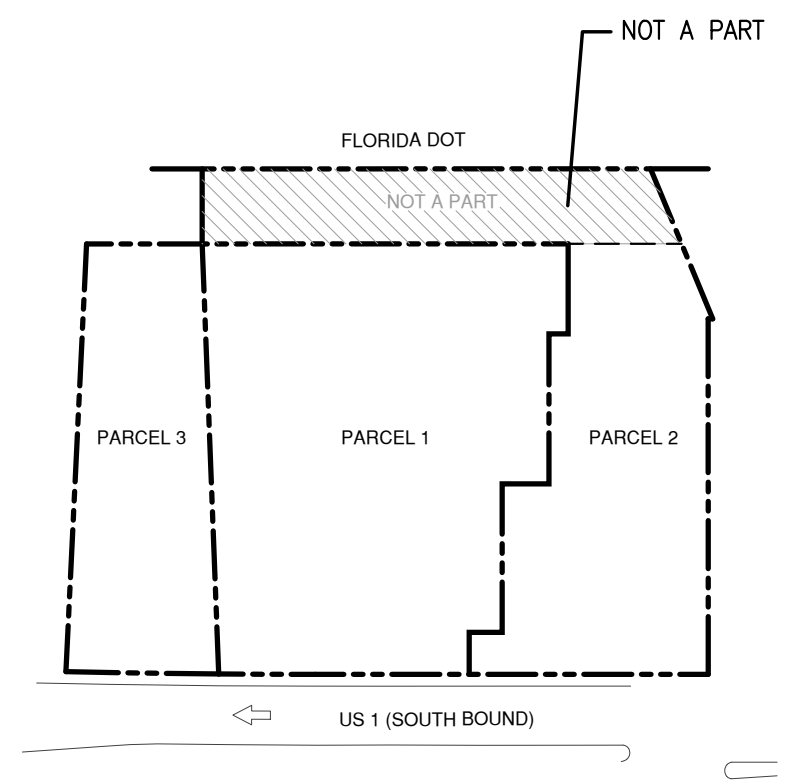

OVERALL SITE PLAN

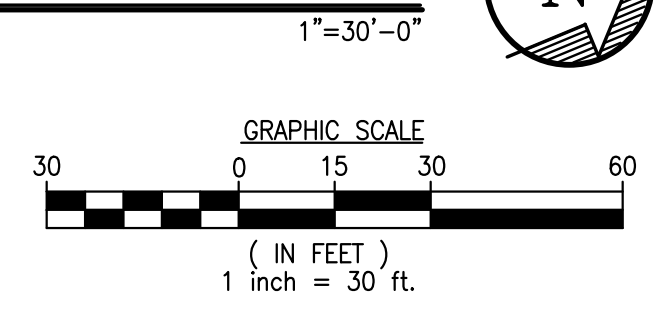

CKE GROUP
INCORPORATED
engineering • architecture • planning
(CERTIFICATE OF AUTHORIZATION - #488)

18722
S. DIXIE HWY.
CUTLER BAY,
FLORIDA

ROOMS TO GO

17190 ROYAL PALM BLVD. • SUITE 2 • WESTON, FLORIDA 33326 • [954] 982-7211 • [305] 558-4124



11/29/2023 BID
03/13/2023 CITY COMMENTS
01/17/2023 CITY COMMENTS

revisions seal

ADD#2: 11-29-23
bid date: 11-09-23
permit:
owner date: 7-6-22

project no: 1789
scale: AS NOTED
date: 7-1-2022
drawn by: AG

C-0

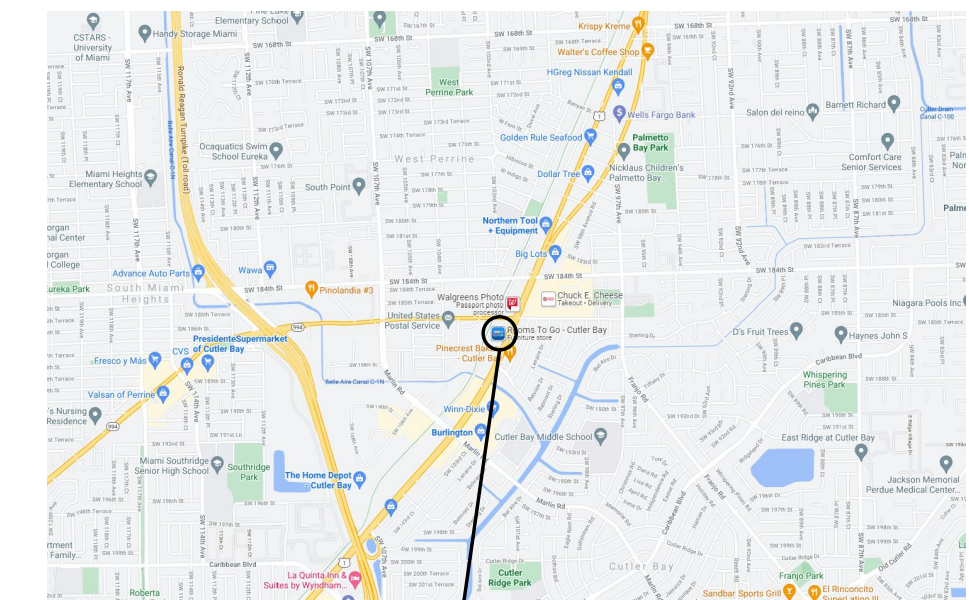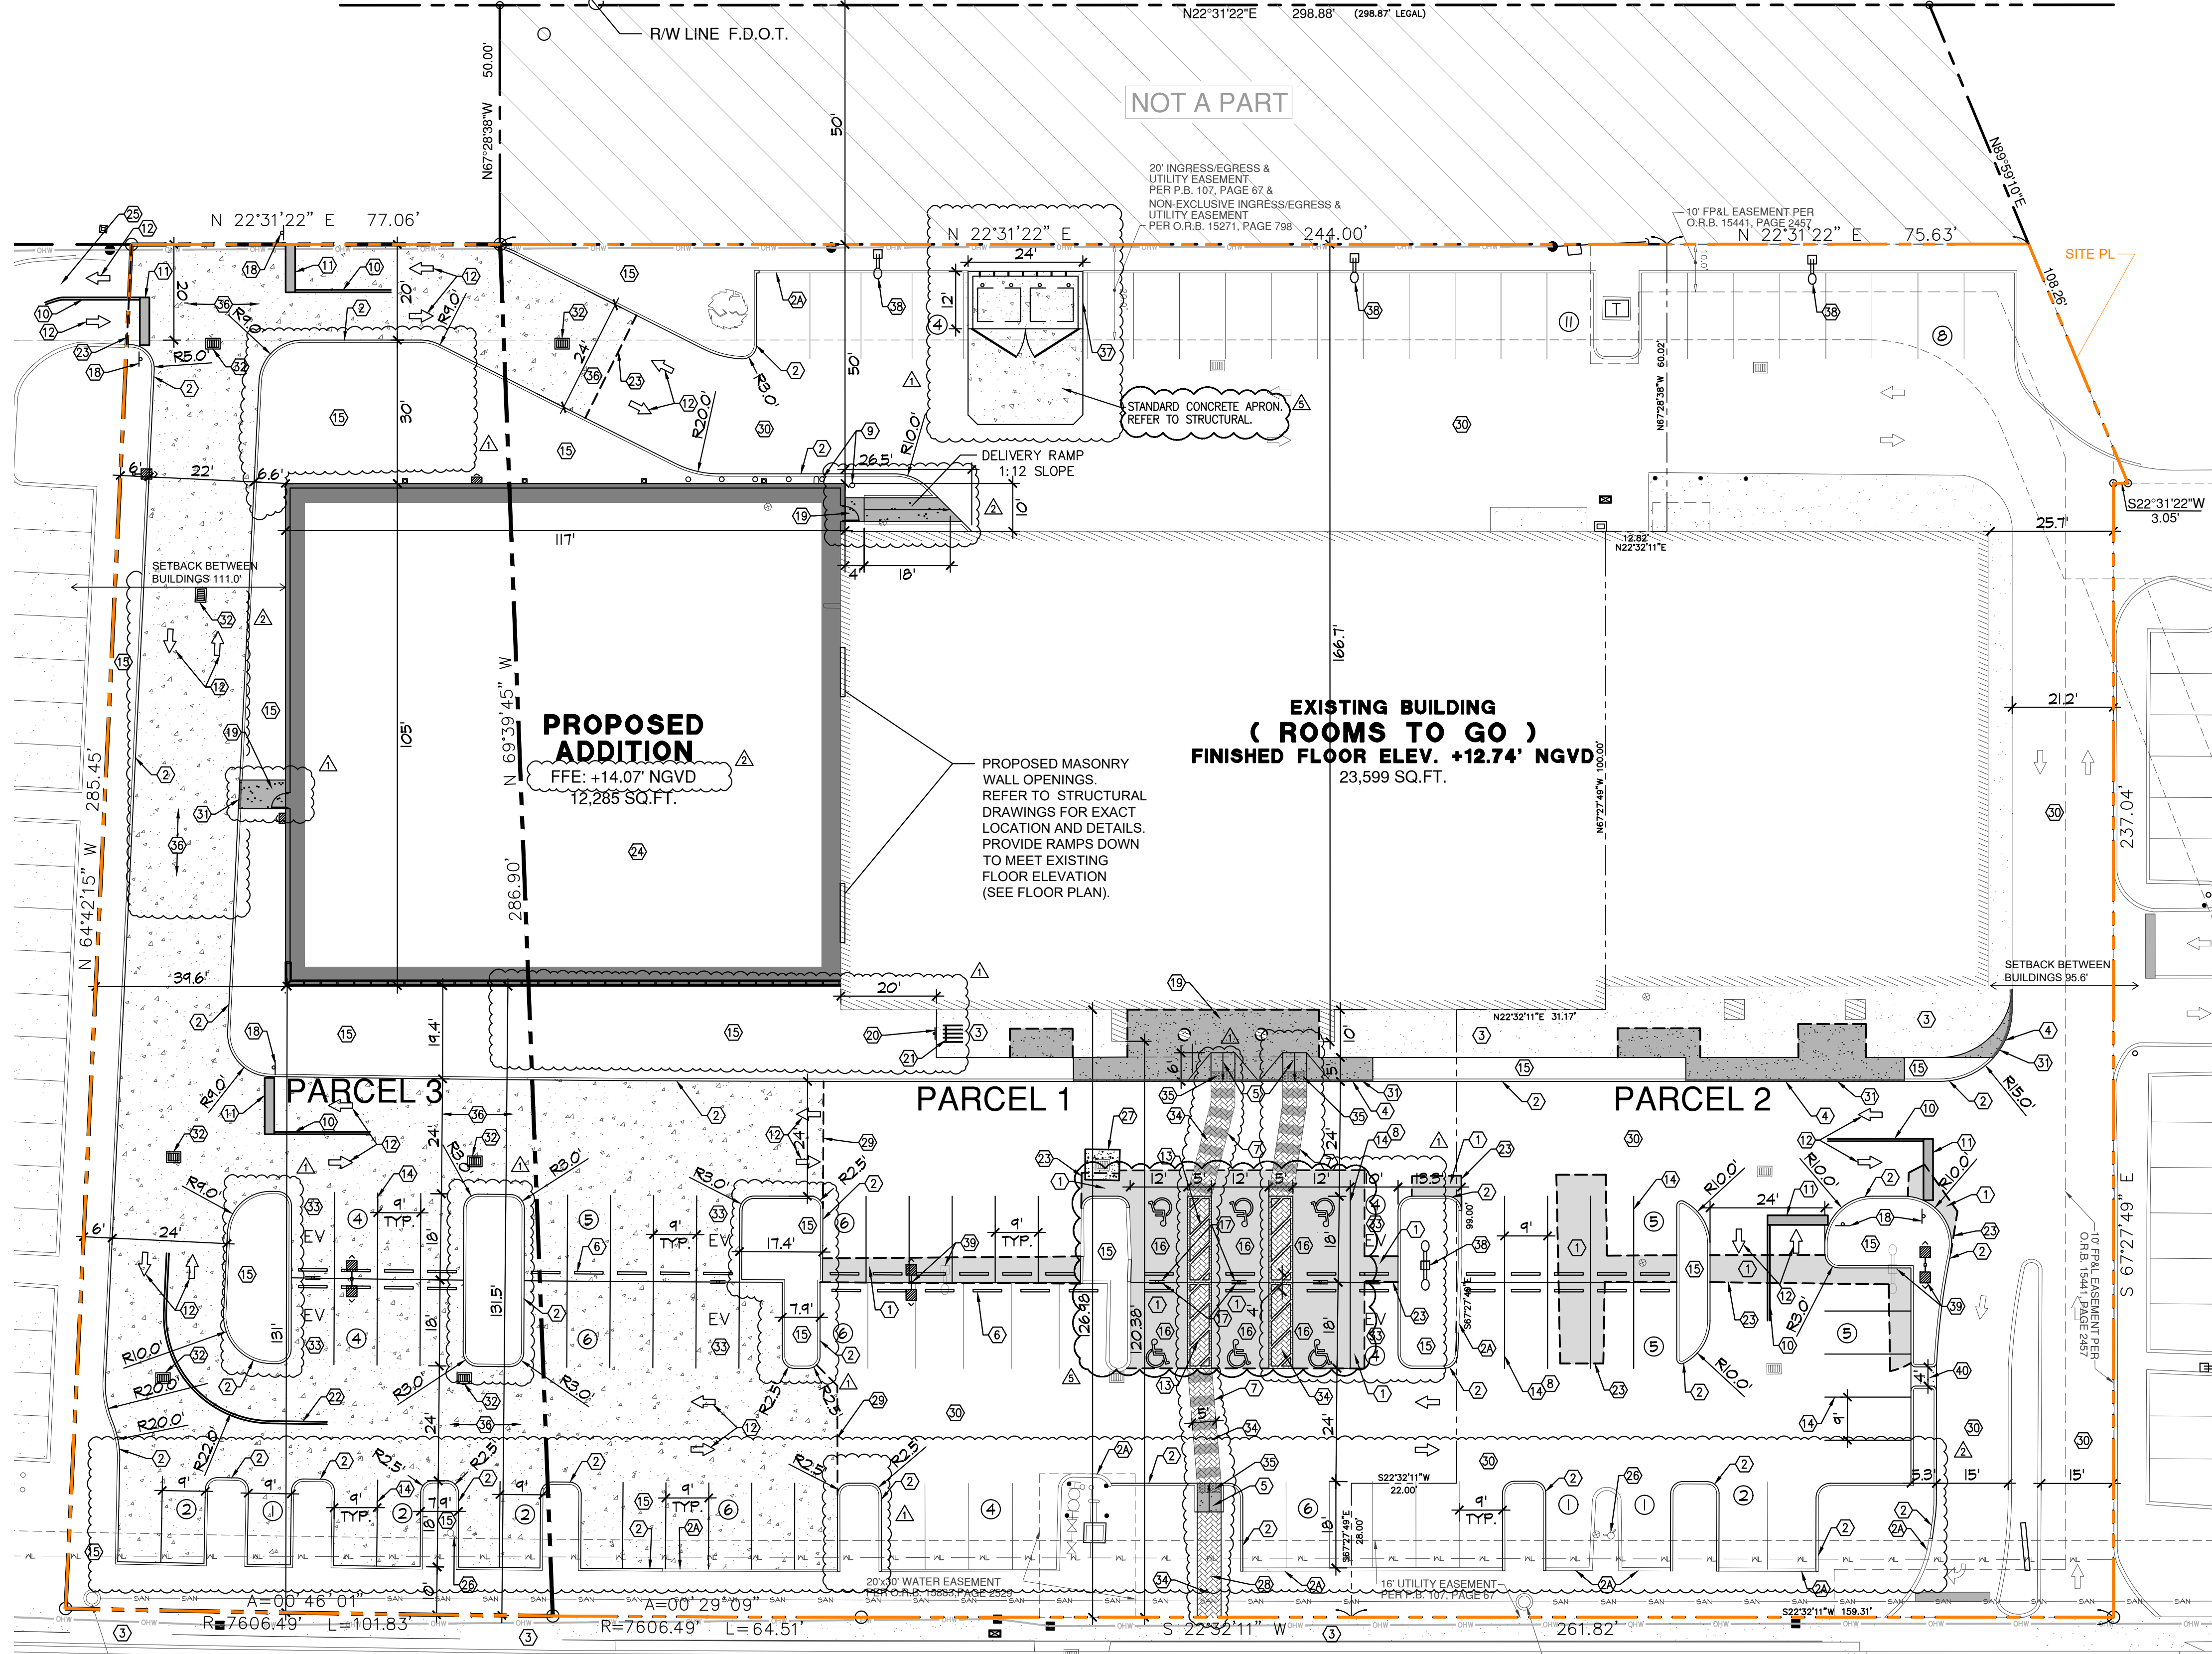

LOCATION MAP
N.T.S.

LEGAL DESCRIPTION:

PARCEL 1: (ORIGINAL LEASE - ROOMS TO GO FURNITURE SHOWROOM); All of Lot 4 and portions of Lots 1, 2 and 3 of Block 6 of POINT WEST FOURTH ADDITION, according to the Plat thereof recorded in Plat Book 107, Page 67 of the Public Records of Miami-Dade County, Florida, being particularly described as follows:
Beginning at the Southeast corner of said Lot 4; thence N69°39'45"W along the Southwesterly line of said Lot 4 for 286.90 feet to the Southwest corner of said Lot 4; thence N22°31'22"E along the Northwesterly line of said POINT WEST FOURTH ADDITION for 244.00 feet; thence S67°28'38"E for 60.02 feet; thence S22°32'11"W for 12.82 feet; thence S67°27'49"E for 100.00 feet; thence S22°32'11"W for 31.17 feet; thence S67°27'49"E for 99.00 feet; thence S22°32'11"W for 22.00 feet; thence S67°27'49"E for 28.00 feet to a point on the Southeastery line of said POINT WEST FOURTH ADDITION; thence run the following courses and distances along the said Southeastery line of POINT WEST FOURTH ADDITION: S22°32'11"W for 102.50 feet to a point of curvature of a circular curve to the right; thence to the right along-said curve having for its elements a radius of 7606.49 feet and a central angle of 0°29'09" for an arc distance of 64.51 feet to the Point of Beginning.

PARCEL 2: (ADDITIONAL LANDS 8/12/1993 AMENDMENT TO LEASE)
A portion of 1, 2 and 3 of Block 6 of POINT WEST FOURTH ADDITION, according to the Plat thereof recorded in Plat Book 107, Page 67 of the Public Records of Miami-Dade County, Florida; and a portion of Lot 10 of POINT WEST SEVENTH ADDITION, according to the Plat thereof recorded in Plat Book 116, at Page 56 of the Public Records of Miami-Dade County, Florida; AND a portion of Tract 12 of PERRINE GRANT SUBDIVISION of Section 5, Township 56 South, Range 40 East, according to the Plat thereof recorded in Plat Book 1, at Page 4 of the Public Records of Miami-Dade County, Florida, ALL being particularly described as follows:
Beginning at the Southwest corner of Lot 4 of Block 6 of said POINT WEST FOURTH ADDITION; thence N67°28'38"W for 50.00 feet to a point on the Southeastery Right-of-Way line of the Florida Department of Transportation Limited Access Corridor; thence N22°31'22"E along the said Southeastery Right-of-Way line of the Florida Department of Transportation Limited Access Corridor for 298.87 feet; thence N89°59'10"E for 54.13 feet to a point on the boundary line of said Lot 10 of Block 6; thence continue N89°59'10"E along the said boundary line of Lot 10 for 54.13 feet; thence S22°31'22"W for 3.05 feet; thence S67°27'49"E for 237.04 feet to a point on the Southeastery line of said Lot 1 of Block 6; thence S22°31'22"W along the Southeastery lines of said Lots 1, 2 and 3 of Block 6 of 159.31 feet; thence N67°27'49"W for 28.00 feet; thence N22°32'11"E for 22.00 feet; thence N67°27'49"W for 99.00 feet; thence N22°32'11"E for 31.17 feet; thence N67°27'49"W for 100.00 feet; thence N22°32'11"E for 12.82 feet; thence N67°28'38"W for 60.02 feet to a point on the Northwesterly line of said Lot 1 of Block 6; thence S22°31'22"W along the Northwesterly lines of said Lots 1, 2, 3 and 4 of Block 6 for 244.00 feet to the Point of Beginning, LESS AND EXCEPT THEREFROM those lands included in the right-of-way of the State of Florida, Florida Department of Transportation Limited Access Corridor.

PARCEL 3: (TROPICAL FINANCIAL CREDIT UNION LAND TO BE ADDED TO LEASE)
Lot 5, Block 6, POINT WEST FOURTH ADDITION, according to the Plat thereof recorded in Plat Book 107, page 67, of the Public Records of Miami-Dade County, Florida.


(S.R. No. 5 AND U.S. No. 1) DIXIE HWY. SITE GEOMETRY PLAN

GENERAL SITE NOTES

- ALL PAVEMENT MARKINGS AND SIGNAGE ARE TO COMPLY WITH CUTLER BAY PUBLIC WORKS DEP. STANDARDS/MUTCOD.
- ALL RADII AND DIMENSIONS ARE TO FACE OF CURB UNLESS OTHERWISE NOTED.
- ALL CURB RETURN RADII SHALL BE 3', AS SHOWN TYPICAL ON THIS PLAN, UNLESS OTHERWISE NOTED.
- UNLESS OTHERWISE SHOWN, CALLED OUT OR SPECIFIED HEREON OR WITHIN THE SPECIFICATIONS: ALL CURBING ADJACENT TO CONCRETE PAVING SHALL BE INSTALLED PER DETAIL. PAVEMENT SHALL BE INSTALLED IN ACCORDANCE WITH PAVING PLAN. ALL PARKING LOT STRIPING INCLUDING ACCESSIBLE AND VAN ACCESSIBLE SPACES SHALL BE PAINTED PER DETAIL (SEE SHEET C-4).
- ALL ACCESSIBLE PARKING STALLS SHALL HAVE SIGNAGE INSTALLED PER DETAIL (SEE SHEET C-4).
- PARKING SPACES AND ACCESS AISLES SHALL BE LEVEL WITH SURFACE SLOPES NOT TO EXCEED 1:50 (2%) IN ALL DIRECTIONS.

SITE PLAN LEGEND

	TRANSFORMER BOX ON PAD		NEW CONCRETE SIDEWALK
	NUMBER OF PARKING SPACES		NEW PAVERS
	ACCESSIBLE PARKING SPACES		NEW STANDARD ASPHALT (REFER TO DETAIL)
	PROPERTY LINE		NEW CONCRETE PAVEMENT (REFER TO DETAIL)
	EXISTING COLUMNS		EXISTING BUILDING (NOT A PART)
	EXISTING PAVEMENT TO BE TO BE REPAIRED AS NEEDED, SEAL COAT & RESTRIPE.		

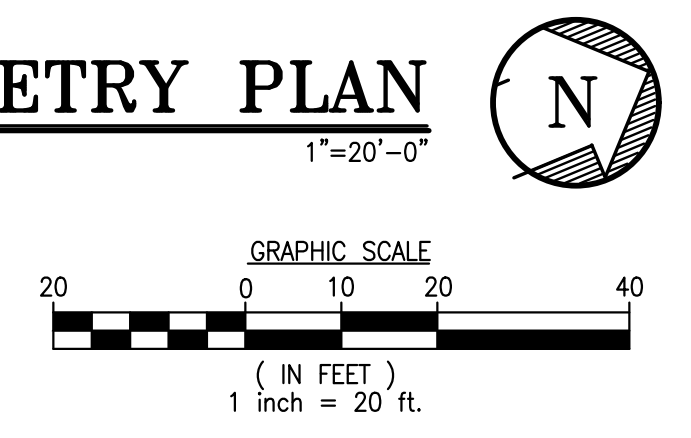

CONSTRUCTION NOTES:

1 NEW ASPHALT PAVEMENT AS PER DETAIL 1/C-4.	20 'BICYCLE PARKING' SIGN-SEE DET. 20/C-4
2 NEW 6" P.C.C. TYPE 'D' CURB AS PER DETAIL 2/C-4	21 BICYCLE RACK BY HUNTCO-MODEL BR-7 OR APPROVED EQUAL, FINISH: POWDER COATED PAINT (SEE DET. 21/C-4)
3 EXISTING 6" P.C.C. TYPE 'D' CURB TO REMAIN.	22 6" DOUBLE YELLOW LINES IN CURVE.
4 EXISTING CONC. SIDEWALK.	23 SAWCUT EXISTING ASPHALT-NEW PAVEMENT TO BE COMPATIBLE.
5 P.C.C. CONCRETE CURB EDGE SIDEWALK AS PER DETAIL	24 ALL ROOF MOUNTED EQUIPMENT AND ACCESSORIES SHALL BE SCREENED FROM VIEW BY PARAPET.
6 P.C.C. HANDICAP RAMP - MAX SLOPE 1:12.	25 EXISTING DRIVEWAY CONNECTION TO ADJACENT CITY FURNITURE.
7 6" CONCRETE WHEEL STOP (TYP.). SEE SPECS. IN SEC. 02526 (DET. 6/C-4)	26 EXISTING FIRE HYDRANT
8 PEDESTRIAN CROSSING STRIPES PER F.D.O.T. INDEX No. 17346 (DET. 7/C-4)	27 REBUILD CONCRETE PAD AROUND CATCH BASIN AS NECESSARY
9 RE-STRIPE PARKING SPACES W/4" DOUBLE WHITE STRIPES (DET. 14/C-4)	28 PAVERS ON 5' CONNECTION W/STREET SIDEWALK.
10 STEEL BOLLARD AS PER DETAIL 9/C-4.	29 SAWCUT EXISTING ASPHALT-NEW CONCRETE PAVEMENT TO BE FLUSH WITH ASPHALT (DET. 29/C-4).
11 20 LF 6" DOUBLE YELLOW	30 SEAL COAT & RE-STRIPE EXISTING ASPHALT PAVEMENT.
12 24" STOP BAR PAINTED WHITE (DET. 11/C-4).	31 PAINT FACE OF CURB AND 6" RETURN/TOP YELLOW WHERE SIDEWALKS ABUT PAVEMENT.
13 TRAFFIC ARROWS PAINTED WHITE (DET. 12/C-4).	32 NEW CATCH BASIN.
14 6" WHITE STRIPES AT 60" (PER FDOT INDEX No. 17346).	33 ELECTRIC VEHICLE PARKING SPACE WITH SIGN (DET. 33/C-4).
15 4" DOUBLE WHITE STRIPES (TYP. AT PARKING SPACES-SEE DET. 14/C-4).	34 PAVERS
16 LANDSCAPE AREA.	35 DETECTABLE WARNING SURFACE (DET. 35/C-4).
17 HANDICAP PARKING AS PER DETAIL 16/C-4.	36 25% MIN. PERVIOUS CONCRETE PAVEMENT--6" THICK W/ 6"x6" -6/6 W.W.F. OVER CRUSHED AGGREGATE OR GRAVEL BASE. MAX. SPACING FOR CONTROL JOINTS 10' O.C. EACH WAY-MIN. SOLAR REFLECTANCE INDEX (SRI)=29.
18 HANDICAP SIGN 7'-0" A.F.F. SEE DETAIL 17/C-4.	37 TRASH & RECYCLE ENCLOSURE REFER TO ARCH. DWGS.
19 STANDARD F.D.O.T. HIGH INTENSITY "STOP" SIGN. R1-1 (36"x36")-DET. 18/C-4.	38 EXISTING PARKING LIGHT TO REMAIN. REFER TO E0.1
20 PROVIDE 5' LANDING AT DOORS, 2% MAX SLOPE IN ALL DIRECTIONS.	39 EXISTING PARKING LIGHT TO BE RELOCATED. REFER TO E0.1
	40 NEW CONCRETE SPILLWAY.

CKE GROUP
INCORPORATED
engineering • architecture • planning
(CERTIFICATE OF AUTHORIZATION - 4486)

18722 S. DIXIE HWY. CUTLER BAY, FLORIDA

ROOMS TO GO



17190 ROYAL PALM BLVD. • SUITE 2 • WESTON, FLORIDA 33326 • (954) 982-7211 - (305) 558-4124

revisions seal

ADD#2: 11-29-23
bid date: 11-09-23
permit:
owner date: 7-6-22

project no: 1789
scale: AS NOTED
date: 7-1-2022
drawn by: AG

C-1.2

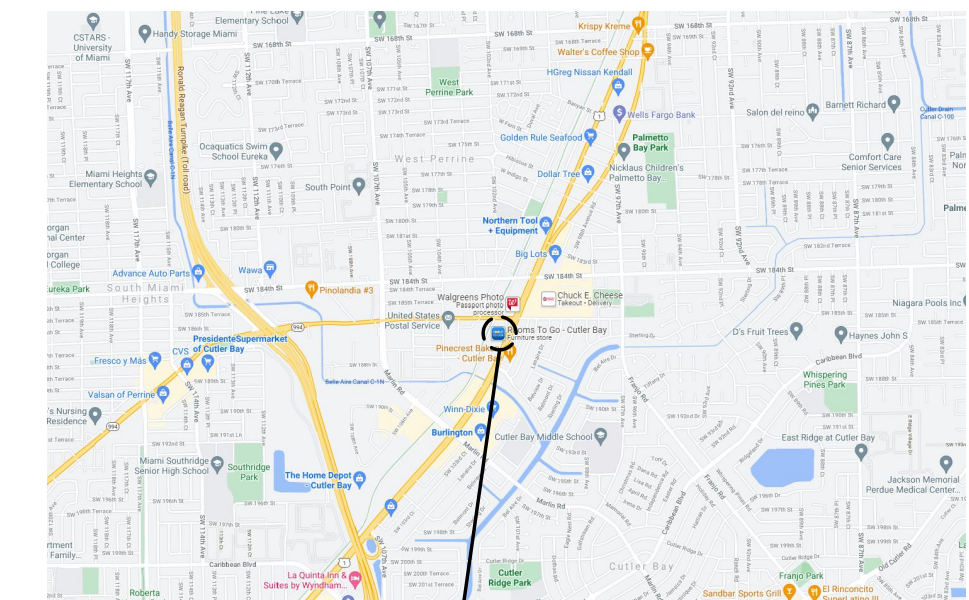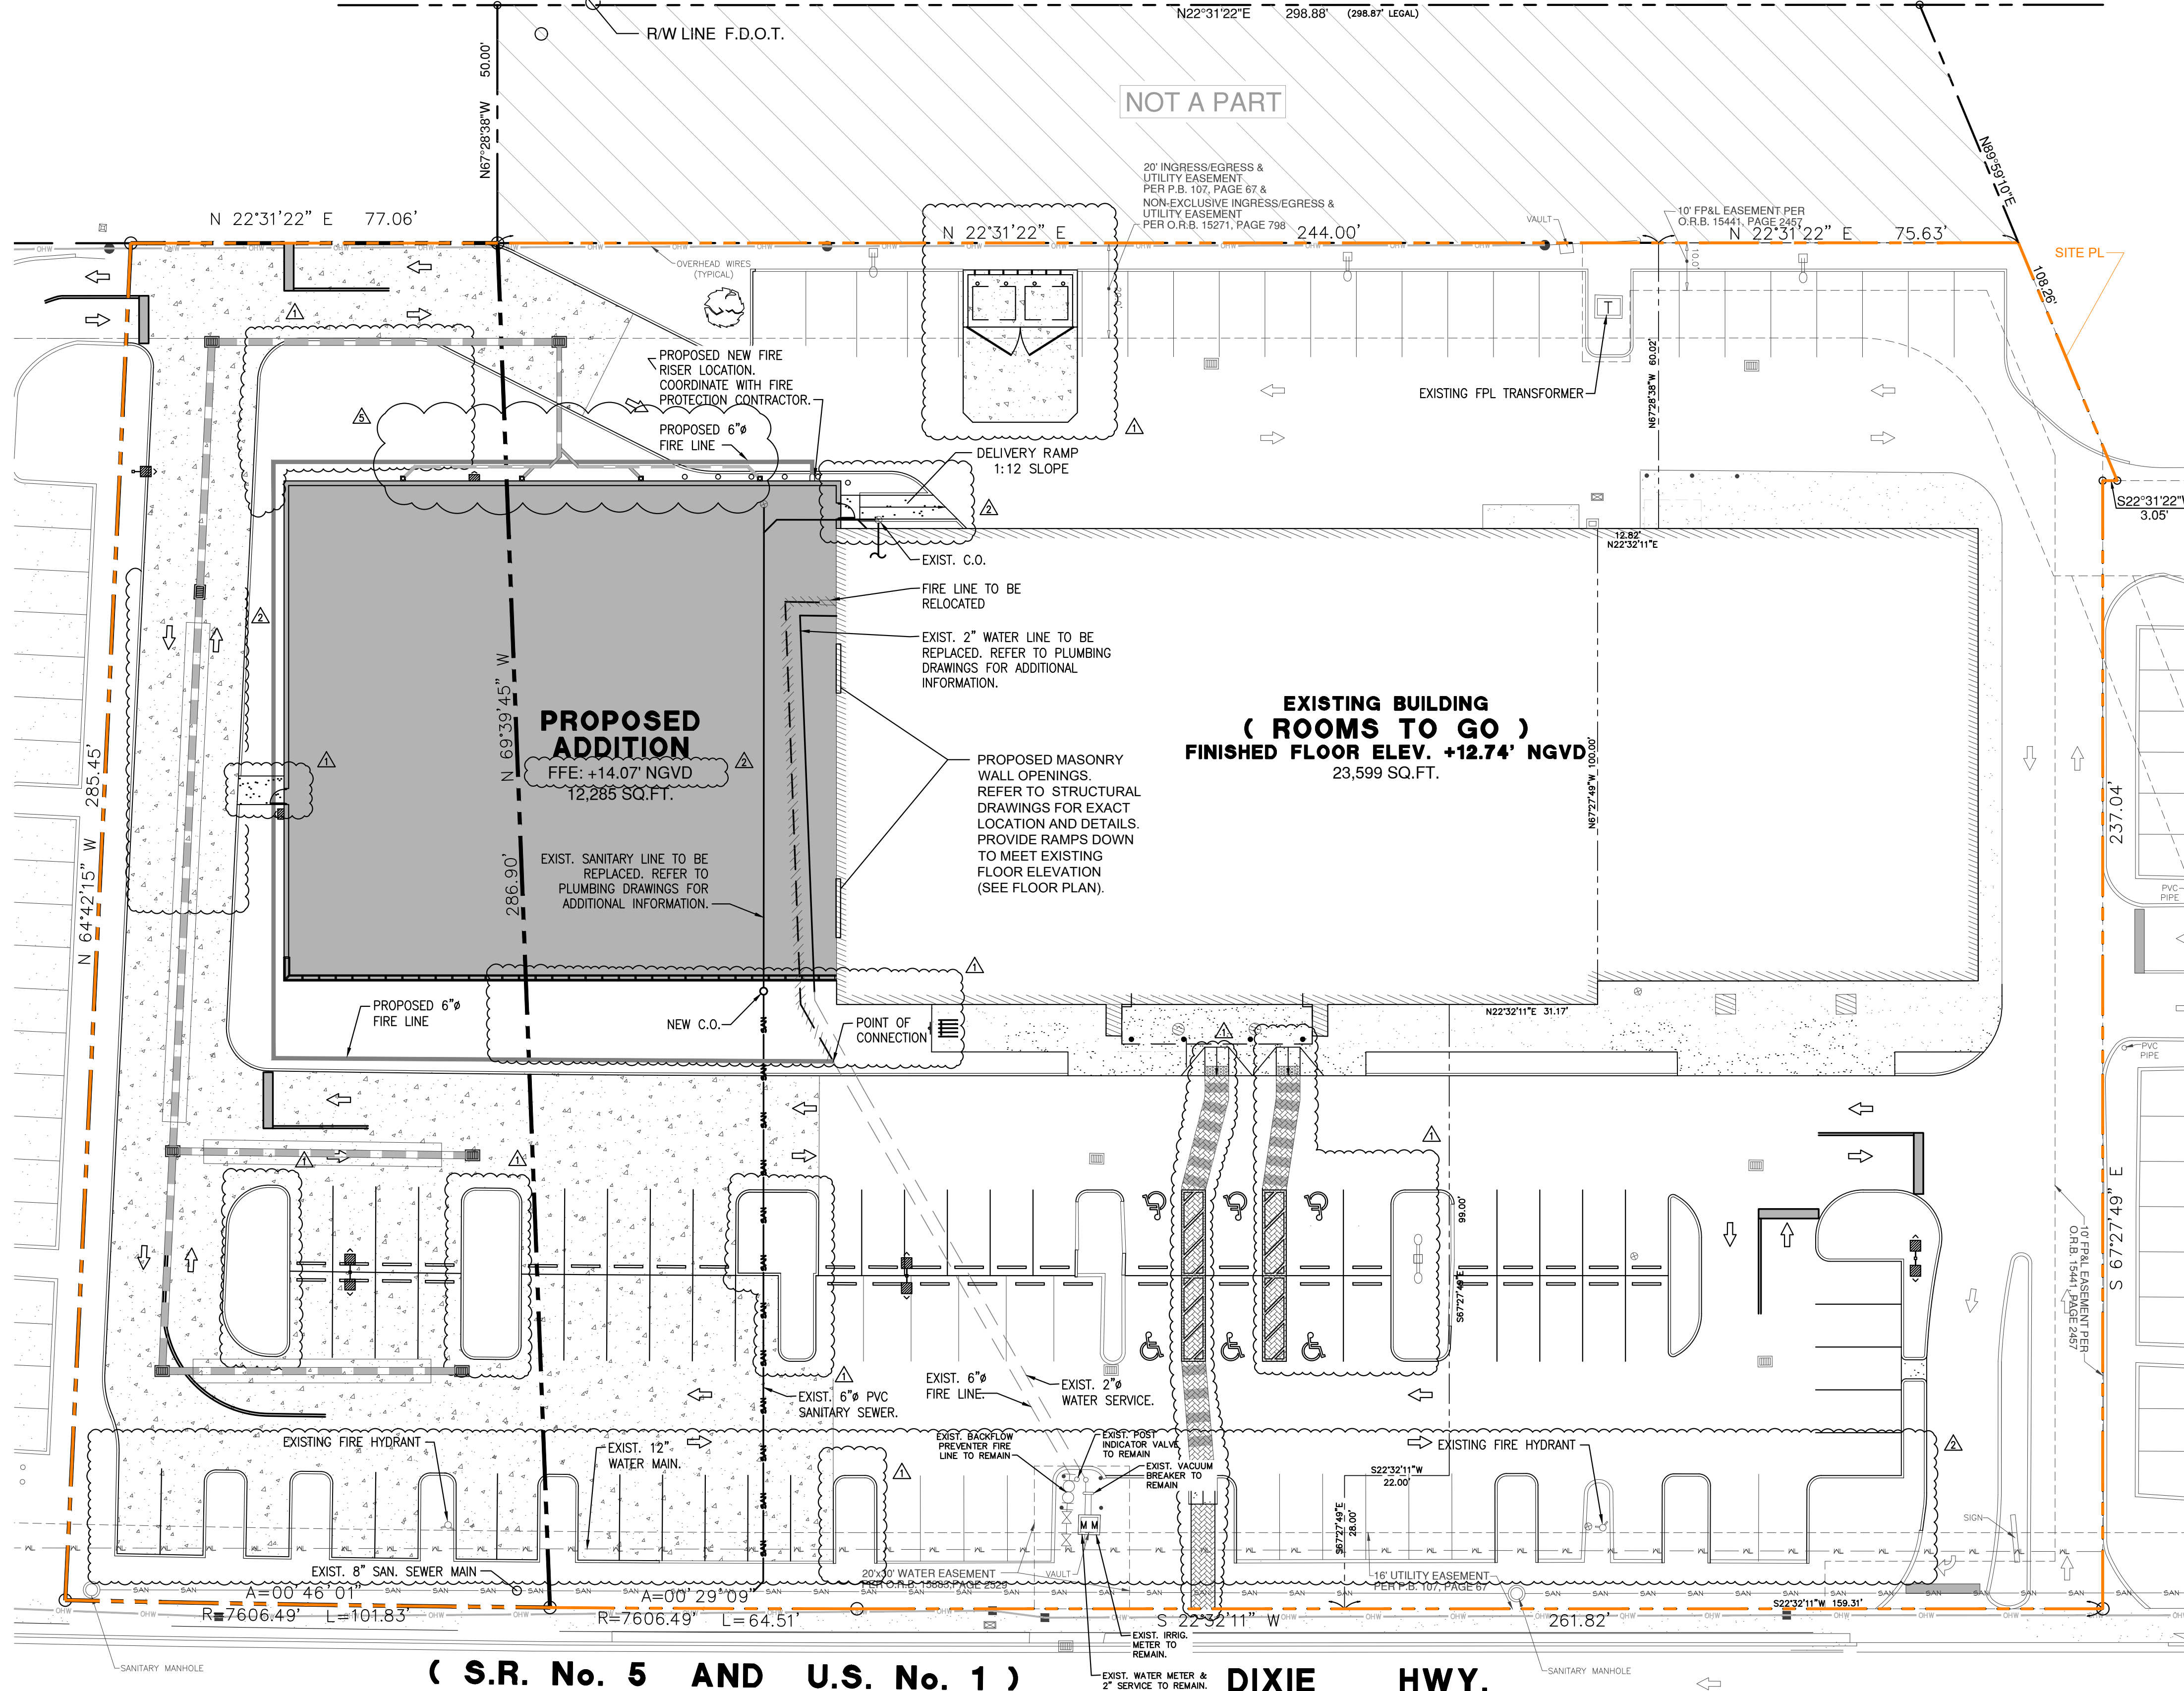

LEGAL DESCRIPTION:


PARCEL 1: (ORIGINAL LEASE - ROOMS TO GO FURNITURE SHOWROOM)
 All of Lot 4 and portions of Lots 1, 2 and 3 of Block 6 of POINT WEST FOURTH ADDITION, according to the Plat thereof recorded in Plat Book 107, Page 67 of the Public Records of Miami-Dade County, Florida, being particularly described as follows:
 Beginning at the Southeast corner of said Lot 4; thence N69°39'45"W along the Southwesterly line of said Lot 4 for 286.90 feet to the Southwest corner of said Lot 4; thence N22°31'22"E along the Northwesterly line of said POINT WEST FOURTH ADDITION for 244.00 feet; thence S67°28'38"E for 60.02 feet; thence S22°32'11"W for 12.82 feet; thence S67°27'49"E for 100.00 feet; thence S22°32'11"W for 31.17 feet; thence S67°27'49"E for 99.00 feet; thence S22°32'11"W for 22.00 feet; thence S67°27'49"E for 28.00 feet to a point on the Southeastery line of said POINT WEST FOURTH ADDITION; thence run the following courses and distances along the said Southeastery line of POINT WEST FOURTH ADDITION: S22°32'11"W for 102.50 feet to a point of curvature of a circular curve to the right; thence to the right along-said curve having for its elements a radius of 7606.49 feet and a central angle of 0°29'09" for an arc distance of 64.51 feet to the Point of Beginning.

PARCEL 2: (ADDITIONAL LANDS 8/12/1993 AMENDMENT TO LEASE)
 A portion of 1, 2 and 3 of Block 6 of POINT WEST FOURTH ADDITION, according to the Plat thereof recorded in Plat Book 107, at Page 67 of the Public Records of Miami-Dade County, Florida; a portion of Lot 10 of Block 6 of POINT WEST SEVENTH ADDITION, according to the Plat thereof recorded in Plat Book 116, at Page 56 of the Public Records of Miami-Dade County, Florida; AND a portion of Tract 12 of PERRINE GRANT SUBDIVISION of Section 5, Township 56 South, Range 40 East, according to the Plat thereof recorded in Plat Book 1, at Page 4 of the Public Records of Miami-Dade County, Florida, ALL being particularly described as follows:
 Beginning at the Southwest corner of Lot 4 of Block 6 of said POINT WEST FOURTH ADDITION; thence N67°28'38"W for 50.00 feet to a point on the Southeastery Right-of-Way line of the Florida Department of Transportation Limited Access Corridor; thence N22°31'22"E along the said Southeastery Right-of-Way line of the Florida Department of Transportation Limited Access Corridor for 298.87 feet; thence N89°59'10"E for 54.13 feet to a point on the boundary line of said Lot 10 of Block 6; thence continue N89°59'10"E along the said boundary line of Lot 10 for 54.13 feet; thence S22°31'22"W for 3.05 feet; thence S67°27'49"E for 237.04 feet to a point on the Southeastery line of said Lot 1 of Block 6; thence S22°32'11"W along the Southeastery lines of said Lots 1, 2 and 3 of Block 6 of 159.31 feet; thence N67°27'49"W for 28.00 feet; thence N22°32'11"E for 22.00 feet; thence N67°27'49"W for 99.00 feet; thence N22°32'11"E for 31.17 feet; thence N67°27'49"W for 100.00 feet; thence N22°32'11"E for 12.82 feet; thence N67°28'38"W for 60.02 feet to a point on the Northwesterly line of said Lot 1 of Block 6; thence S22°31'22"W along the Northwesterly lines of said Lots 1, 2, 3 and 4 and of Block 6 for 244.00 feet to the Point of Beginning, LESS AND EXCEPT THEREFROM those lands included in the right-of-way of the State of Florida, Florida Department of Transportation Limited Access Corridor.

PARCEL 3: (TROPICAL FINANCIAL CREDIT UNION LAND TO BE ADDED TO LEASE)
 Lot 5, Block 6, POINT WEST FOURTH ADDITION, according to the Plat thereof recorded in Plat Book 107, page 67, of the Public Records of Miami-Dade County, Florida.


(S.R. No. 5 AND U.S. No. 1) DIXIE HWY.

UTILITY PLAN
1"=20'-0"

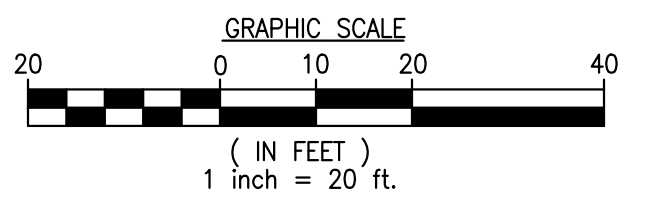


Know what's below.
Call before you dig.

- NOTES:**
- ALL HYDRANTS TO FALL WITHIN 2 FEET OF CURB, STEAMER CONNECTION TO FACE ROADWAY.
 - WATER SHALL BE AVAILABLE TO ALL HYDRANTS PRIOR TO START OF CONSTRUCTION.
 - LANDSCAPING SHALL NOT OBSCURE FIRE HYDRANT NOR SPRINKLER / STANDPIPE WYES.
 - BUILDING ADDRESS SHALL BE CLEARLY VISIBLE FROM ROADWAY.
 - ON-SITE SANITARY SEWER LATERAL TO BE PRIVATELY MAINTAINED.
 - CONTRACTOR TO VERIFY INVERTS AND EXACT LOCATION OF UTILITIES PRIOR TO COMMENCING WITH WORK.
 - CONTRACTOR TO PROVIDE CLEANOUTS AT EACH CHANGE OF DIRECTION OF SEWER LINE AND AT INTERVALS NOT TO EXCEED 70 FT.
 - NO SOLVENT WELD SHALL BE USED.
 - REFER TO THE CITY OF CUTLER BAY STANDARD DETAILS FOR ADDITIONAL DETAILS.

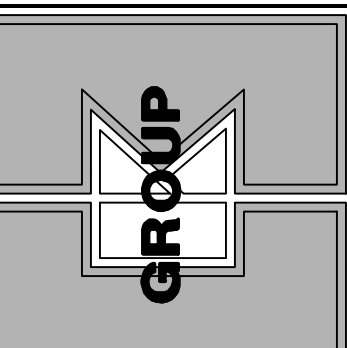

CKE GROUP
INCORPORATED
engineering • architecture • planning
CERTIFICATE OF AUTHORIZATION - 4488

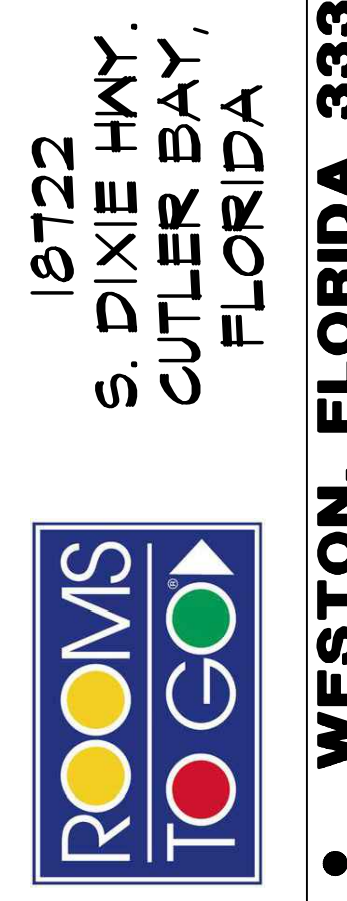








15722 S. DIXIE HWY.
CUTLER BAY, FLORIDA

1/29/2023 BID
03/13/2023 CITY COMMENTS
01/27/2023 CITY COMMENTS
revisions seal

ADD#2: 11-29-23
bid date: 11-09-23
permit:
owner date: 7-6-22
project no: 1789
scale: AS NOTED
date: 7-1-2022
drawn by: AG




17190 ROYAL PALM BLVD. • SUITE 2 • WESTON, FLORIDA 33326

C-3

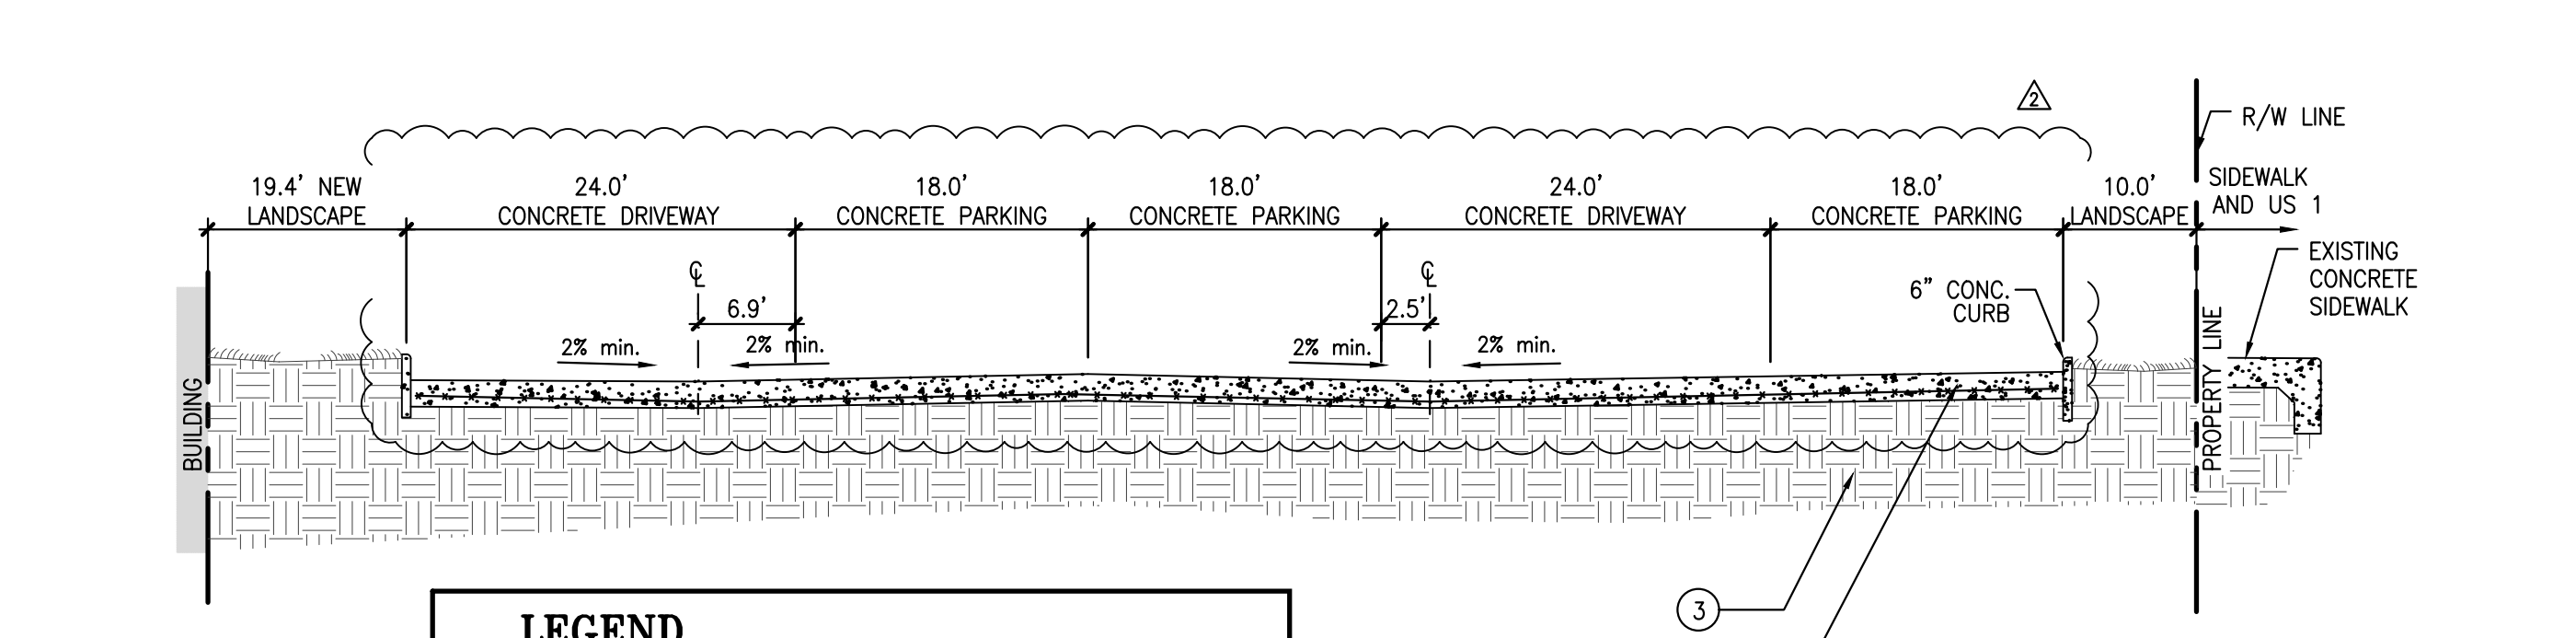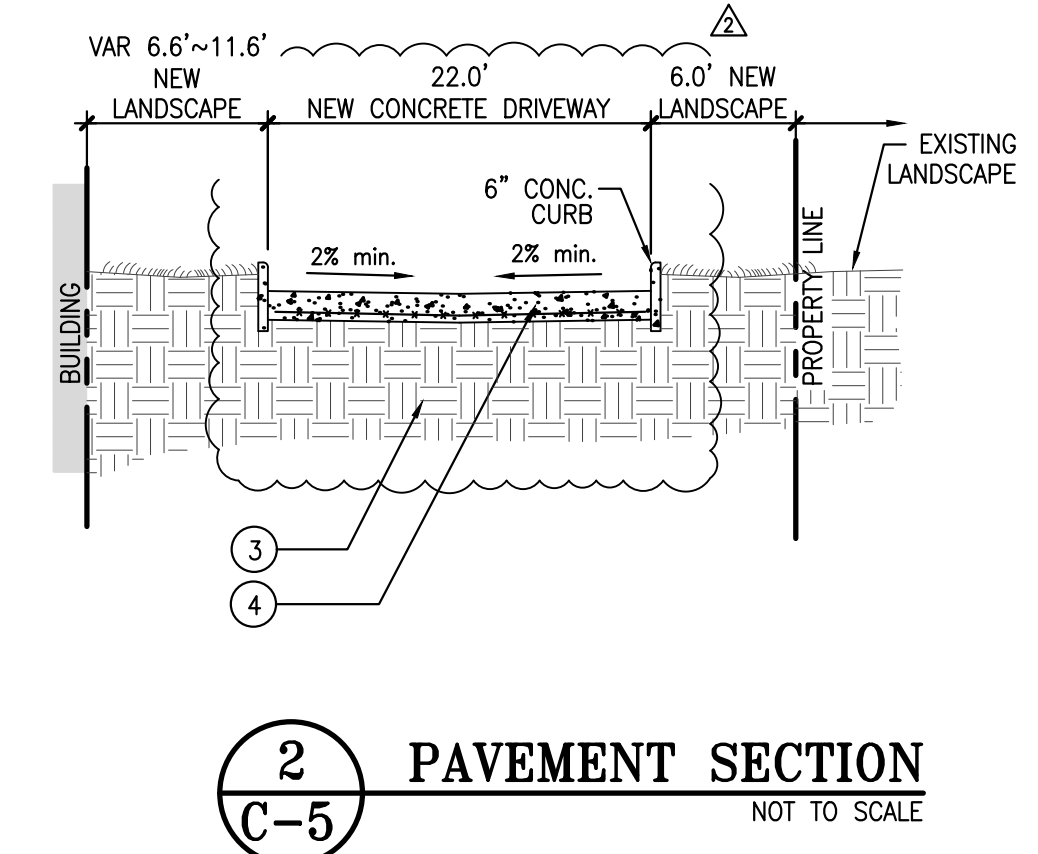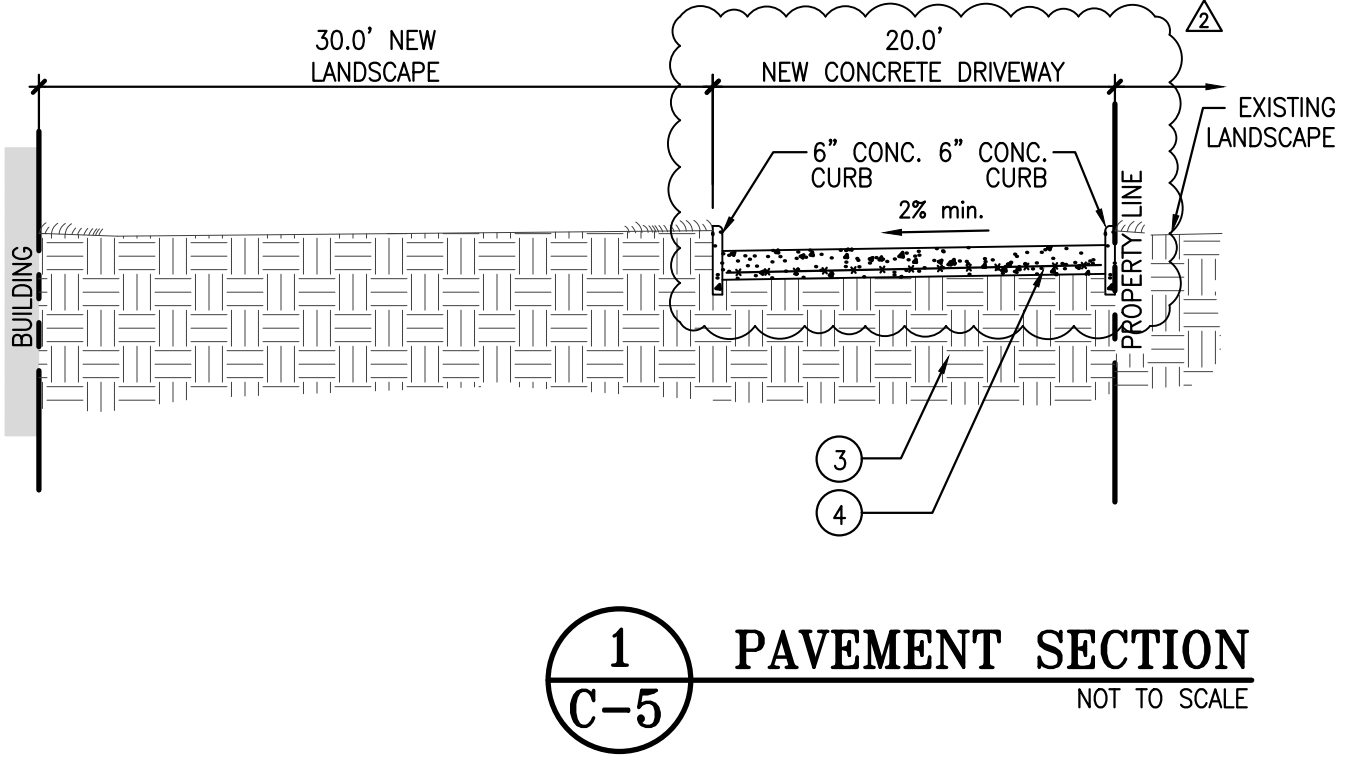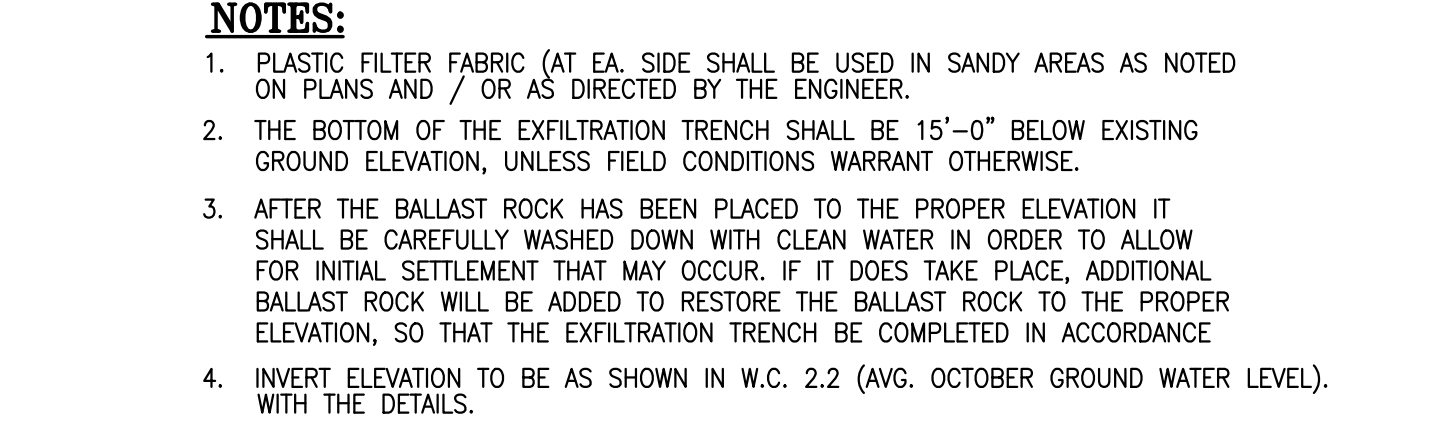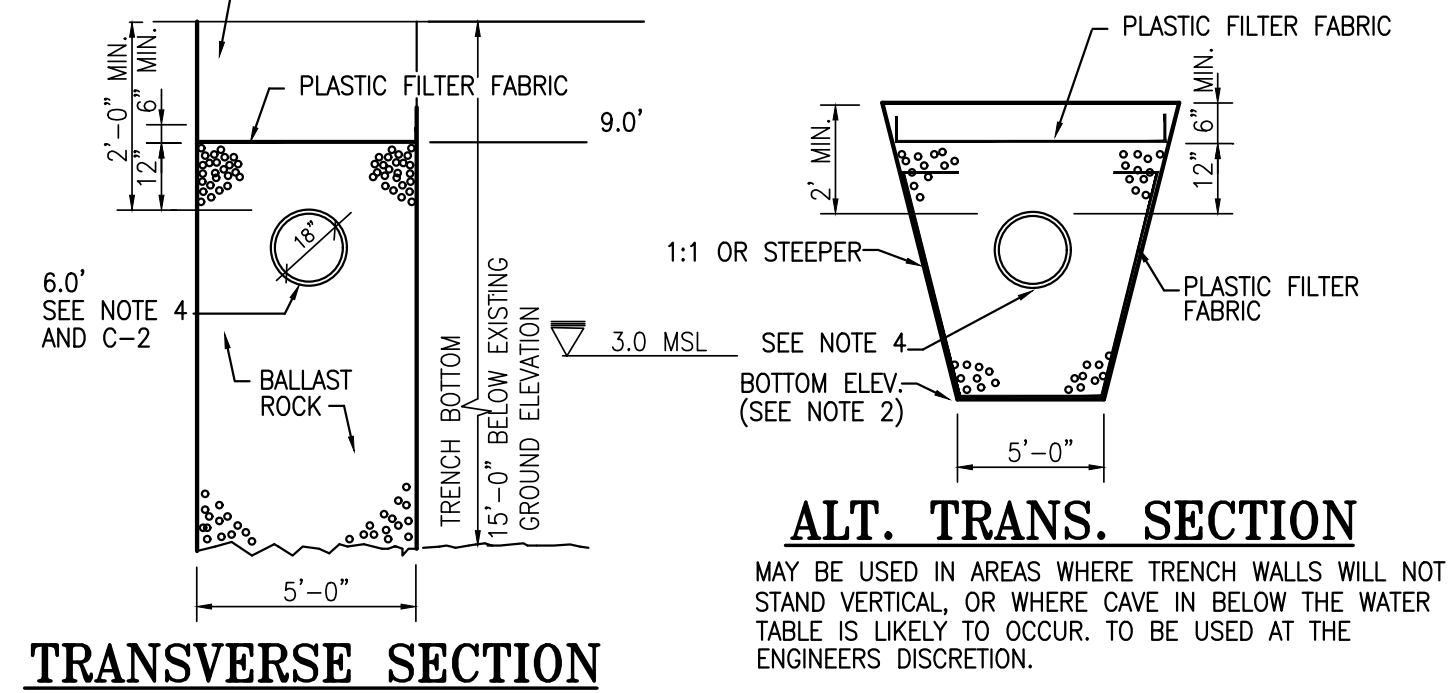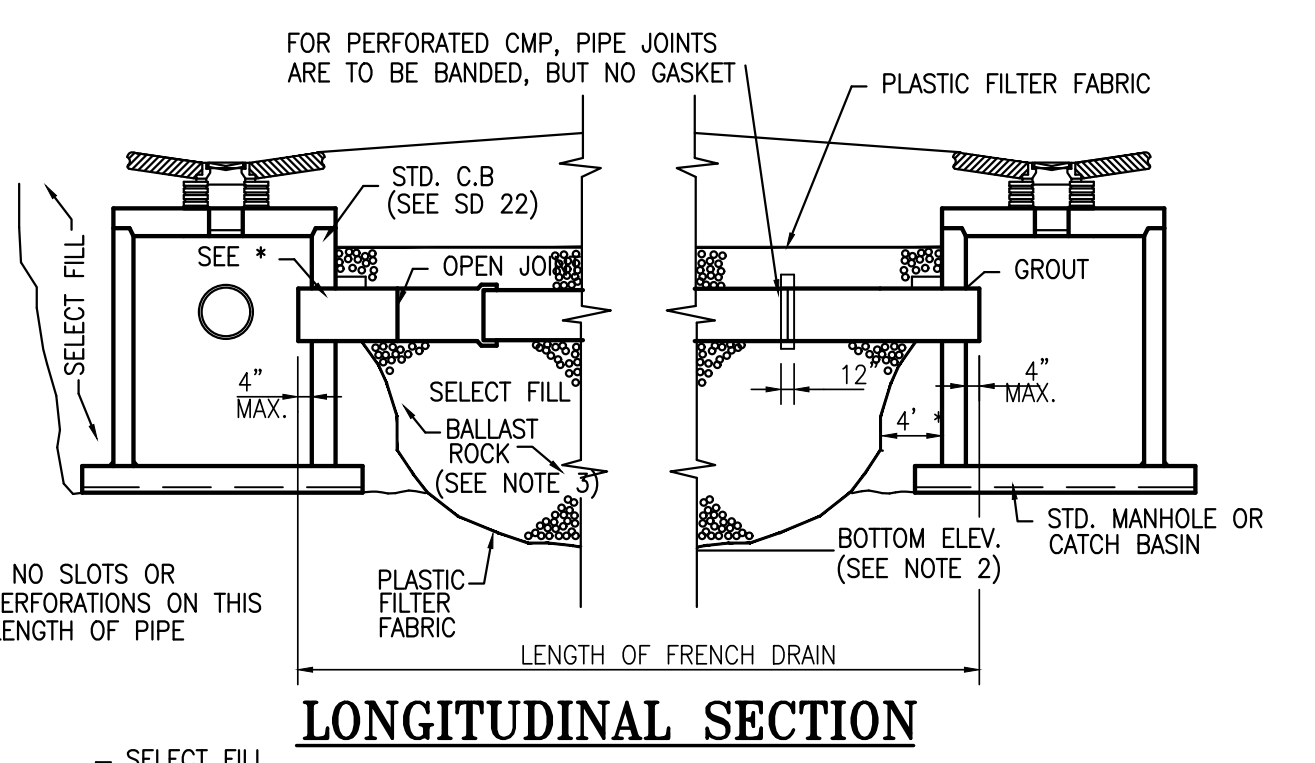
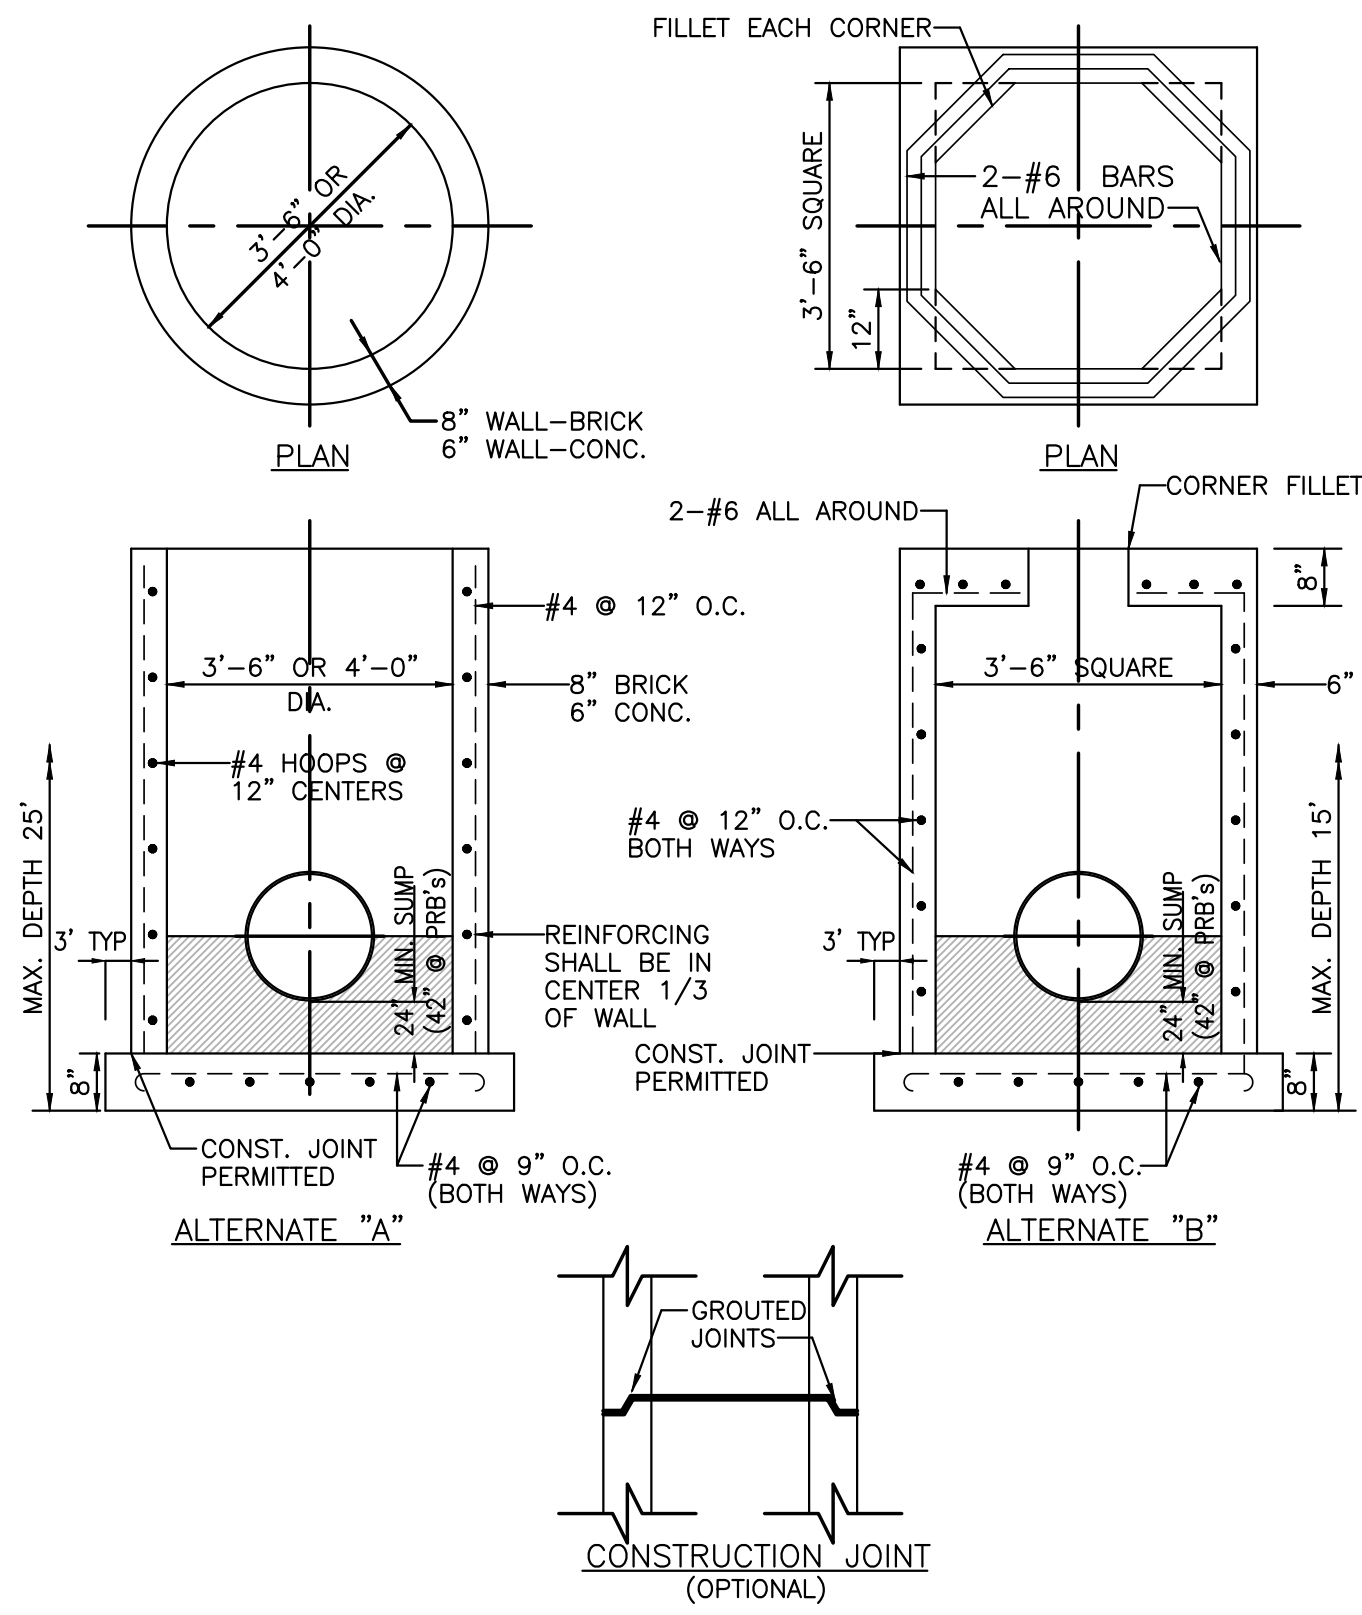


LEGEND

- 2" MIN. TYPE SP 9.5 OR SP-12.5 ASPHALTIC CONCRETE APPLIED IN 2-1" LIFTS, PER FDOT SPECIFICATIONS, GEOTECHNICAL REPORT AND PROJECT SPECIFICATIONS. COMPACT TO MINIMUM 95% LABORATORY MARSHALL DENSITY. SECOND LIFT TO BE APPLIED NO EARLIER THAN AFTER ALL LANDSCAPE INSTALLATION HAS BEEN INSPECTED AND APPROVED.
- 8" LIMEROCK BASE - MIN LBR=100 COMPACTION: 98% OF THE MODIFIED PROCTOR (ASTM D 1557) MIN CARBONATE CONTENT = 70%. REFER TO GEOTECHNICAL REPORT AND PROJECT SPECIFICATIONS.
- 12" SUBGRADE - MIN LBR=40 COMPACTION: 98% OF THE MODIFIED PROCTOR (ASTM D 1557). REFER TO GEOTECHNICAL REPORT AND PROJECT SPECIFICATIONS.
- 25% MIN. PERVIOUS CONCRETE PAVEMENT-6" THICK W/ 6"x6" -5/8 W.W.F. OVER CRUSHED AGGREGATE OR GRAVEL BASE. MAX. SPACING FOR CONTROL JOINTS 10' O.C. EACH WAY-MIN. SOLAR REFLECTANCE INDEX (SRI)=29 (DET. 36/C-4).

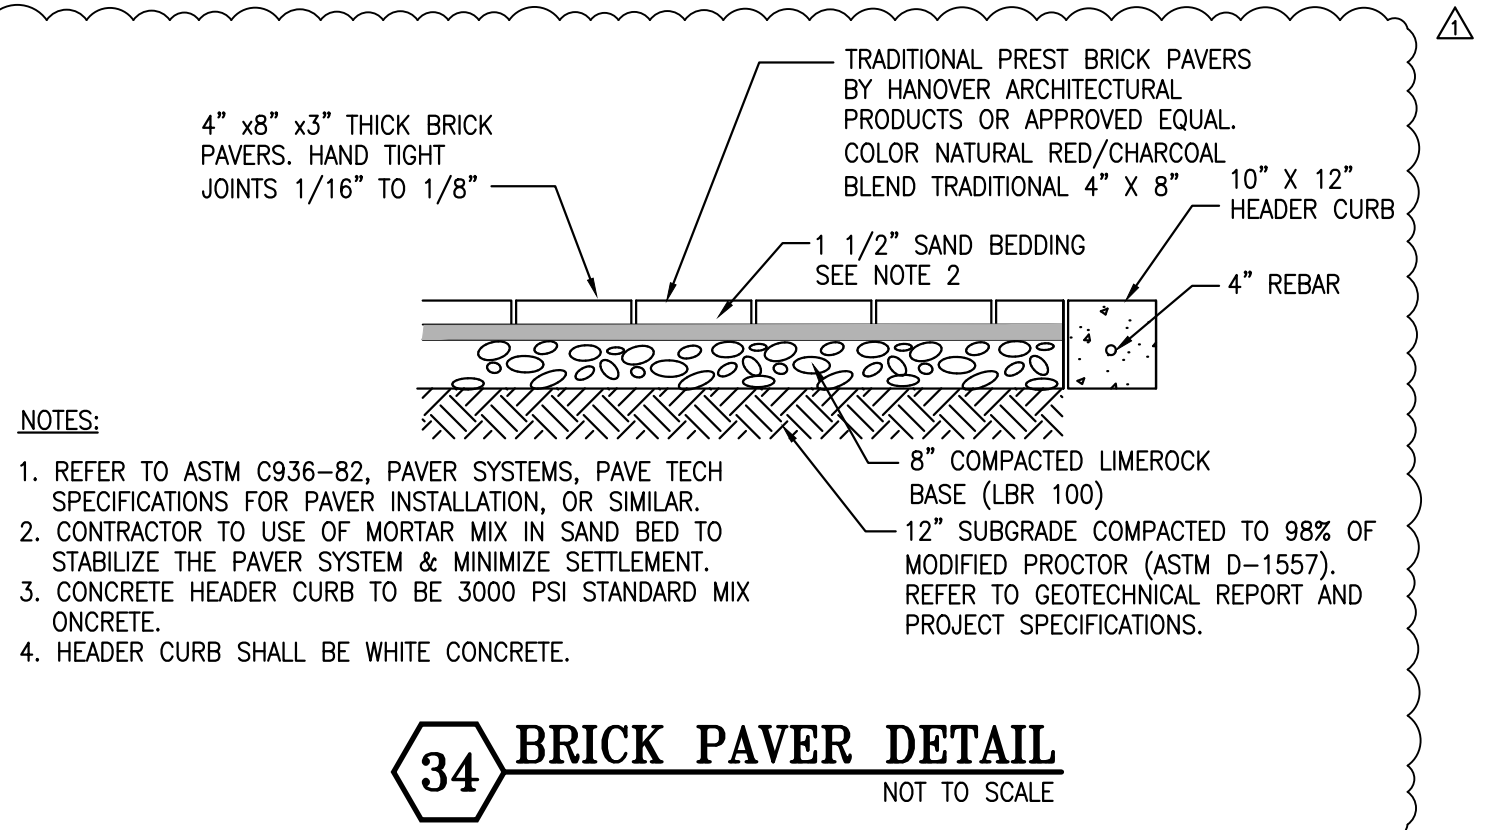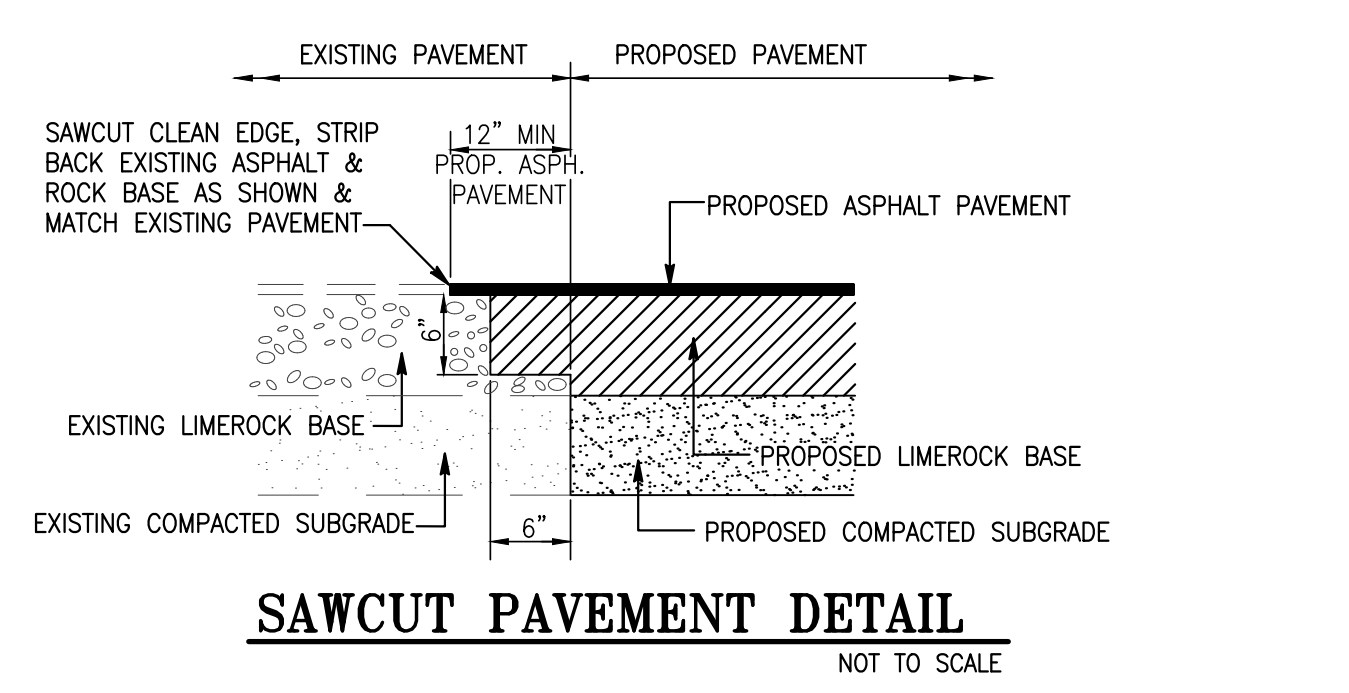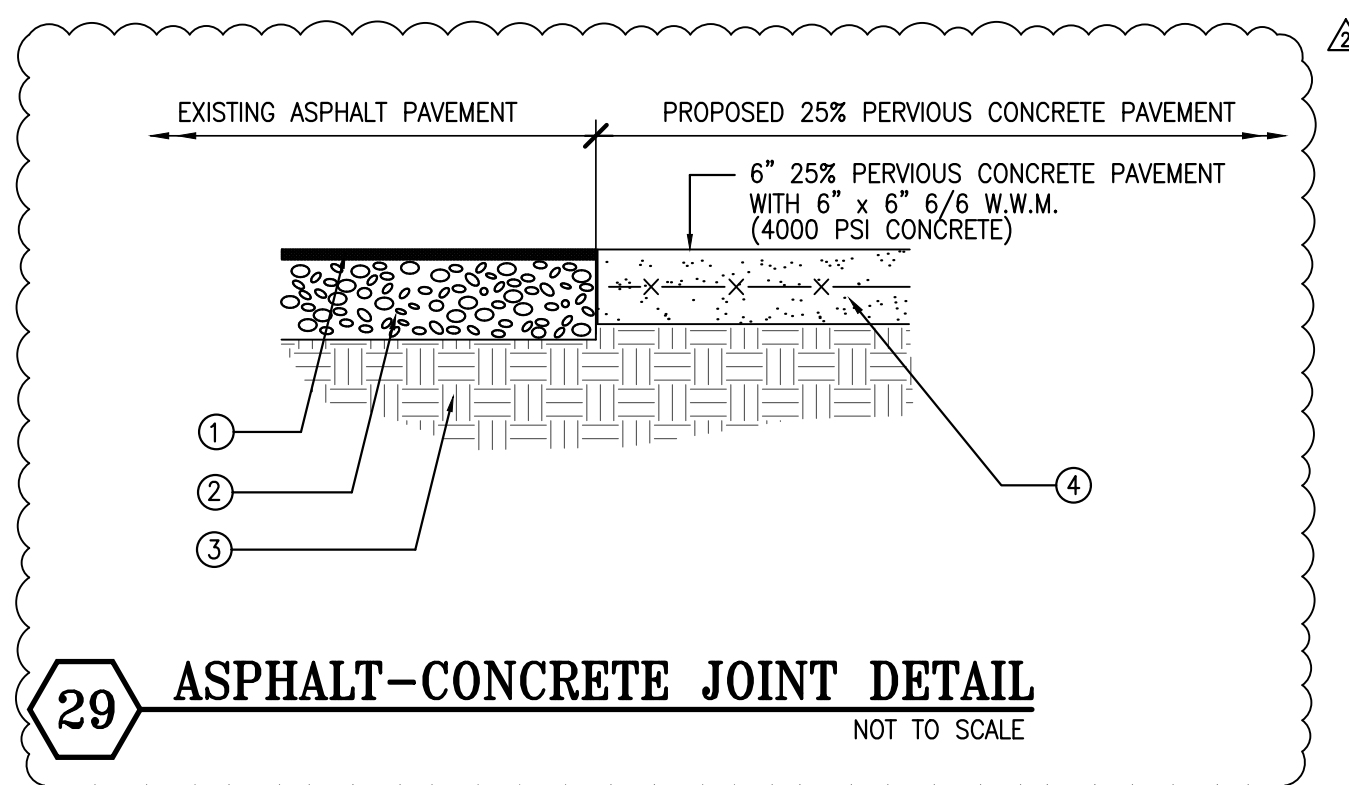

INLET, MANHOLE & JUNCTION BOX (TYPE 'P')
NOT TO SCALE

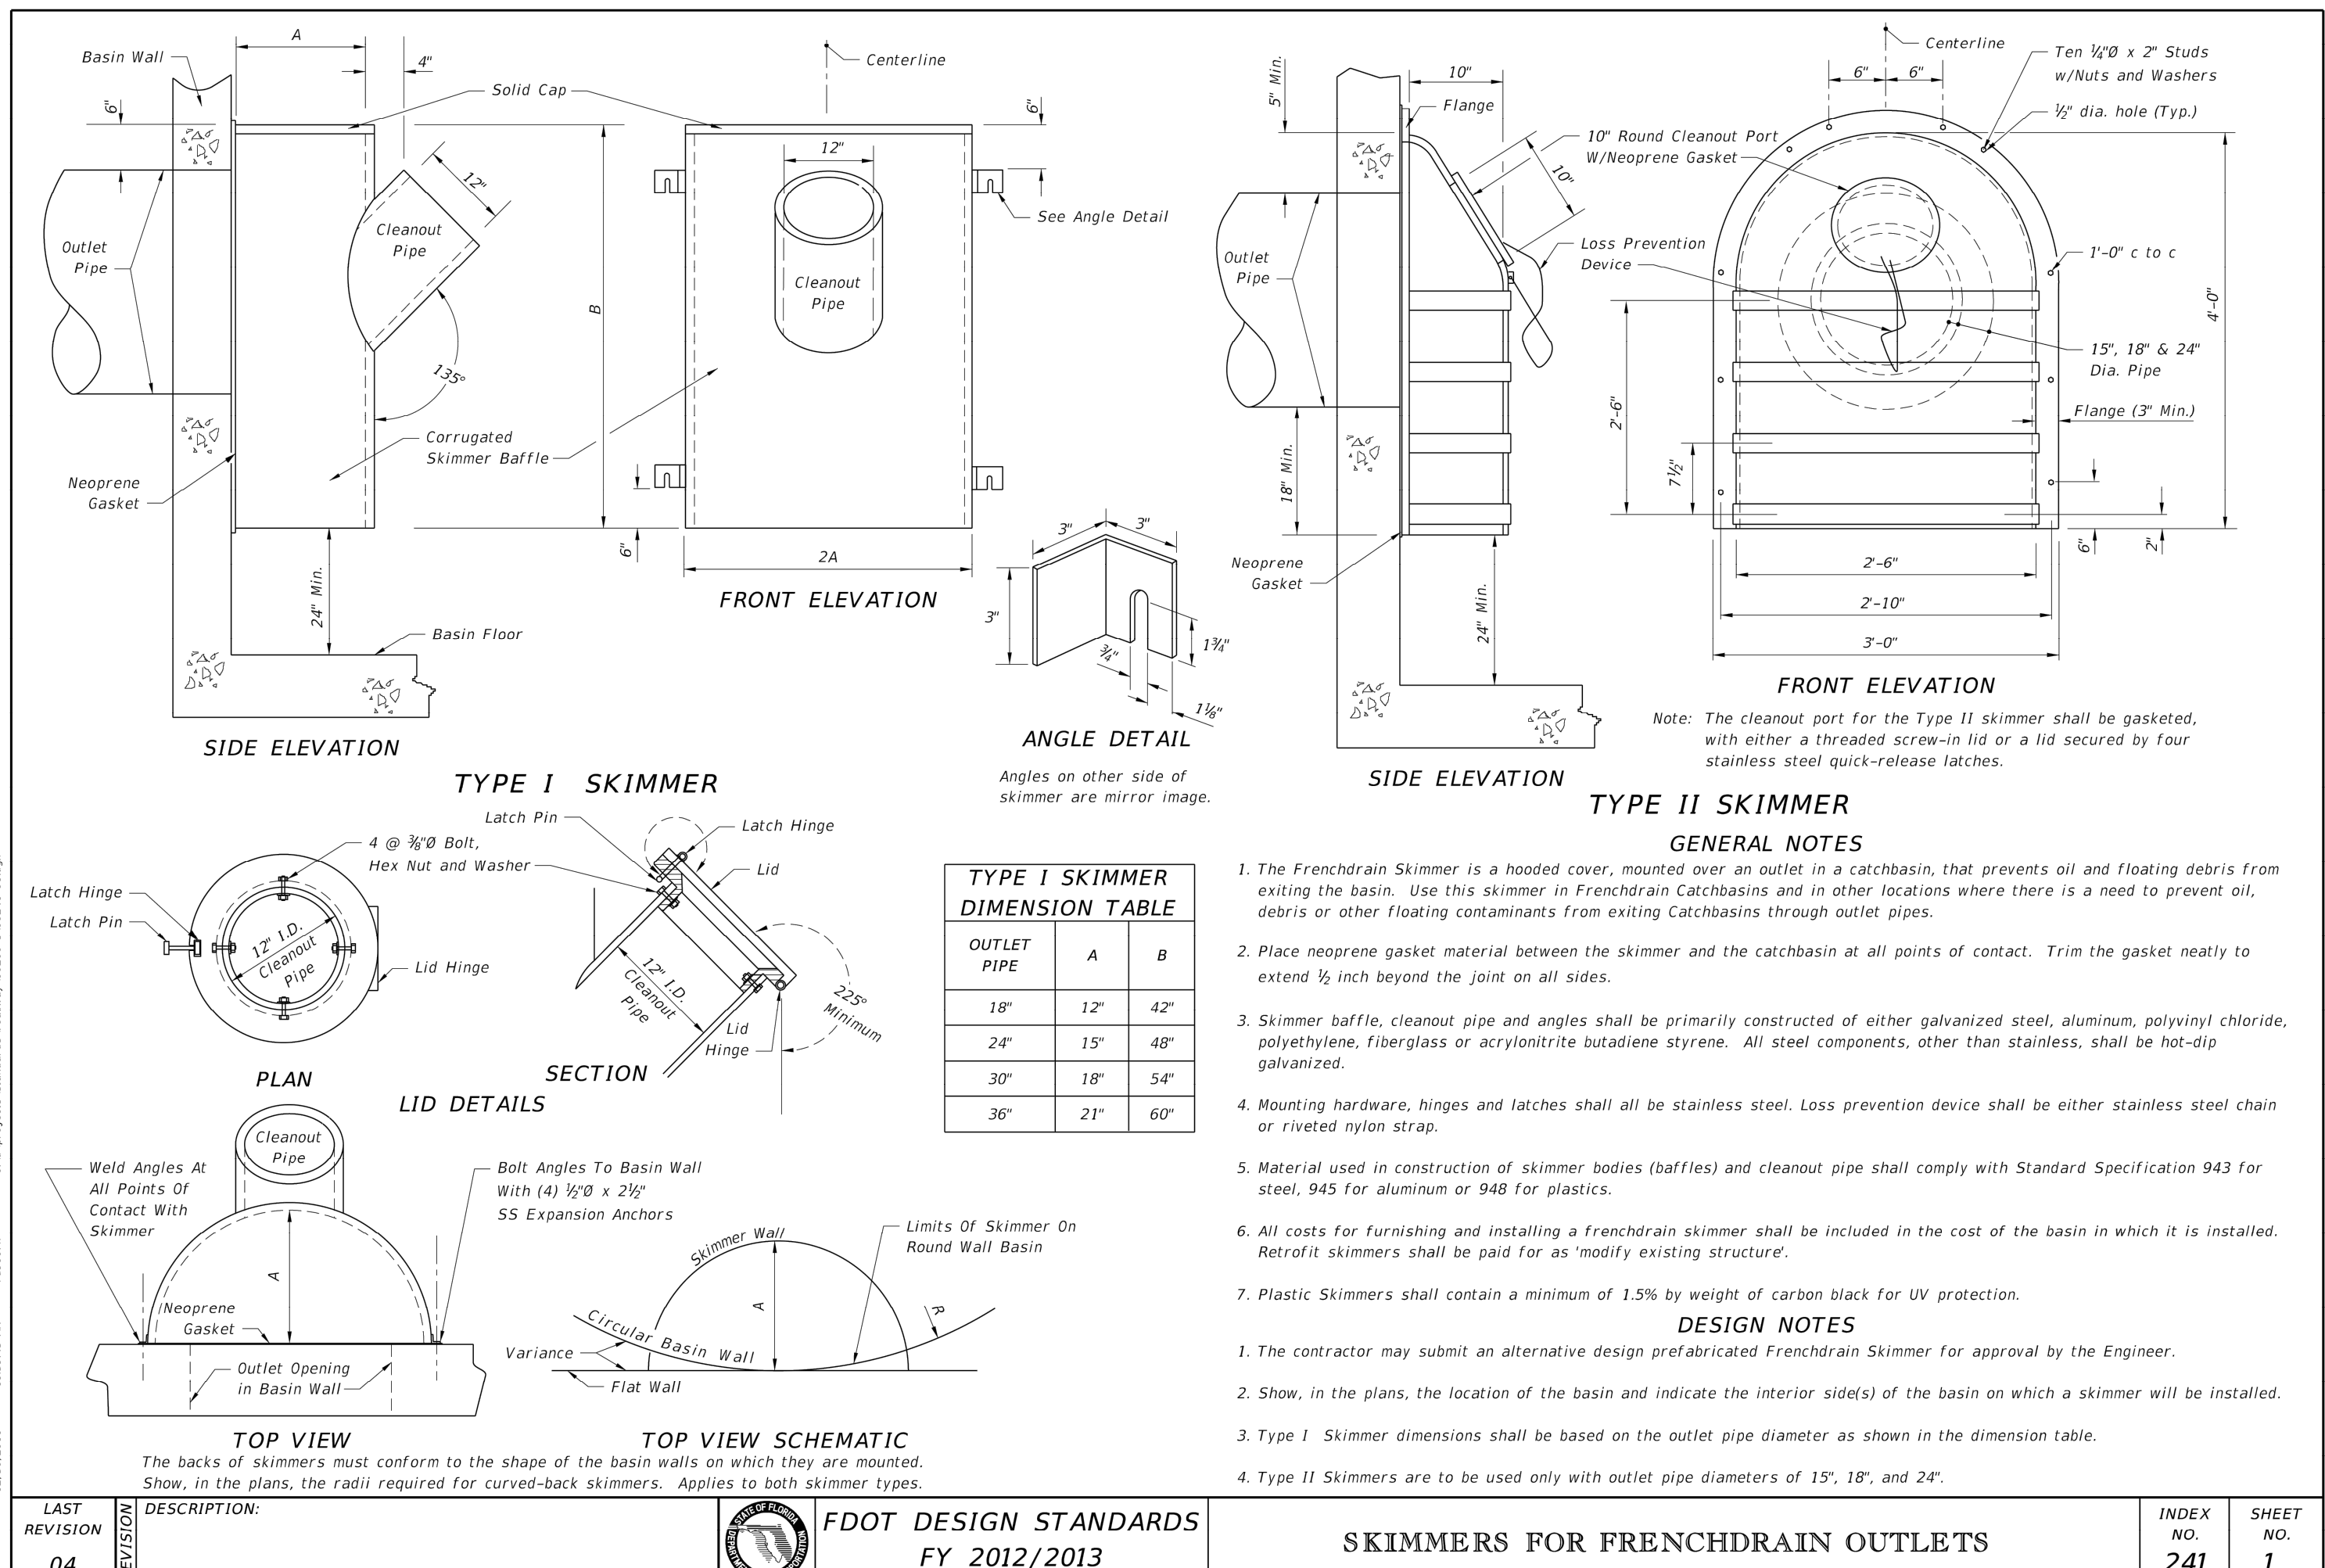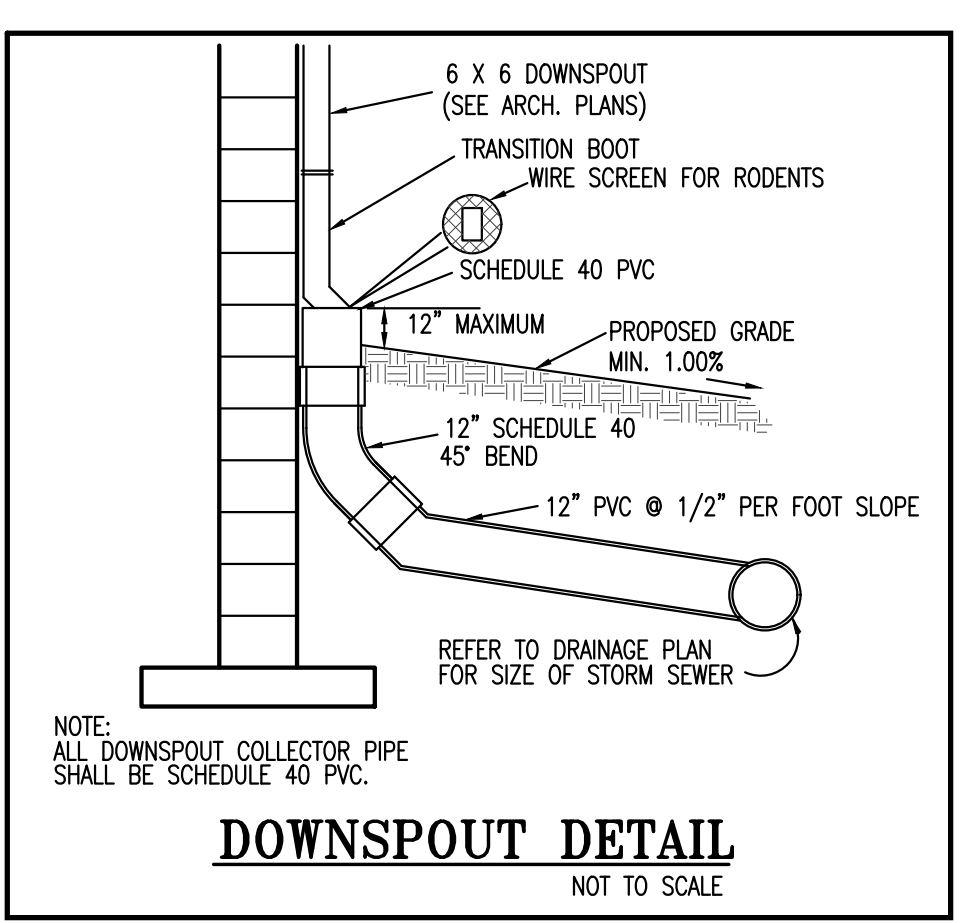

LAST REVISION	DESCRIPTION:	FDOT DESIGN STANDARDS FY 2012/2013	INDEX NO.	SHEET NO.
04			241	1

CKE GROUP
INCORPORATED
engineering • architecture • planning
(CERTIFICATE OF AUTHORIZATION - 4432)

18722 S. DIXIE HWY. CUTLER BAY, FLORIDA

17190 ROYAL PALM BLVD. • SUITE 2 • WESTON, FLORIDA 33326 • (954) 982-7211 • (305) 558-4124


11/29/2023 BID
11/02/2023 CITY COMMENTS
03/13/2023 CITY COMMENTS
01/27/2023 CITY COMMENTS

revisions seal


ADD#2: 11-29-23
bid date: 11-09-23
permit:
owner date: 7-6-22

project no: 1789
scale: AS NOTED
date: 7-1-2022
drawn by: AG


C-5

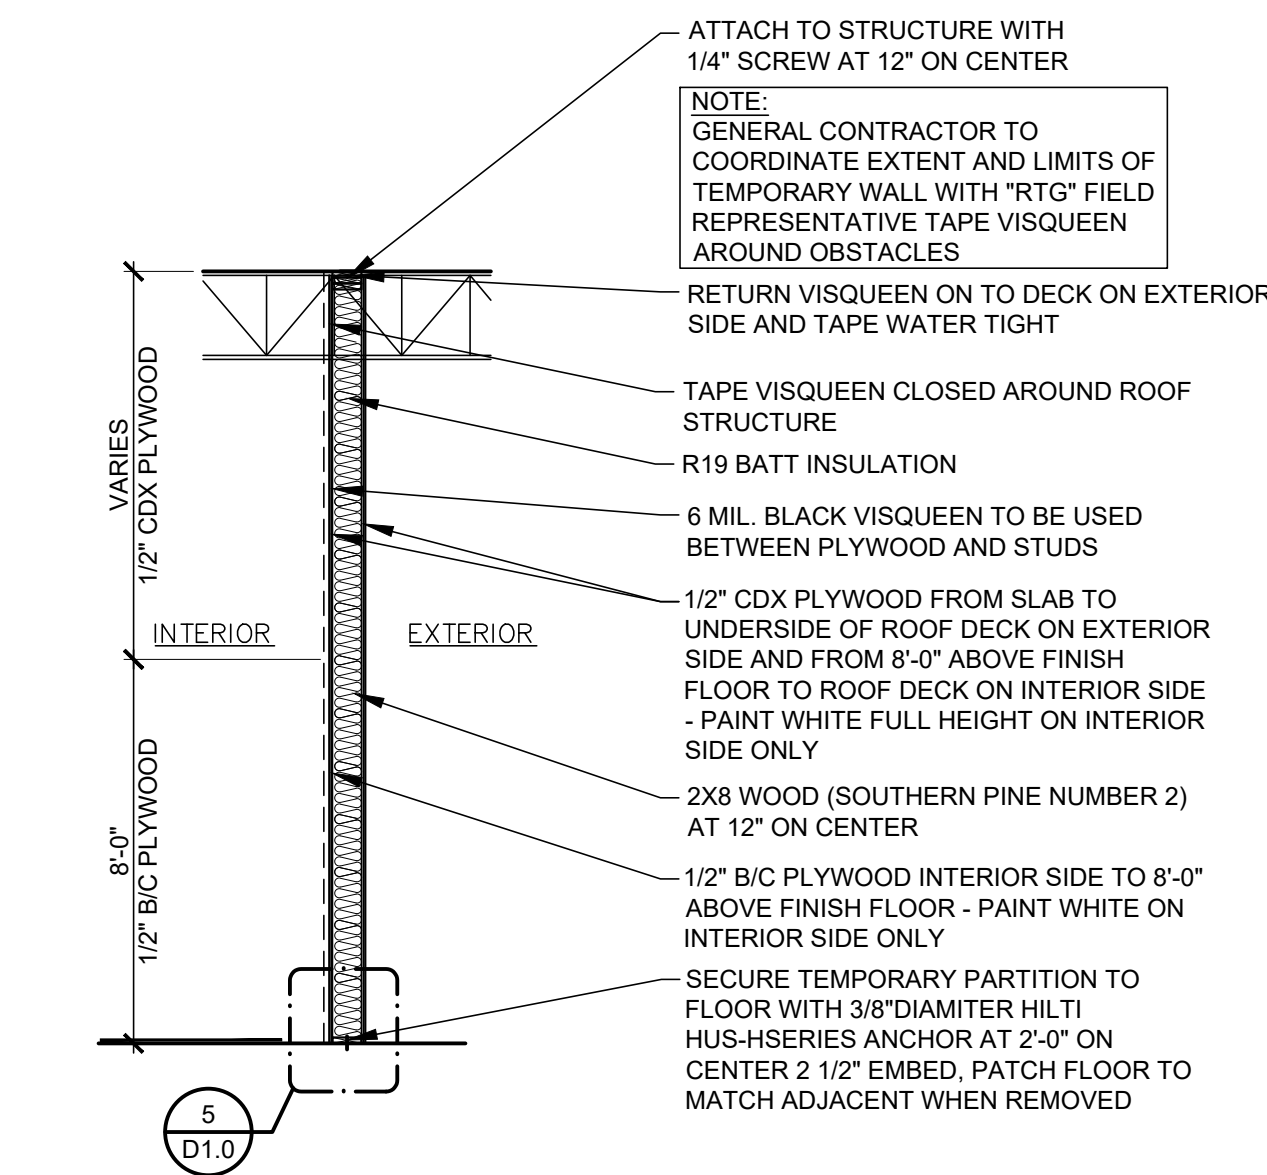


2 EXTERIOR TEMPORARY WOOD STUD WALL DETAIL
 D1.0 SCALE: 1/4" = 1'-0"

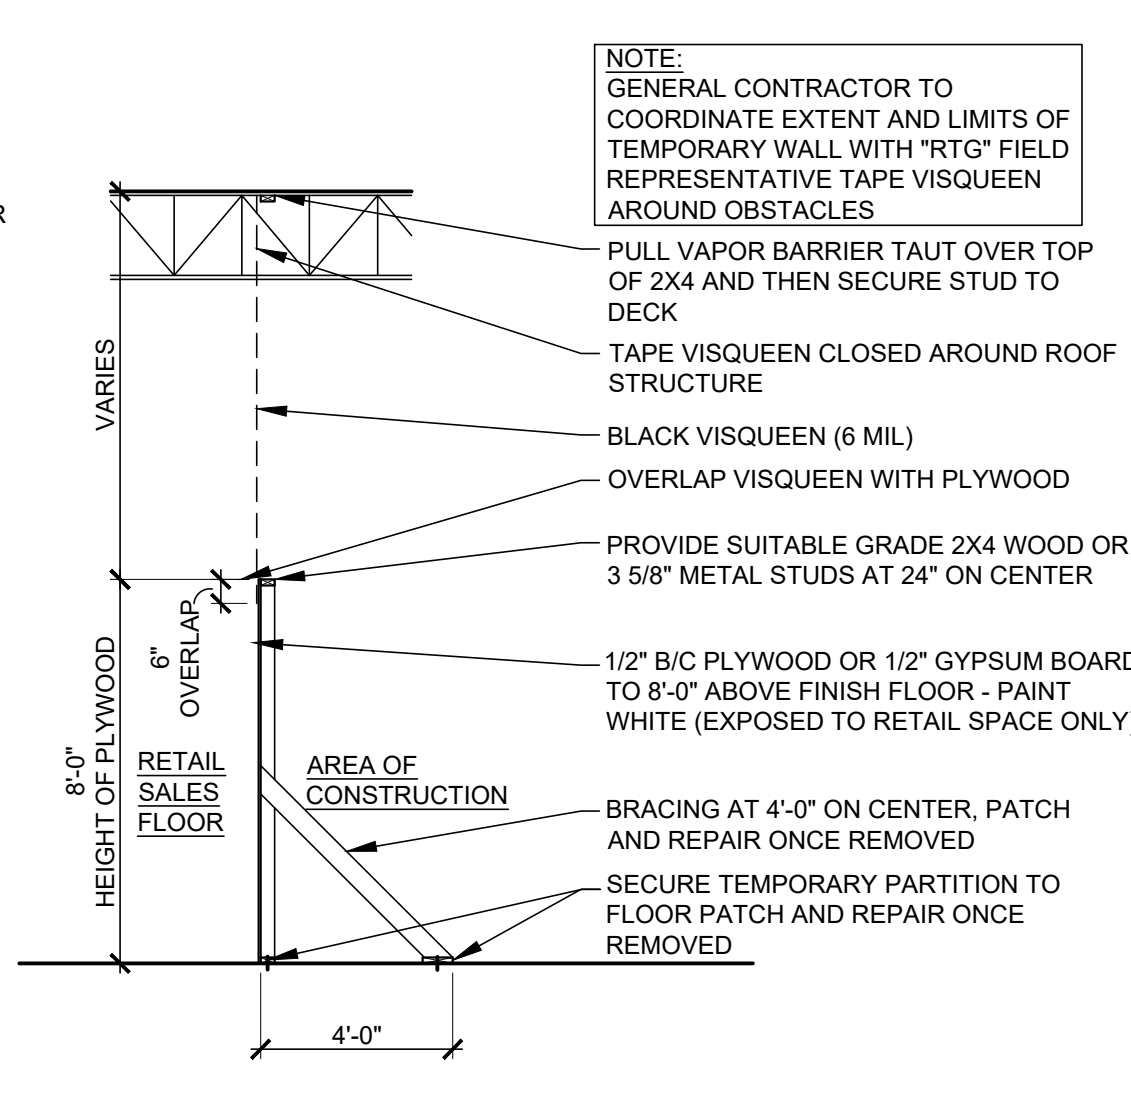


3 DUST WALL DETAIL
 D1.0 SCALE: 1/4" = 1'-0"

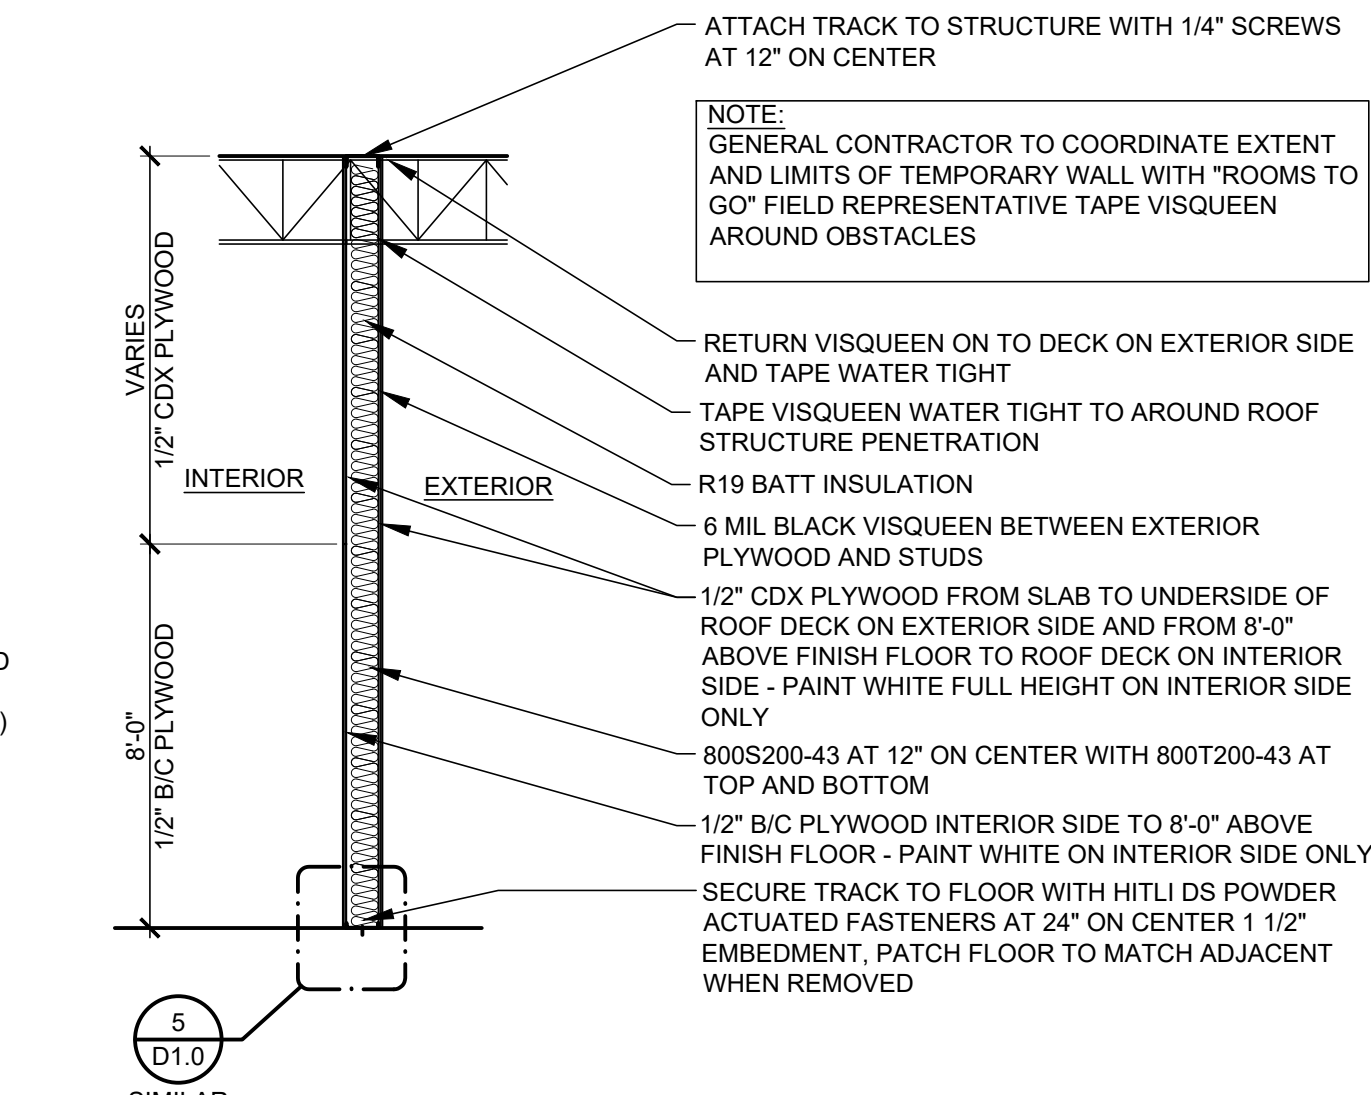

4 EXTERIOR TEMPORARY METAL STUD WALL DETAIL
 D1.0 SCALE: 1/4" = 1'-0"

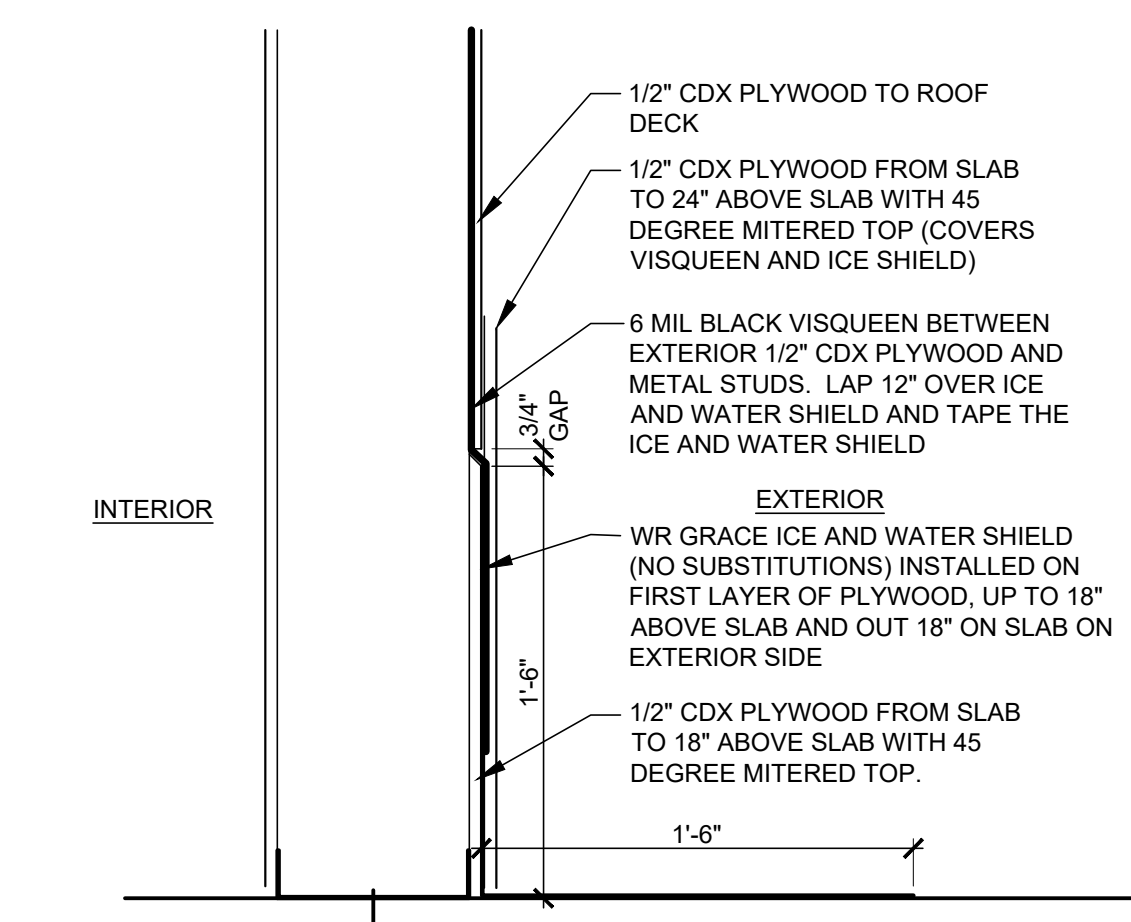

5 DETAIL
 D1.0 SCALE: 1 1/2" = 1'-0"

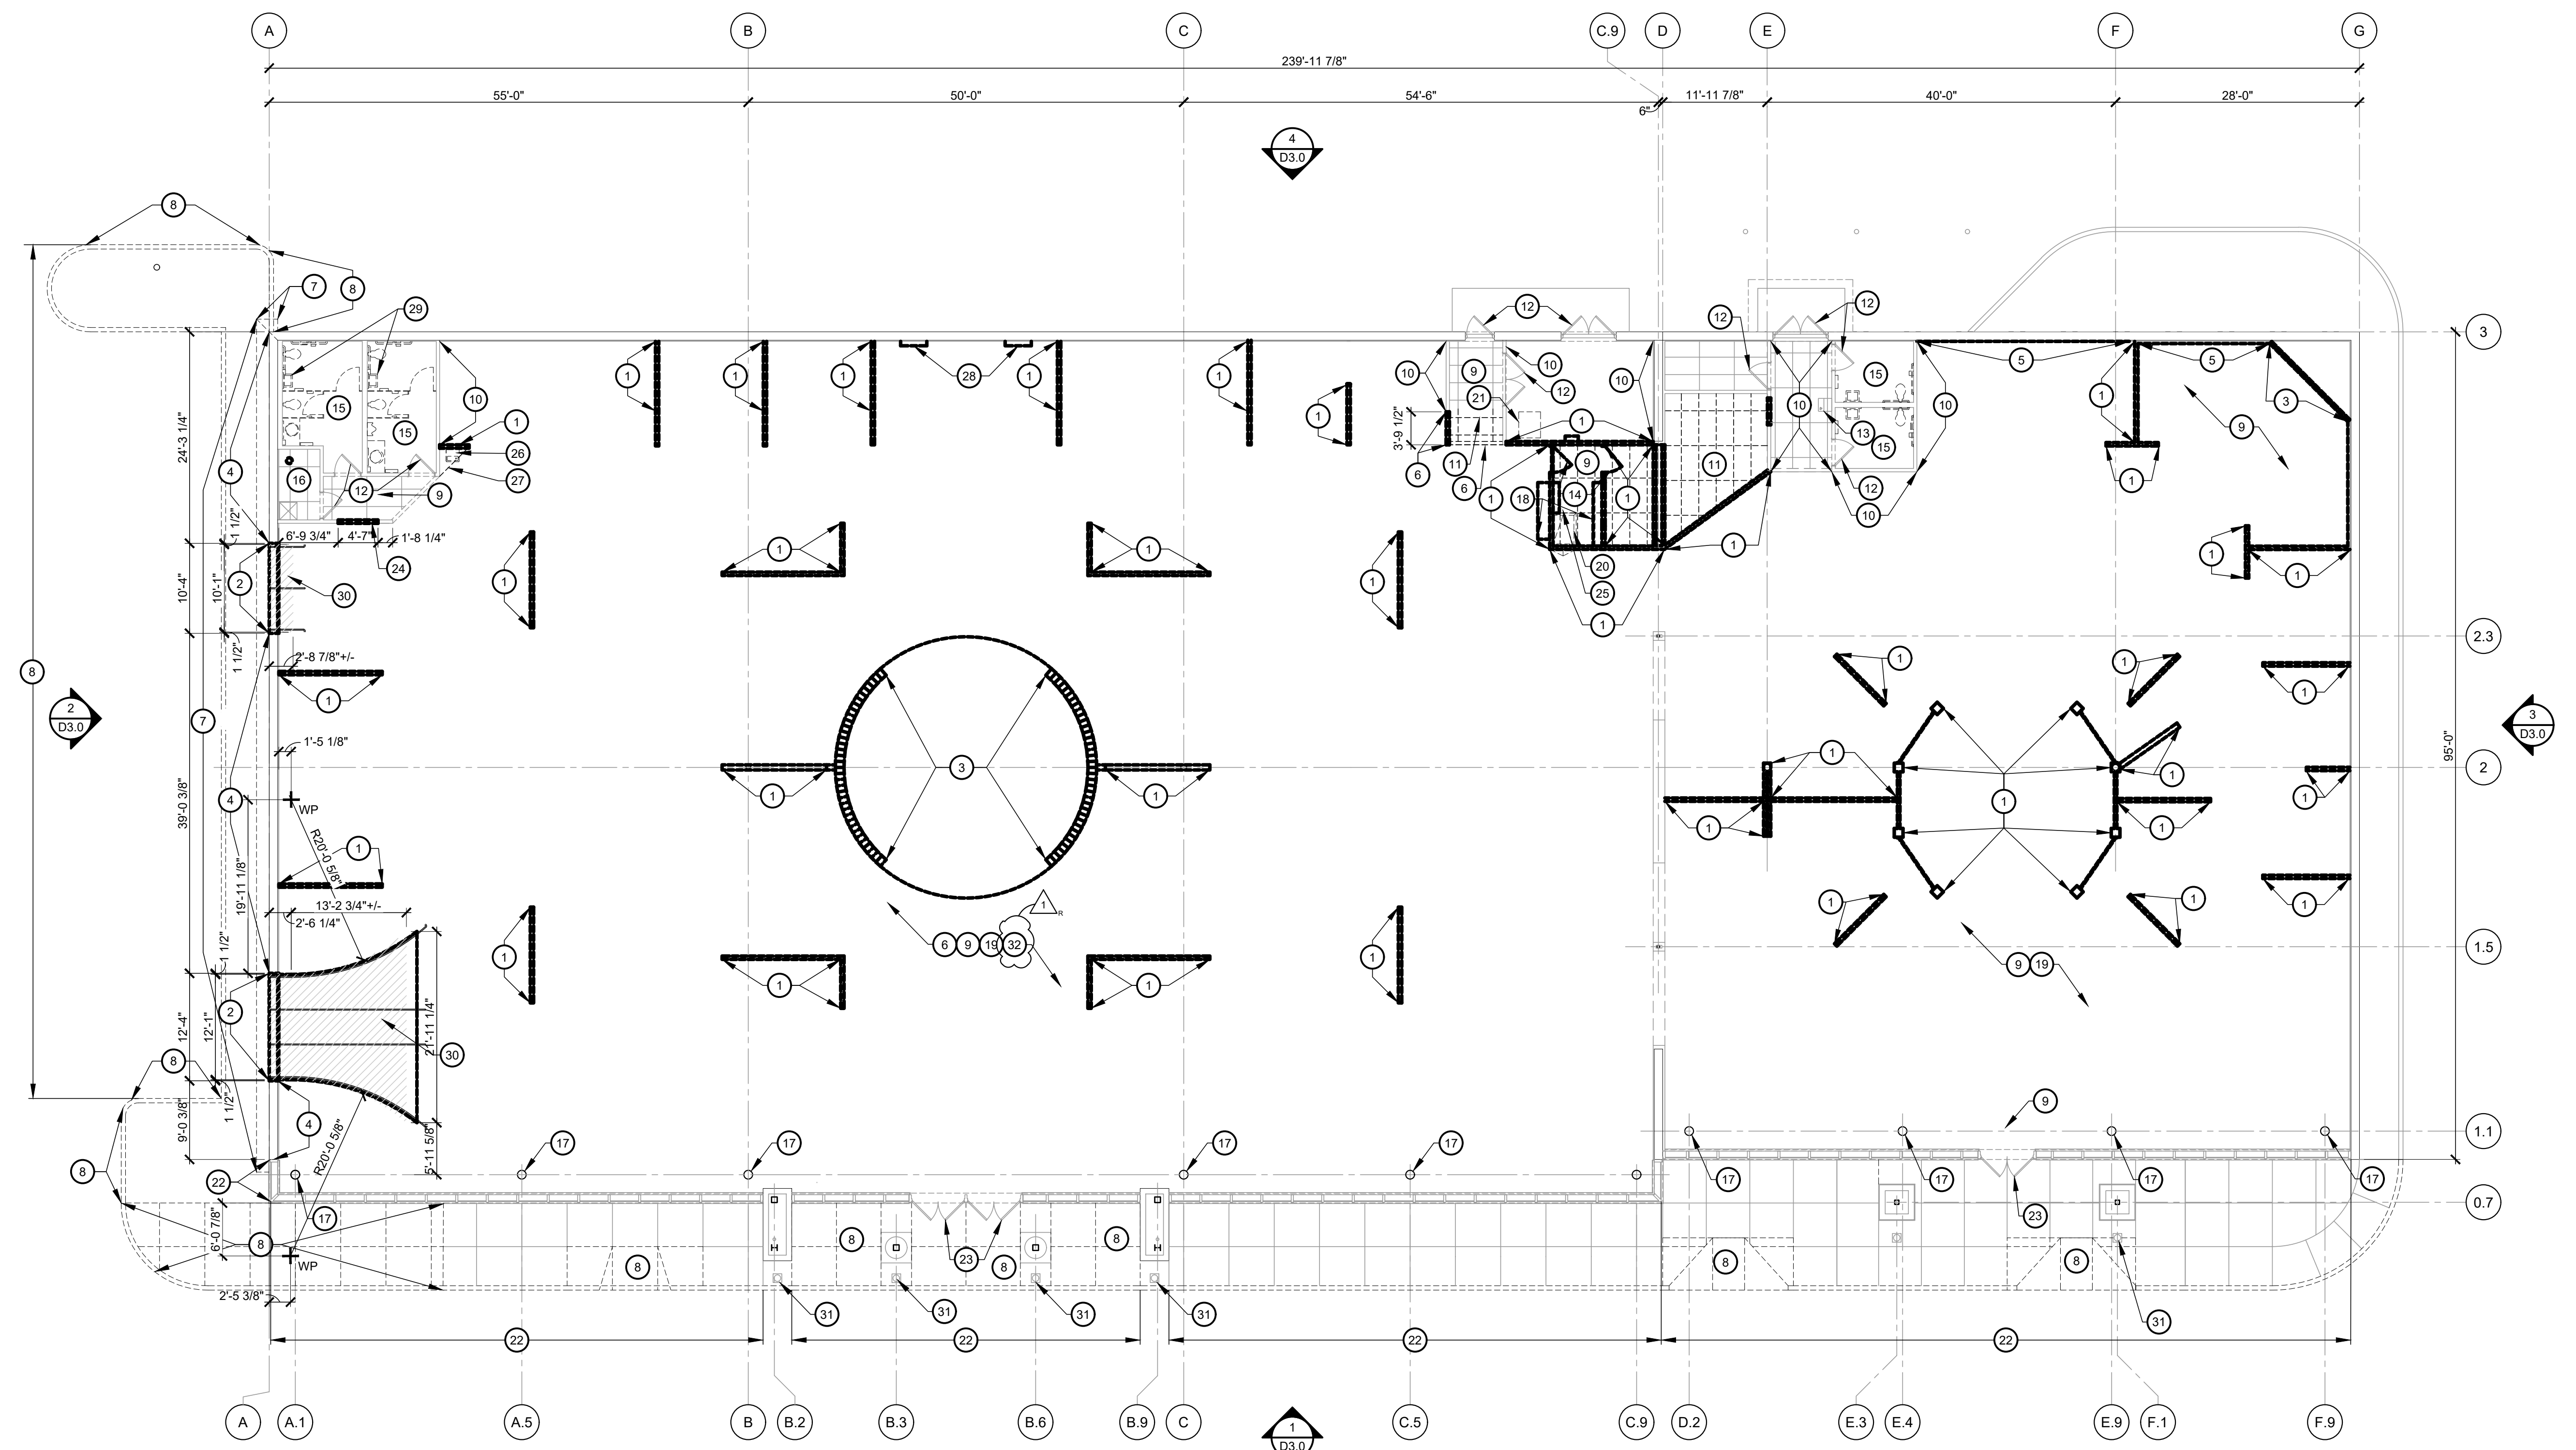

1 DEMOLITION FLOOR PLAN
 D1.0 SCALE: 3/32" = 1'-0"

- GENERAL NOTES:**
- ALL DEMOLITION WORK SHALL BE EXECUTED IN COMPLIANCE WITH ALL APPLICABLE FEDERAL, STATE AND LOCAL CODES, LAWS AND REGULATIONS.
 - THE GENERAL CONTRACTOR SHALL VISIT THE SITE AND FACILITY TO VERIFY ALL EXISTING CONDITIONS AND WORK INDICATED BY ALL CONTRACT DOCUMENTS. FAILURE TO REASONABLY DETERMINE AND/OR ANTICIPATE THE IMPACT OF THE SCOPE OF WORK ON EXISTING CONDITIONS SHALL NOT BE JUSTIFICATION FOR ADDITIONAL COMPENSATION. ANY DISCREPANCIES DIRECTED IN THE CONTRACT DOCUMENTS SHALL BE IMMEDIATELY REPORTED TO THE OFFICE OF THE ARCHITECT OF RECORD AND THE OWNER.
 - UNLESS NOTED OTHERWISE, ALL DEMOLISHED MATERIAL AND EQUIPMENT IS TO BECOME THE PROPERTY OF THE CONTRACTOR AND SHALL BE REMOVED FROM THE SITE IN A SAFE AND LEGAL MANNER. NO ON SITE SALE OF MATERIAL IS ALLOWED.
 - ALL MATERIALS, EQUIPMENT, FIXTURES, SYSTEMS AND ACCESSORIES WHICH ARE TO REMAIN IN SERVICE SHALL BE CLEANED, REPAIRED, ADJUSTED, RECONDITIONED, AND PLACED INTO PROPER OPERATIONS, IN ALL MODES, WITH THE ORIGINAL SYSTEM.
 - THE GENERAL CONTRACTOR SHALL RETAIN AND PAY FOR THE SERVICES OF A PROFESSIONAL ENGINEER, LICENSED TO PRACTICE IN THE STATE, TO PREPARE DETAILED DRAWINGS OF ALL SHORING AND BRACING ON THIS PROJECT. SEND (3) SETS OF SEALED DRAWINGS TO THE OWNER PRIOR TO ANY DEMOLITION WORK. THE CONTRACTOR IS SOLELY RESPONSIBLE FOR THE MEANS AND METHODS OF ALL DEMOLITION WORK AND FOR PROVIDING ALL NECESSARY TEMPORARY SHORING, BRACING AND PROTECTION AS NECESSARY FOR SAFETY, STABILITY AND PROTECTION OF ALL EXISTING ELEMENTS AND STRUCTURE TO REMAIN. TEMPORARY SHORING AND BRACING SHALL BE ADEQUATE TO RESIST ALL APPLIED LOADS INCLUDING DEAD LOADS, LIVE LOADS, SNOW LOADS AND CONSTRUCTION LOADS, TO PROVIDE STABILITY AND TO PROVIDE FOR RESISTANCE TO WIND AND SEISMIC FORCES UNTIL ANY REQUIRED MODIFICATIONS TO THE STRUCTURE ARE COMPLETE.
 - EACH CONTRACTOR SHALL FOLLOW THE PROGRESS OF THE GENERAL DEMOLITION AND REMODELING WORK TO ASSURE THE ACCESSIBILITY AND SAFETY OF EQUIPMENT AND SYSTEMS TO REMAIN IN SERVICE, AND TO PROVIDE FOR THE TIMELY REMOVAL AND/OR RELOCATION OF EQUIPMENT, PIPING, ETCETERA.
 - SEE CIVIL DRAWINGS FOR EXTENT OF EXTERIOR SLAB AND PAVEMENT REMOVAL.
 - ALL ABANDONED VENT PIPING THRU ROOF SHALL BE REMOVED COMPLETELY. CONTRACTOR SHALL BE RESPONSIBLE FOR OBTAINING AND PAYING FOR ALL DEMOLITION PERMITS.
 - ALL VENT PIPING, WASTE STACKS, AND STORM DRAIN DROPS THAT REMAIN AND IS FOUND TO BE LOCATED IN CLEAR FLOOR SPACE SHALL BE REWORKED AS NECESSARY TO RELOCATE SUCH PIPING INSIDE OR ALONG COLUMNS AND WALLS. ALL WORK SHALL BE COORDINATED WITH THE GENERAL CONTRACTOR SO AS NOT TO INTERFERE WITH NEW CONSTRUCTION OR FIXTURING.
 - CONTRACTOR SHALL INSPECT ALL EXISTING STORM, EQUIPMENT DRAINS AND WATER PIPING WHICH IS EXPOSED AND/OR SUBJECT TO CONDENSATION FOR PROPER INSULATION, REPAIR AND/OR REPLACE ALL DAMAGED OR MISSING PIPE INSULATION TO ASSURE ALL PIPING WILL BE INSULATED PER THE MINIMUM REQUIREMENTS AS OUTLINED IN THE SPECIFICATIONS.
 - ALL DEMOLITION AND CONSTRUCTION WORK SHALL BE PERFORMED SO IT DOES NOT INTERFERE WITH THE TENANTS OR CUSTOMERS OF THE NEIGHBORING SHOPS OR RESTAURANTS.
 - GENERAL CONTRACTOR TO MAKE NECESSARY PROVISIONS THAT THE BUILDING IS LEFT IN A SECURE MANNER AT ALL TIMES.
 - GENERAL CONTRACTOR SHALL PROVIDE ADEQUATE PROTECTION FOR ALL EXISTING CONSTRUCTION DURING THE DEMOLITION AND CONSTRUCTION PROCESS TO PREVENT DAMAGE TO EXISTING FINISHES OR MATERIALS.
 - GENERAL CONTRACTOR SHALL COORDINATE THE EXTENT OF ALL DEMOLITION WITH THE REQUIREMENTS OF THE NEW CONSTRUCTION AND REPORT ANY DISCREPANCIES IN THE CONSTRUCTION DOCUMENTS TO ROOMS TO GO CONSTRUCTION PROJECT MANAGER AND ARCHITECT OF RECORD.
 - ALL EXISTING FIRE PROTECTION, INCLUDING HEADS AND PIPING IS TO BE REUSED AND MODIFIED TO ACCOMMODATE NEW WORK, COORDINATE WITH FIRE PROTECTION DRAWINGS FOR FURTHER INFORMATION.

FLOOR PLAN KEYED DEMOLITION NOTES:

- REMOVE EXISTING PARTITIONS IN ENTIRETY INCLUDING: SUPPORT ANGLES, FRAMING, FINISH MATERIALS AND ATTACHMENTS. PATCH SLAB TO MATCH EXISTING REMAINING SLAB. REMOVE SUPPORTS TO FLOOR, PATCH AND REPAIR FLOOR. CLEAN AND APPLY CONCRETE BONDING AGENT BEFORE POURING CONCRETE. NEW CONCRETE TO MATCH ALL AROUND, INCLUDING LEVEL AND FINISH TEXTURE OF ADJACENT. SALVAGE EXISTING FIXTURE ITEMS, SUCH AS: PLAQUES, STATUES, DECORATIVE FEATURES, ETCETERA FOR OWNER REQUEST. CAP ELECTRICAL OR PLUMBING BELOW CONCRETE SLAB OR ABOVE BOTTOM CHORD OF ROOF JOISTS.
- SAW CUT AND REMOVE PORTION OF EXISTING EXTERIOR MASONRY WALL TO THE EXTENT SHOWN BY 11'-4" ABOVE FINISH FLOOR, DOWN 1 COURSE OF BLOCK BELOW FINISH FLOOR, INSTALL NEW STEEL LINTEL AND TOOTH IN NEW CONCRETE MASONRY UNITS INTO THE EXISTING MASONRY WALL - REFER TO STRUCTURAL EXISTING CONDITIONS NOTES
- REMOVE EXISTING GLASS BLOCK WALL COMPLETELY, INCLUDING ANCHORS, REINFORCING, MORTAR, ETCETERA.
- EXISTING EXTERIOR MASONRY WALL TO REMAIN. PROTECT DURING THE DEMOLITION PROCESS.
- CUT AND REMOVE EXISTING GYPSUM BOARD, FURRING AND INSULATION AS INDICATED, EXPOSING EXTERIOR MASONRY WALL.
- CUT AND REMOVE PORTION OF EXISTING GYPSUM BOARD PARTITION COMPLETELY, INCLUDING STUDS, TRACKS, ANCHORS, ETCETERA. PATCH AND REPAIR EXISTING PARTITION AS REQUIRED, PROVIDE A "LIKE NEW" CONDITION
- REMOVE EXISTING EXTERIOR INSULATION FINISH SYSTEM FRIEZE AND CORNICHE, DOWN TO EXISTING MASONRY WALL
- SAW CUT AND REMOVE CONCRETE CURB AND SIDEWALK TO ALLOW FOR NEW CONSTRUCTION. MAKE SAWCUT LINES STRAIGHT, FOR EVEN EDGE. EXCAVATE TO ALLOW FOR INSTALLATION OF NEW KNEE WALL, STEEL COLUMNS AND FOOTINGS. REFER TO CIVIL, STRUCTURAL, AND MECHANICAL DRAWINGS.
- REMOVE EXISTING FLOOR COVERING DOWN TO EXISTING CONCRETE SLAB. CLEAN AND PREPARED CONCRETE SLAB IN ACCORDANCE WITH MANUFACTURERS STANDARDS FOR THE APPLICATION OF THE NEW FLOOR FINISH MATERIAL TO BE INSTALLED.
- EXISTING INTERIOR PARTITION WALL TO REMAIN. PROTECT DURING THE DEMOLITION PROCESS.
- REMOVE EXISTING LAY-IN CEILING TILES, SUSPENSION GRID, LIGHT FIXTURES AND OTHER DEVICES. RETAIN DIFFUSERS FOR REPAINTING AND REUSE IN NEW CEILING - REF MECHANICAL, PLUMBING & ELECTRICAL DEMOLITIONS AND NEW DRAWINGS.
- EXISTING DOOR AND FRAME TO REMAIN.
- EXISTING WATER COOLER TO REMAIN
- REMOVE EXISTING DOOR IN ITS ENTIRETY INCLUDING FRAME, HARDWARE, .
- TEMPORARILY REMOVE EXISTING WATER CLOSETS AND URINALS AS REQUIRED TO INSTALL NEW FLOOR AND WALL FINISHES, WATER CLOSETS AND URINALS TO BE CLEANED AND RE-INSTALLED AFTER NEW FLOOR AND WALL FINISHES, ARE INSTALLED. REMOVE EXISTING LAVATORIES, TOILET PARTITIONS, TOILET ROOM ACCESSORIES, WALL FINISHES, FLOOR FINISHES AND EXISTING CEILING TILES AND GRID. REPLACE EXISTING WALL BOARD AS REQUIRED.
- EXISTING JANITOR'S CLOSET TO REMAIN
- PREPARE EXISTING COLUMNS TO BE PAINTED.
- REMOVE EXISTING SHELVING, FURNITURE, COUNTERTOPS, ETCETERA.
- COORDINATE WITH ELECTRICAL AND MECHANICAL DRAWINGS FOR LOCATION OF REQUIRED SAW CUTTING OF EXISTING CONCRETE FLOOR SLAB AS REQUIRED FOR NEW ELECTRICAL OR MECHANICAL REQUIREMENTS. SEE STRUCTURAL FOR INSTALLATION OF NEW SLAB TO EXISTING SLAB DETAIL.
- REMOVE EXISTING ROOF HATCH COMPLETELY, PATCH AND REPAIR EXISTING METAL ROOF DECK, TO MATCH EXISTING. PATCH AND REPAIR EXISTING ROOFING SYSTEM AND INSULATION WITH MATERIALS COMPATIBLE WITH EXISTING ROOF SYSTEM. WORK IS TO BE PERFORMED IN SUCH A MANNER AS TO NOT VOID ANY WARRANTY IN EFFECT. PROVIDE A PERMANENT WEATHERTIGHT CONDITION.
- SAW CUT AND REMOVE PORTION OF EXISTING ROOFING AND ROOF DECK AS REQUIRED TO INSTALL NEW ROOF HATCH. INSTALL NEW ROOF FRAMING AS REQUIRED. (SEE STRUCTURAL DRAWINGS). PATCH AND REPAIR EXISTING ROOFING SYSTEM AND INSULATION AS REQUIRED. FLASH NEW ROOF HATCH INTO EXISTING ROOFING SYSTEM COMPATIBLE WITH EXISTING ROOF SYSTEM. WORK IS TO BE PERFORMED IN SUCH A MANNER AS TO NOT VOID ANY WARRANTY IN EFFECT. PROVIDE A PERMANENT WEATHERTIGHT CONDITION.
- EXISTING CURTAINWALL SYSTEM AND GLAZING TO REMAIN, PROTECT FROM DAMAGE DURING DEMOLITION AND NEW CONSTRUCTION OPERATIONS
- EXISTING STOREFRONT DOORS TO REMAIN.
- SAW CUT AND REMOVE PORTION OF EXISTING GYPSUM BOARD AND METAL STUD PARTITION, WIDTH AS DIMENSIONED, HEIGHT TO 8'-0" ABOVE FINISH FLOOR. INSTALL NEW METAL STUD HEADER AND REFRAME JAMBS AS REQUIRED.
- REMOVE EXISTING PLATFORM COMPLETELY INCLUDING PLATFORM ACCESS AND ROOF ACCESS LADDERS AND RAILINGS.
- DISCONNECT AND REMOVE EXISTING DRINKING FOUNTAIN. CAP PLUMBING SUPPLY AND DRAIN PIPING BELOW SLAB OR ABOVE BOTTOM CHORD OF JOISTS AND REMOVE
- REMOVE EXISTING SOFFIT COMPLETELY, INCLUDING FRAMING AND SUPPORT MEMBERS
- REMOVE EXISTING BUMP-OUT COMPLETELY INCLUDING: FINISHES, WALL BOARD, FRAMING ETCETERA.
- REMOVE EXISTING LAVATORY, CAP EXISTING PLUMBING PIPING INSIDE EXISTING WALL. PATCH AND REPAIR EXISTING WALL BOARD AND PREPARE FOR NEW WALL FINISHES
- SAW CUT AND REMOVE PORTION OF EXISTING CONCRETE FLOOR SLAB AS INDICATED BY HATCH PATTERN. PREPARE SUBGRADE FOR NEW CONCRETE RAMP OR STAIRS
- ULTRIGHT FIXTURE TO BE PROTECTED DURING DEMOLITION AND REUSED. SEE ELECTRICAL AND CIVIL.

ROOMS TO GO
 STORE EXPANSION AND REMODEL
 18722 SOUTH DIXIE HIGHWAY,
 CUTLER BAY, FL 33157

CONSTR. DOC. & REVISIONS	
Date	08/21/23
Date	11/29/23
Description	CODE COMMENT RESPONSE
No.	1 ADDENDUM 2




Drawn By/Checked By: dir/MSB
 Project Number: 2101445
 Bid Date: 11/09/23
 Permit: 03/28/23
 Owner Date: 07/06/22


DEMOLITION FLOOR PLAN
D1.0

ROOF PLAN KEYED DEMOLITION NOTES:

- 1 REMOVE EXISTING PARAPET METAL CAP, EXTERIOR INSULATION FINISH SYSTEM FRIEZE AND CORNICE, FRAMING, BLOCKING ETCETERA. SEE DETAIL 4/A4.0 FOR ADDITIONAL INFORMATION
- 2 CUT AND REMOVE 4'-0" WIDE PORTION OF EXISTING PARAPET FRAMING AND BRACING. REFRAME AS REQUIRED TO CLOSE OFF SIDES OF PASS-THRU. INSTALL 1/2" EXTERIOR GRADE PLYWOOD SHEATHING AND NEW SINGLE-PLY ROOF MEMBRANE. PROVIDE A WEATHER TIGHT CONDITION. SEE ROOF PLAN 1/A1.3 AND DETAIL 10/A5.4 FOR ADDITIONAL INFORMATION
- 3 EXISTING PARAPET METAL CAP, EXTERIOR INSULATION FINISH SYSTEM FRIEZE AND CORNICE TO REMAIN
- 4 REMOVE EXISTING ROOF HATCH COMPLETELY. PATCH AND REPAIR EXISTING METAL ROOF DECK TO MATCH EXISTING. PATCH AND REPAIR EXISTING ROOFING SYSTEM AND INSULATION WITH MATERIALS COMPATIBLE WITH EXISTING ROOF SYSTEM. WORK IS TO BE PERFORMED IN SUCH A MANNER AS TO NOT VOID ANY WARRANTY IN EFFECT. PROVIDE A PERMANENT WEATHERTIGHT CONDITION.
- 5 SAW CUT AND REMOVE PORTION OF EXISTING ROOFING AND ROOF DECK AS REQUIRED TO INSTALL NEW ROOF HATCH. INSTALL NEW ROOF FRAMING AS REQUIRED. (SEE STRUCTURAL DRAWINGS). PATCH AND REPAIR EXISTING ROOFING SYSTEM AND INSULATION AS REQUIRED. FLASH NEW ROOF HATCH INTO EXISTING ROOFING SYSTEM USING MATERIALS COMPATIBLE WITH EXISTING ROOF SYSTEM. WORK IS TO BE PERFORMED IN SUCH A MANNER AS TO NOT VOID ANY WARRANTY IN EFFECT. PROVIDE A PERMANENT WEATHERTIGHT CONDITION.
- 6 EXISTING SINGLE-PLY ROOF MEMBRANE SYSTEM TO REMAIN. PROTECT FROM DAMAGE DURING DEMOLITION AND NEW CONSTRUCTION OPERATIONS
- 7 EXISTING SCUPPERS AND DOWNSPOUTS. TO REMAIN. REMOVE AND REPLACE EXISTING METAL SCUPPER LINING AND FLASHING WITH NEW. EXISTING DOWNSPOUTS AND COLLECTOR BOXES TO REMAIN
- 8 EXISTING ROOF-TOP UNIT TO REMAIN. SEE MECHANICAL DRAWINGS FOR ADDITIONAL INFORMATION
- 9 EXISTING EXHAUST FAN TO REMAIN. SEE MECHANICAL DRAWINGS FOR ADDITIONAL INFORMATION
- 10 EXISTING STANDING SEAM METAL BARREL VAULT ROOF TO REMAIN
- 11 EXISTING ENTRANCE CANOPY TO REMAIN
- 12 EXISTING KIDS ENTRANCE CANOPY TO REMAIN
- 13 EXISTING METAL PARAPET CAP TO REMAIN
- 14 EXISTING WALL HUNG CANOPY TO REMAIN
- 15 EXISTING CRICKETS TO REMAIN TYPICAL
- 16 EXISTING BUILT-UP PARAPET SUPPORT CANT TO REMAIN
- 17 EXISTING CANOPY GUTTER AND DOWNSPOUTS TO REMAIN
- 18 EXISTING WALK PADS TO REMAIN, TYPICAL
- 19 DISCONNECT AND REMOVE EXISTING ROOF-TOP UNIT AND PREPARE EXISTING CURB TO RECEIVE NEW ROOF-TOP UNIT, REFER TO MECHANICAL DRAWINGS

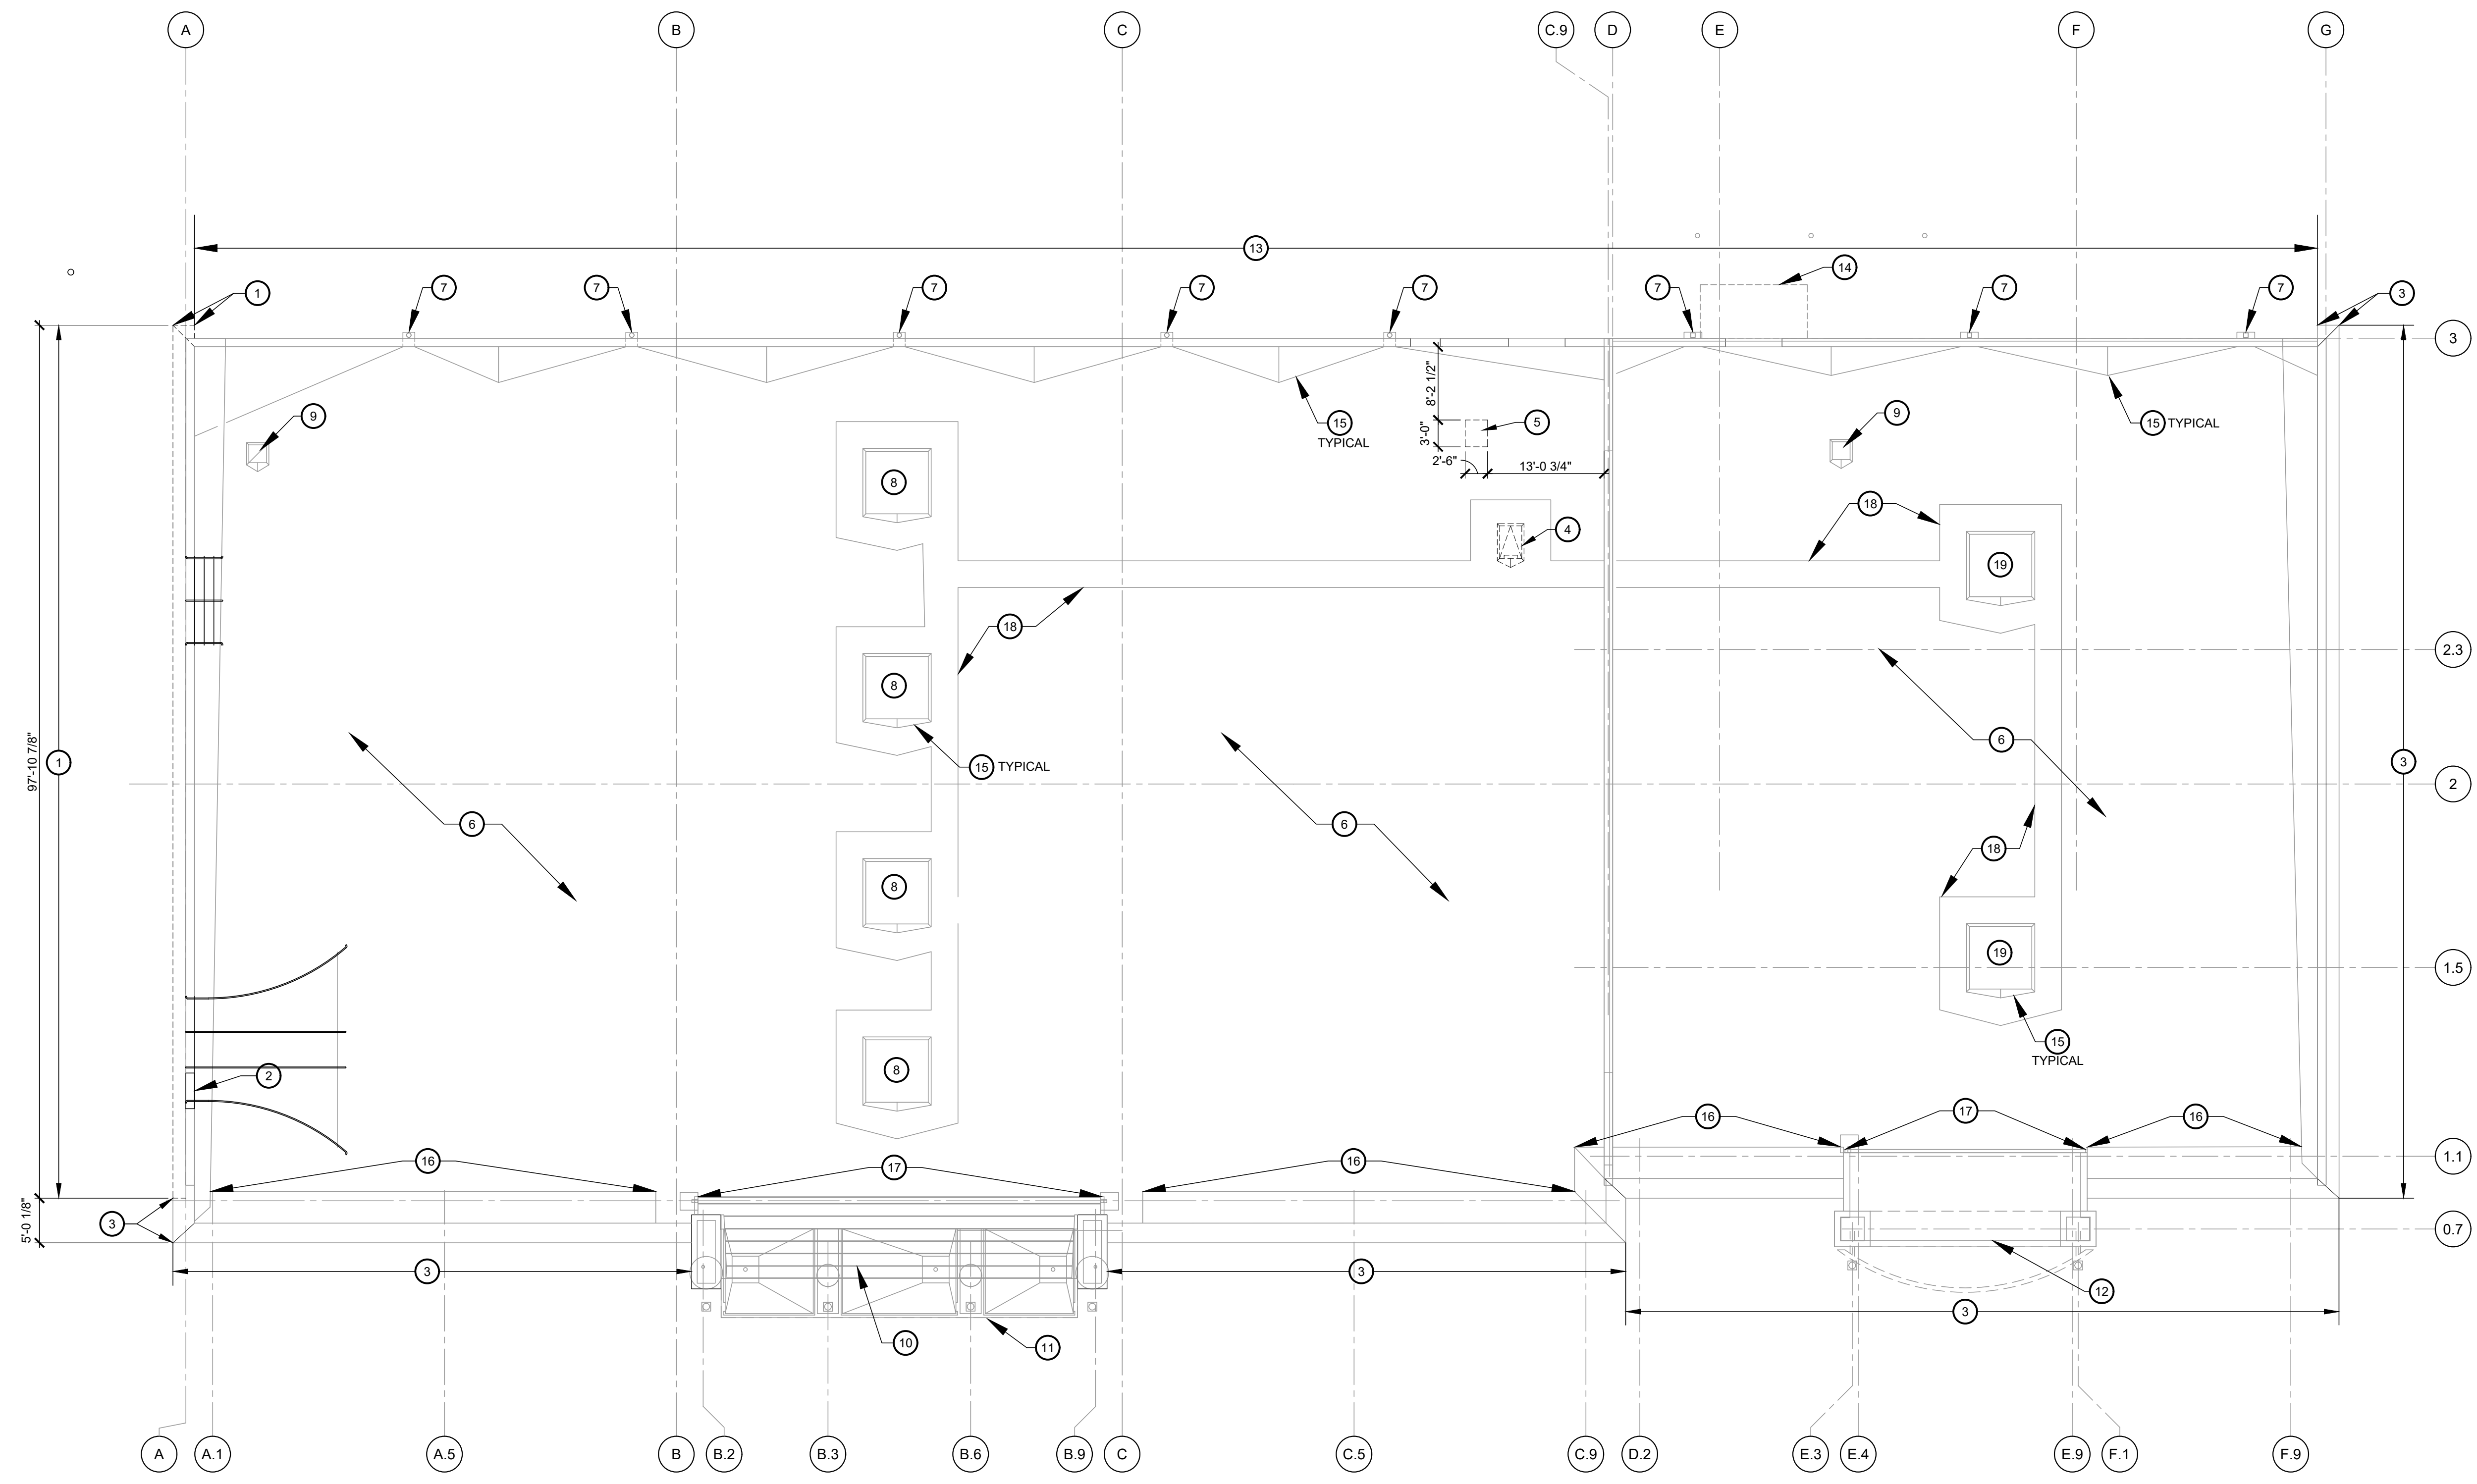


1 DEMOLITION ROOF PLAN
D2.0 SCALE: 3/32" = 1'-0"

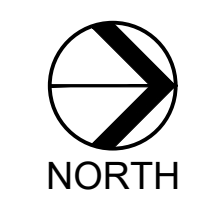


CONSTR. DOC. & REVISIONS

No.	Description	Date
1	ADDENDUM 2	11/29/23

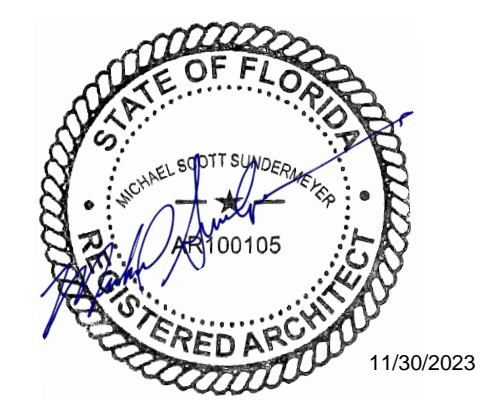


PROFESSIONAL OF RECORD
MICHAEL SCOTT SUNDERMEYER
License No.: AR100105
Expiration Date: 02/28/25


Drawn By/Checked By: dir/MSB
Project Number: 2101445
Bid Date: 11/09/23
Permit: 03/28/23
Owner Date: 07/06/22

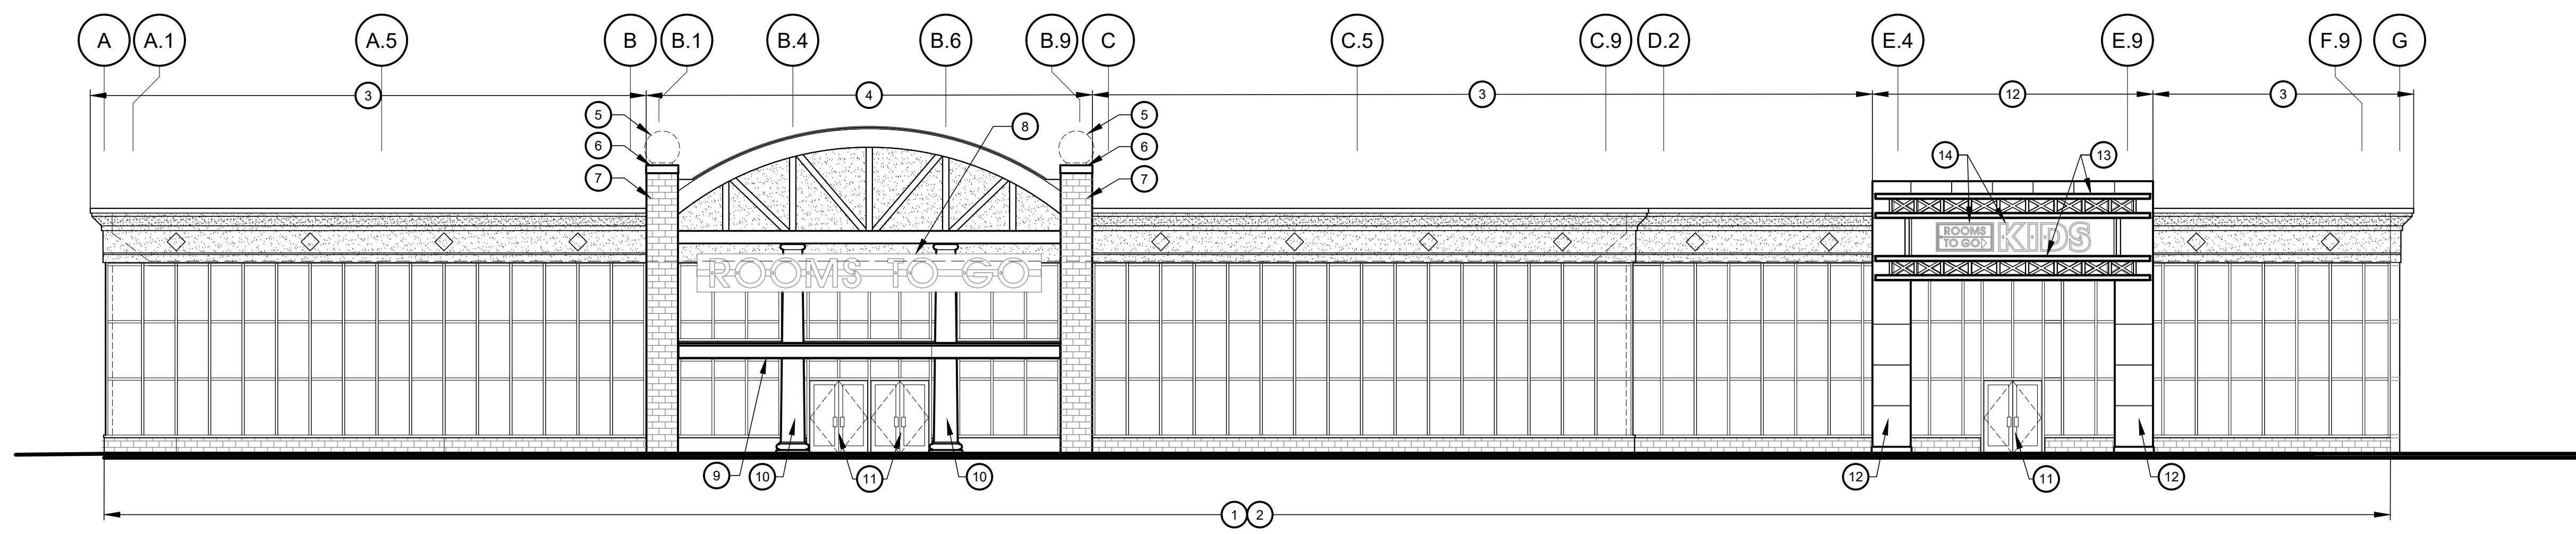


1 DEMOLITION FRONT ELEVATION (EAST)
 D3.0 SCALE: 1/8" = 1'-0"

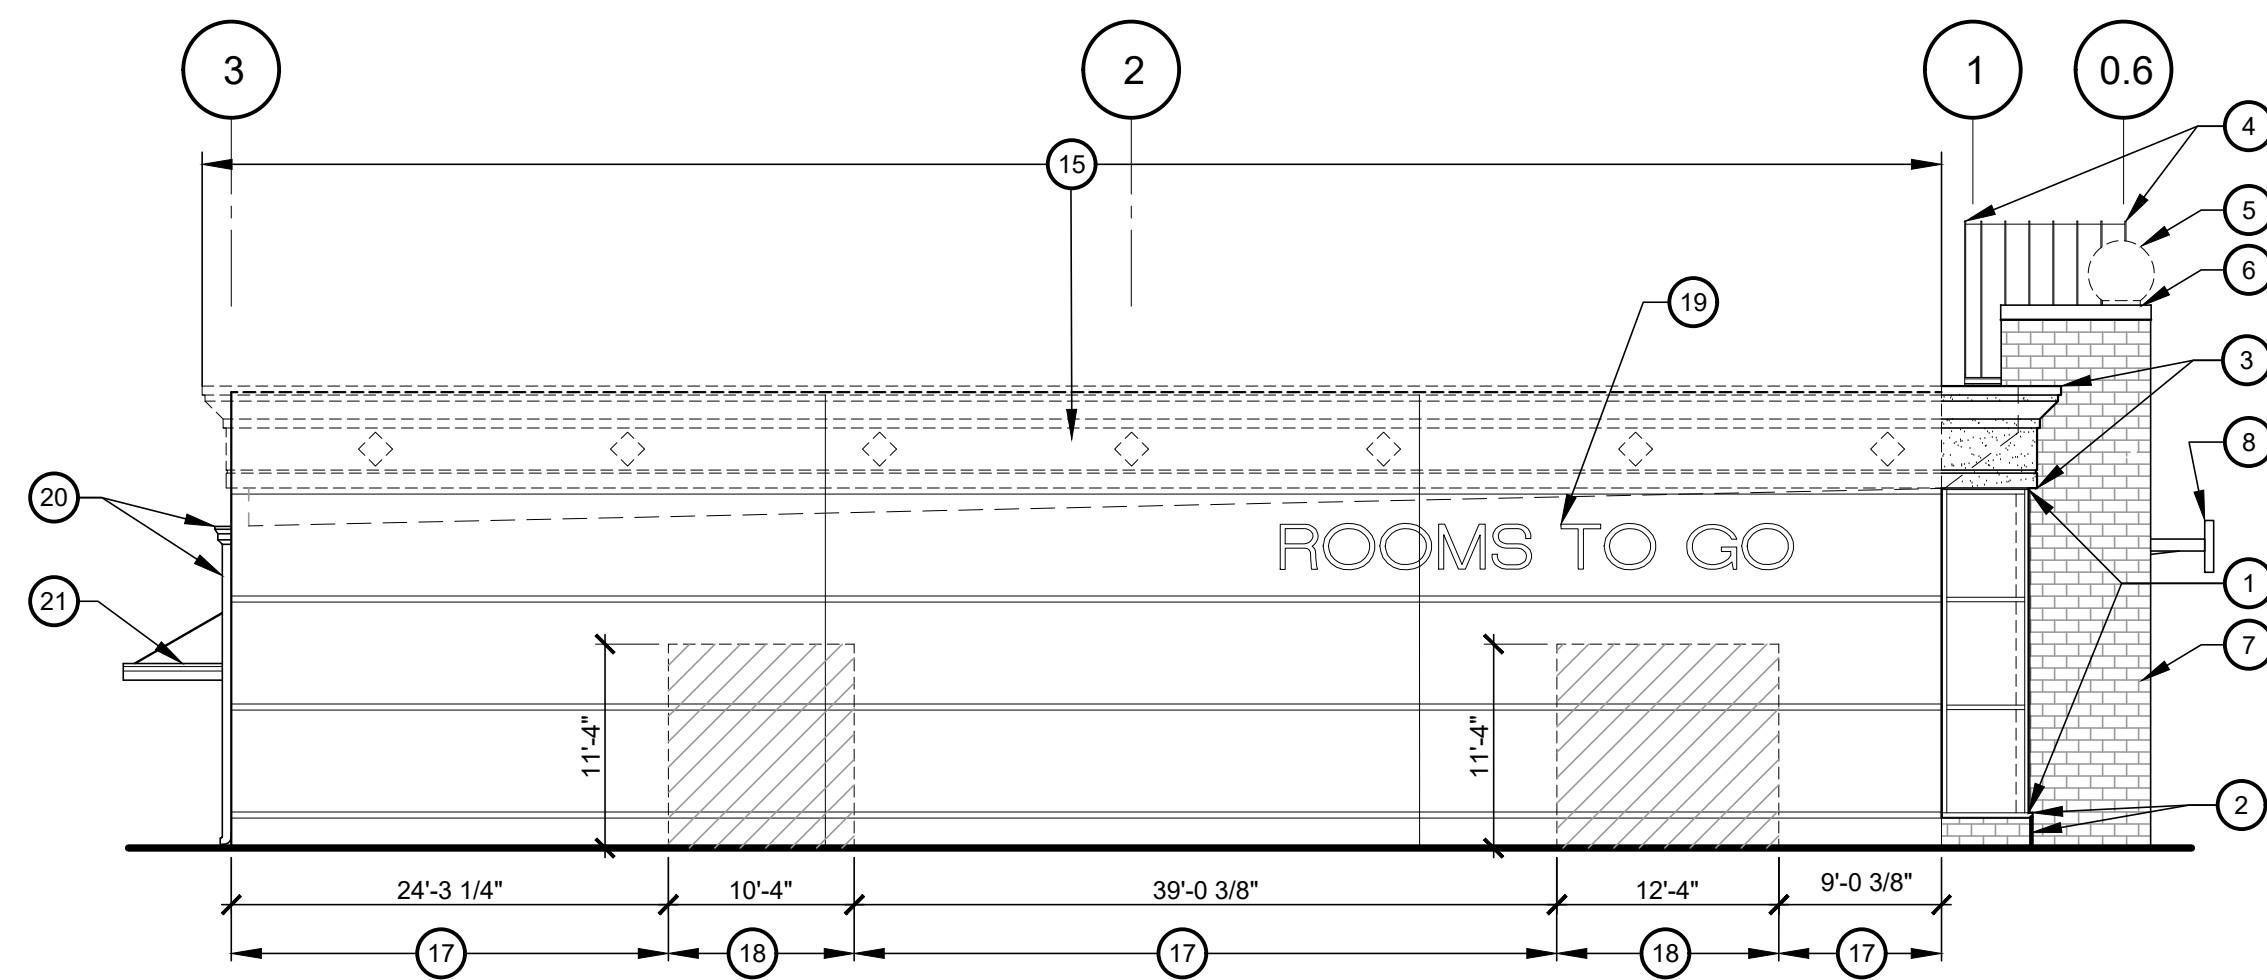

2 DEMOLITION LEFT ELEVATION (SOUTH)
 D3.0 SCALE: 1/8" = 1'-0"

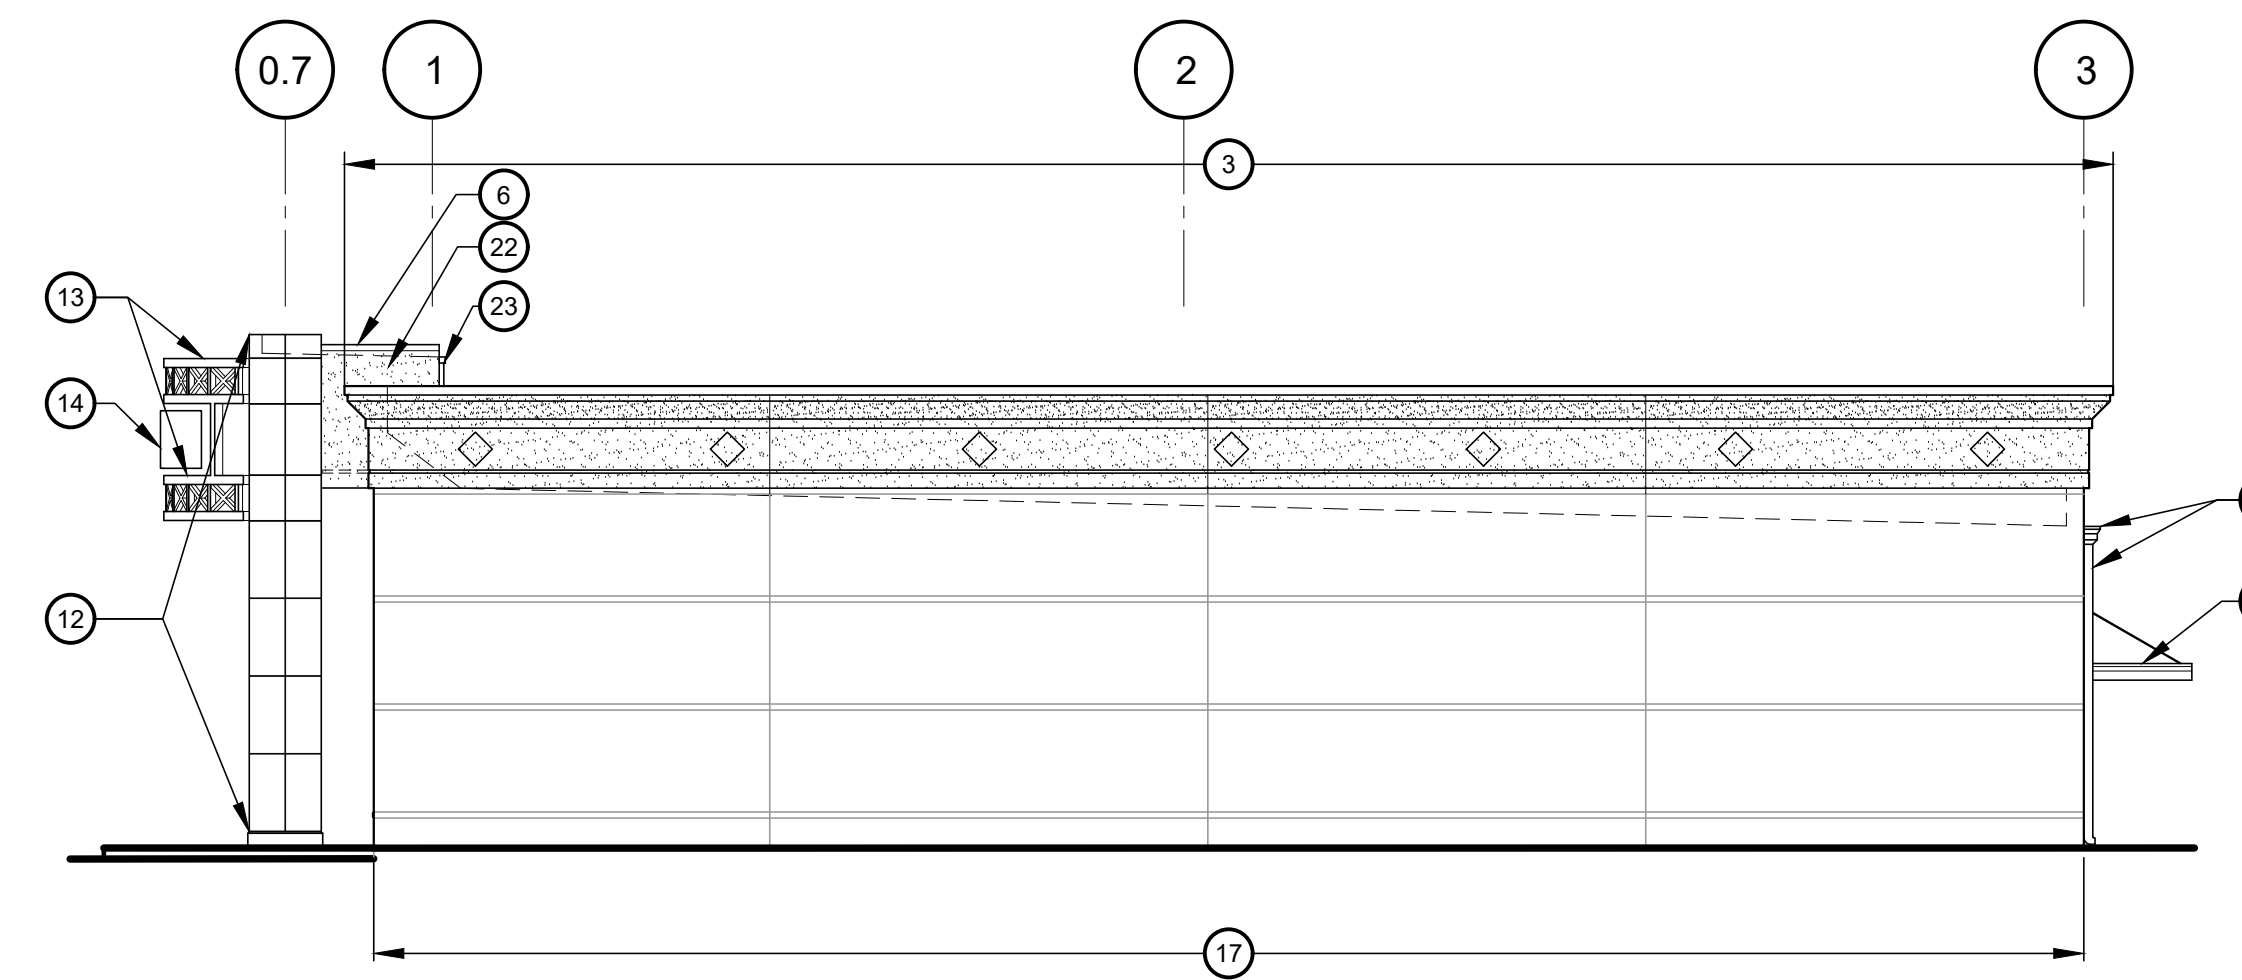

3 DEMOLITION RIGHT ELEVATION (NORTH)
 D3.0 SCALE: 1/8" = 1'-0"

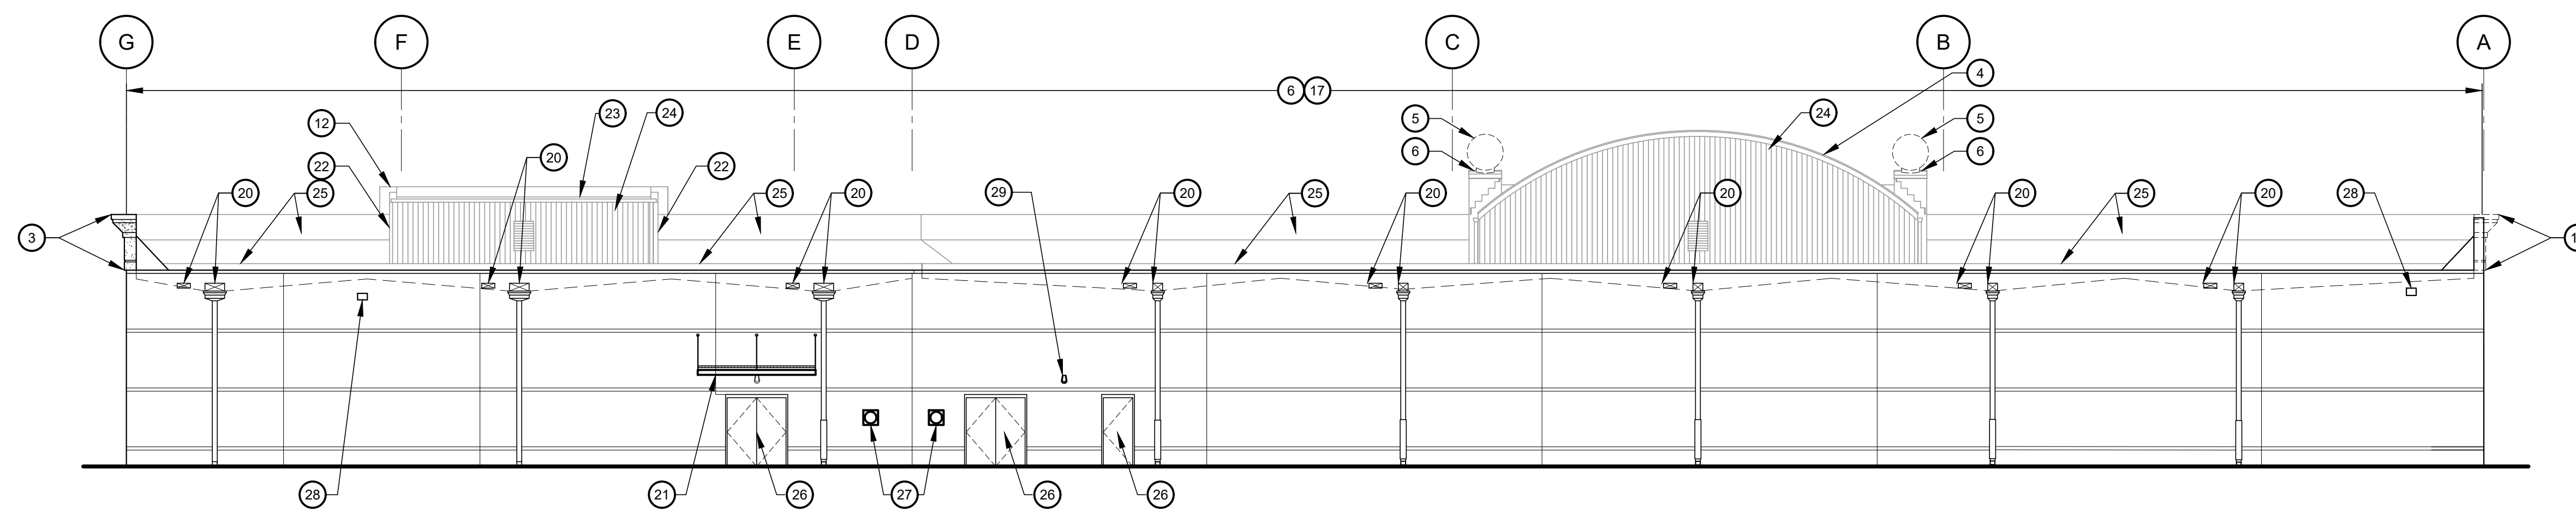


4 DEMOLITION REAR ELEVATION (WEST)
 D3.0 SCALE: 1/8" = 1'-0"

ELEVATIONS KEYED DEMOLITION NOTES:

- 1 EXISTING CURTAINWALL SYSTEM AND GLAZING TO REMAIN. CONTRACTOR TO PROTECT FROM DAMAGE DURING DEMOLITION AND NEW CONSTRUCTION OPERATIONS
- 2 EXISTING MASONRY KNEEWALL AND SILL TO REMAIN. CONTRACTOR TO PROTECT FROM DAMAGE DURING DEMOLITION AND NEW CONSTRUCTION OPERATIONS
- 3 EXISTING EXTERIOR INSULATION FINISH SYSTEM FRIEZE, CORNICE AND METAL CAP FLASHING TO REMAIN.
- 4 EXISTING STANDING SEAM BARREL VAULT ROOF TO REMAIN
- 5 REMOVE EXISTING EXTERIOR INSULATION FINISH SYSTEM SPHERE, COMPLETELY
- 6 REMOVE EXISTING METAL CAP FLASHING, AND REPLACE WITH NEW PRE-FINISHED METAL CAP FLASHING TO MATCH EXISTING
- 7 EXISTING MASONRY PILASTER TO REMAIN
- 8 EXISTING SIGNAGE AND CURVED SIGN SUPPORTS TO REMAIN
- 9 EXISTING STEEL CANOPY TO REMAIN
- 10 EXISTING COLUMN COVERS TO REMAIN
- 11 EXISTING ALUMINUM STOREFRONT AND GLAZING ENTRANCE DOORS TO REMAIN
- 12 EXISTING ALUMINUM COMPOSITE PANEL ENTRANCE ELEMENT TO REMAIN
- 13 EXISTING RADIUSSED STEEL CANOPY TO REMAIN
- 14 EXISTING SIGNAGE TO REMAIN
- 15 CUT AND REMOVE EXISTING EXTERIOR INSULATION FINISH SYSTEM FRIEZE AND CORNICE, DENSGLAS SHEATHING, AND FRAMING, DOWN TO EXISTING MASONRY WALL AND METAL STUDS
- 16 NOT USED
- 17 EXISTING EXTERIOR MASONRY WALL TO REMAIN. PROTECT DURING THE DEMOLITION PROCESS.
- 18 SAW CUT AND REMOVE PORTION OF EXISTING EXTERIOR MASONRY WALL TO THE EXTENT SHOWN BY 11'-4" ABOVE FINISH FLOOR, DOWN TO (1) COURSE BELOW FINISH FLOOR, INSTALL NEW STEEL LINTEL AND TOOTH IN NEW CONCRETE MASONRY UNITS INTO THE EXISTING MASONRY WALL - SEE STRUCTURAL FOR DETAILS AND SHORING REQUIREMENTS
- 19 DISCONNECT AND REMOVE EXISTING SIGNAGE. REMOVE EXISTING CONDUIT AND WIRING BACK TO PANEL.
- 20 EXISTING THRU-WALL SCUPPER, DOWNSPOUT AND DOWNSPOUT GUARD TO REMAIN
- 21 EXISTING WALL HUNG ALUMINUM CANOPY TO REMAIN
- 22 EXISTING EXTERIOR INSULATION FINISH SYSTEM FACIA/CANOPY, BEYOND TO REMAIN
- 23 EXISTING METAL GUTTER AND DOWNSPOUTS TO REMAIN
- 24 EXISTING METAL SIDING BEYOND
- 25 EXISTING SINGLE-PLY MEMBRANE ROOFING, BEYOND
- 26 EXISTING HOLLOW METAL DOORS TO REMAIN
- 27 EXISTING ELECTRICAL METERS
- 28 EXISTING WALL PACK LIGHT FIXTURES TO REMAIN
- 29 EXISTING LIGHT FIXTURE TO REMAIN

STORE EXPANSION AND REMODEL

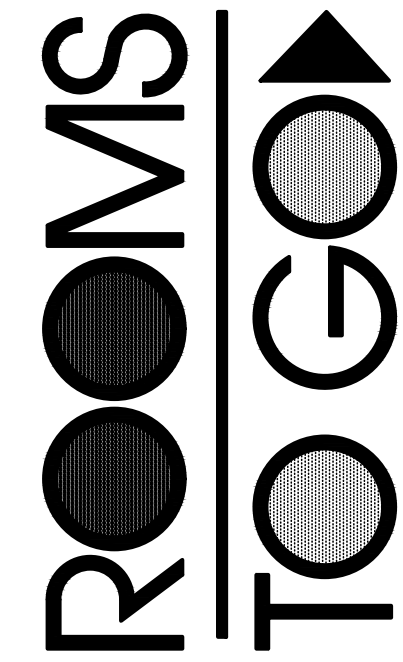

18722 SOUTH DIXIE HIGHWAY,
CUTLER BAY, FL 33157


CONSTR. DOC. & REVISIONS

No.	Description	Date
1	ADDENDUM 2	11/29/23




Drawn By/Checked By: dir/MSB
 Project Number: 2101445
 Bid Date: 11/09/23
 Permit: 03/28/23
 Owner Date: 07/06/22


**DEMOLITION
EXTERIOR
ELEVATIONS
D3.0**

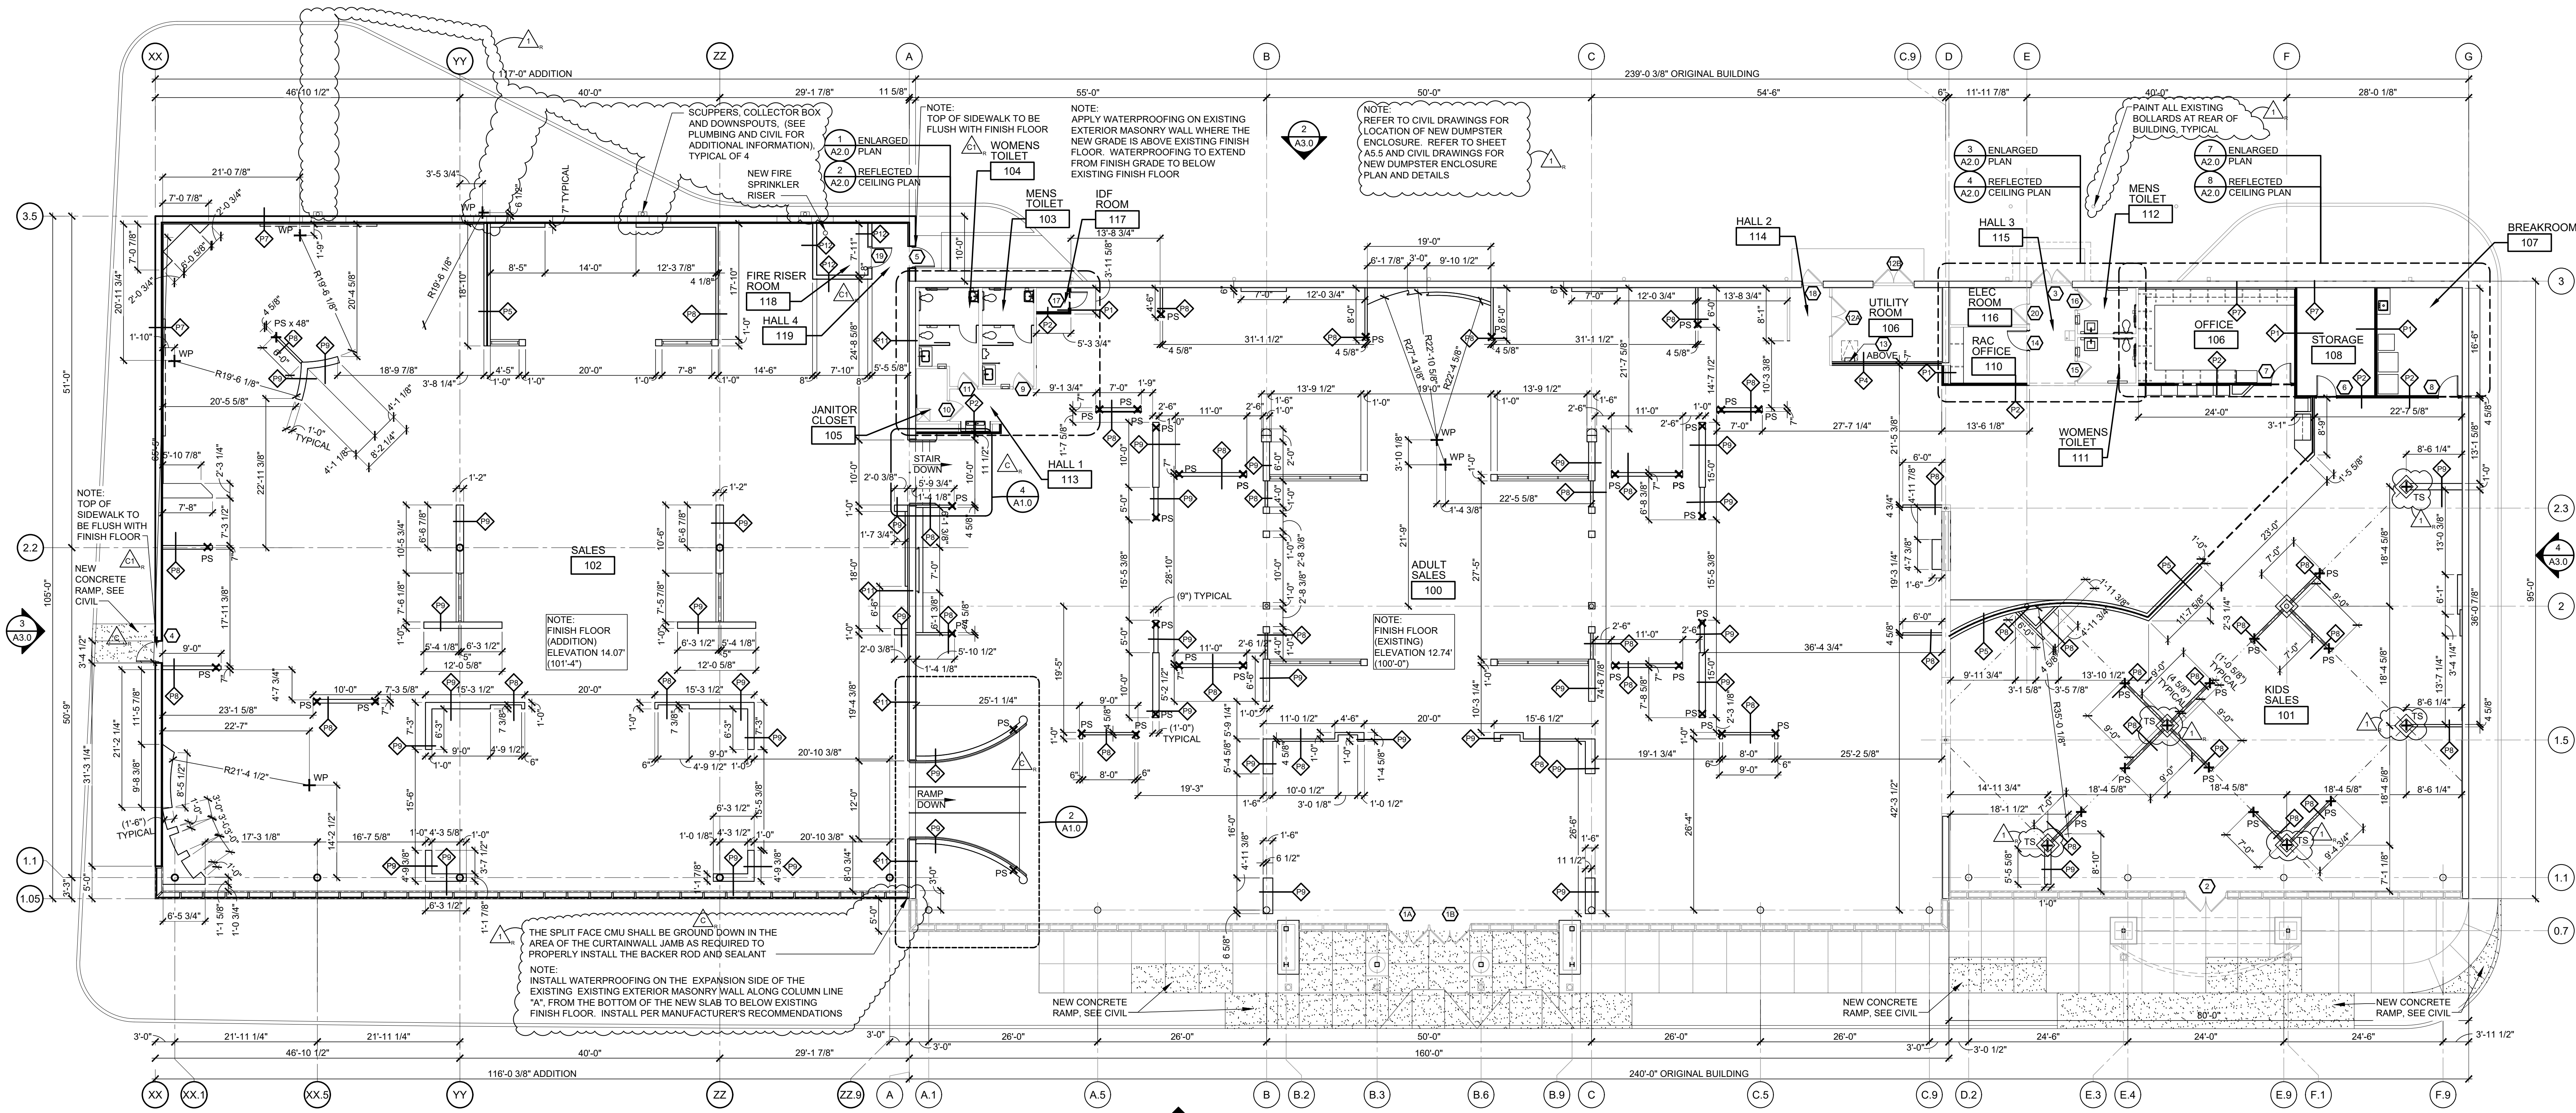


1 FLOOR PLAN
SCALE: 3/32" = 1'-0"
NORTH

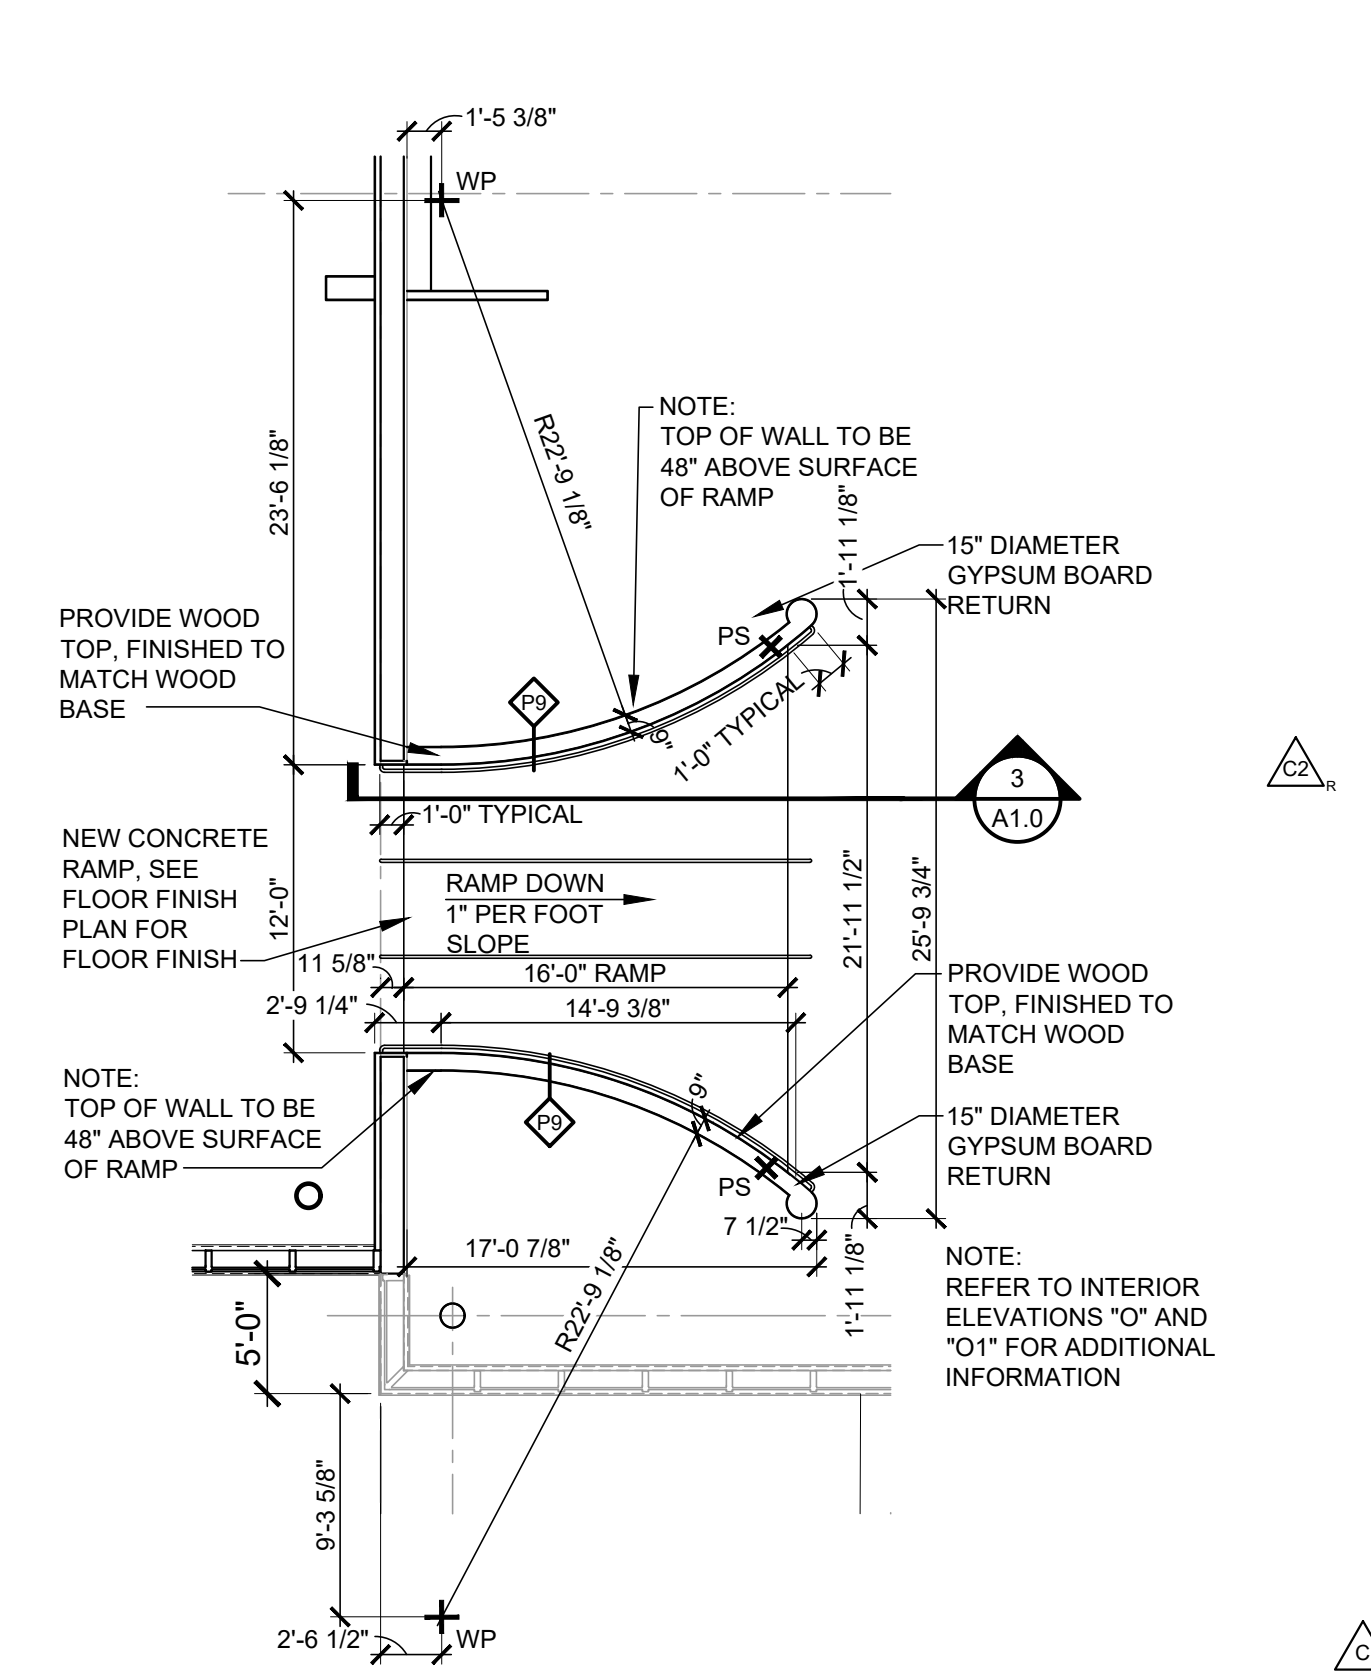


2 ENLARGED RAMP PLAN
SCALE: 1/8" = 1'-0"

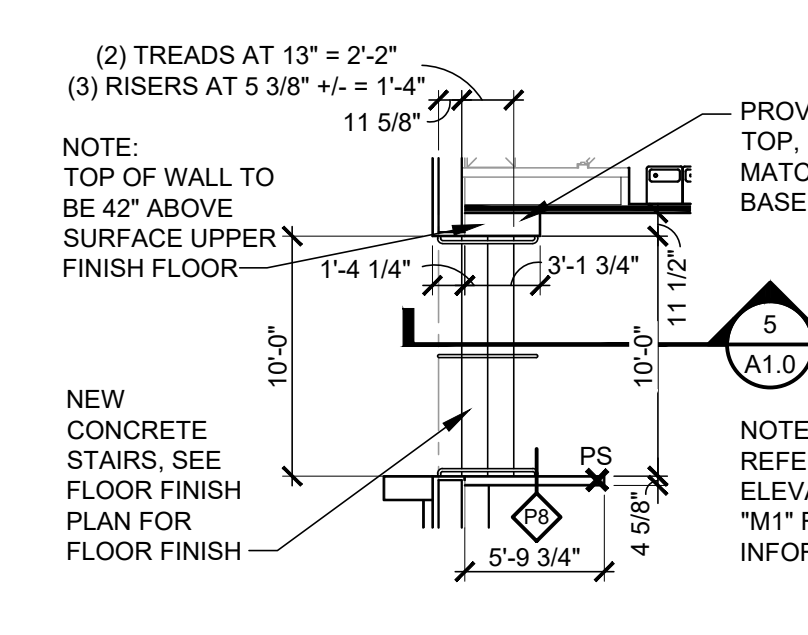

4 ENLARGED STAIR PLAN
SCALE: 1/8" = 1'-0"

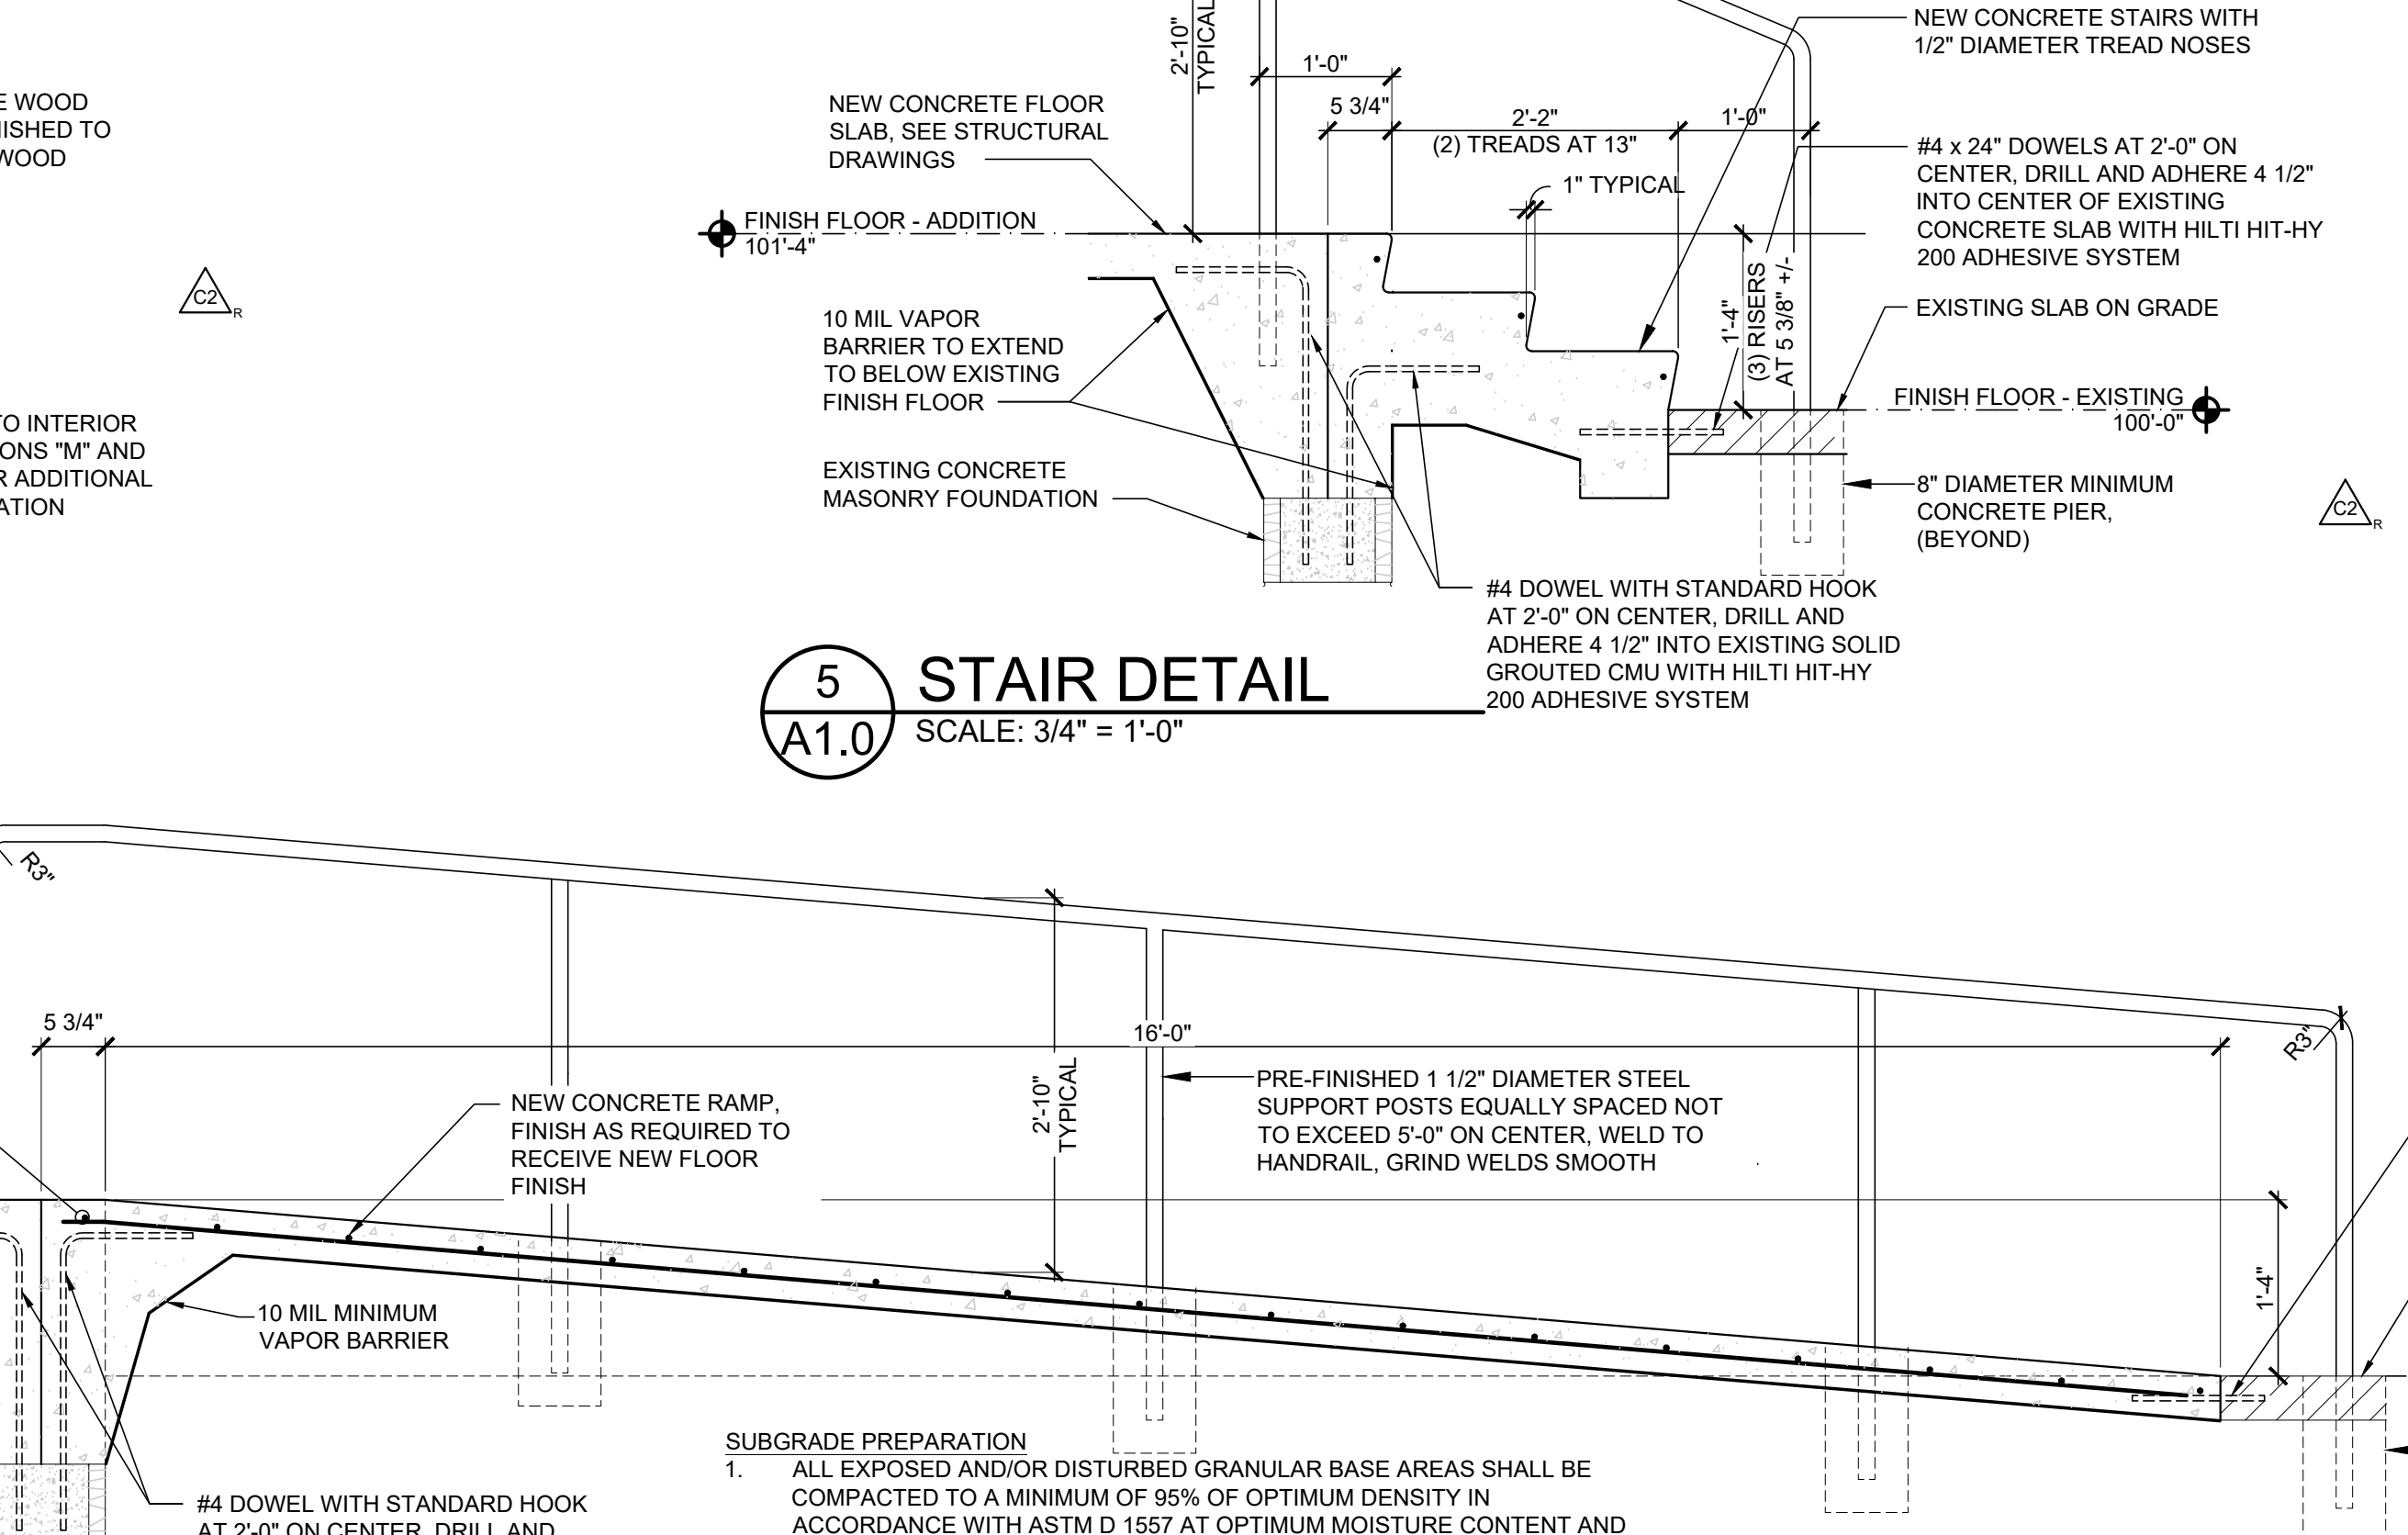

5 STAIR DETAIL
SCALE: 3/4" = 1'-0"

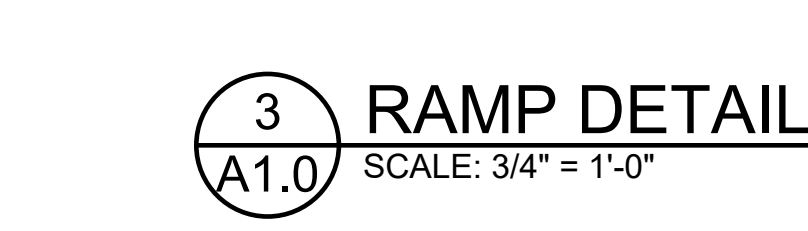

3 RAMP DETAIL
SCALE: 3/4" = 1'-0"

- GENERAL NOTES:**
1. ALL DIAGONAL WALLS AT 45° UNLESS NOTED OTHERWISE
 2. PROVIDE WOOD BLOCKING AT LOCATIONS WHERE ATTACHED TO PARTITIONS. COORDINATE SPECIFIC REQUIREMENTS WITH OWNER'S FIELD REPRESENTATIVE
 3. ALL WOOD BLOCKINGS MUST BE FIRE TREATED WHERE / WHEN REQUIRED BY LOCAL CODE
 4. FIELD COORDINATE ALL GYPSUM BOARD OPENING DIMENSIONS TO ASSURE PROPER FIT OF ALL DECORATIVE ITEMS AND DECORATIVE FRAMES
 5. PROVIDE 1" MOULD AND SEALANT AT GYPSUM BOARD ENDS AND PROVIDE CORNER BEADS AT INTERSECTIONS UNLESS NOTED OTHERWISE
 6. REFER TO THE ACTIVE VERSION OF ASTM C1007, ASTM C955 AND C754 FOR INSTALLATION REQUIREMENTS OF METAL STUDS, RUNNERS, BRACING, BRIDGING AND SCREW ATTACHED GYPSUM BOARD
 7. REFER TO SHEET A1.1 FOR FLOORING INFORMATION
 8. REFER TO SHEET A1.2 FOR INTERIOR ELEVATION CALLOUTS
 9. ALL WALLS ARE DIMENSIONED TO THE FACE OF GYPSUM BOARD UNLESS NOTED OTHERWISE
 10. HOLD INTERIOR DOORS OFF 6" FROM WALL UNLESS NOTED OTHERWISE
 11. VERIFY MASONRY OPENING DIMENSIONS WITH CURTAIN WALL MANUFACTURER
 12. WALLS WHICH ENCOMPASS A BUILDING COLUMN SHALL BE CENTERED ON THE COLUMN, UNLESS NOTED OTHERWISE
 13. REFER TO DETAIL 7 ON SHEET A5.0 FOR DUCT THRU WALL DETAIL
 14. VERTICAL CONTROL JOINTS SHALL BE PROVIDED IN THE FOLLOWING LOCATIONS UNLESS NOTED OTHERWISE:
 - A. EXTERIOR CONCRETE MASONRY WALLS ALIGNED WITH MASONRY CONTROL JOINTS
 - B. INTERIOR PARTITIONS AT 30'-0" ON CENTER MAXIMUM
 - C. DOOR FRAME JAMB LINE AT ONE TOP CORNER D. CEILINGS WITH PERIMETER RELIEF: 50" MAXIMUM EACH WAY. CEILINGS WITHOUT PERIMETER RELIEF: 30" MAXIMUM EACH WAY. COORDINATE LOCATIONS WITH OWNER IF LAYOUT IS NOT INDICATED.
 15. APPLY TERMITTE PREVENTION CHEMICAL TREATMENT PER LOCAL REQUIREMENTS


- SYMBOLS**
- PS INDICATES STEEL ANGLE PARTITION SUPPORT LOCATION - SEE DETAIL (A1.1)
 - TS INDICATES STEEL TUBE PARTITION SUPPORT LOCATION - SEE DETAIL (A1.1)
 - ◆ PARTITION TYPE - INTERIOR PARTITIONS ARE TYPE "P1" UNLESS NOTED OTHERWISE. SEE DETAILS (A1.0)
 - EJ EXPANSION JOINTS TYPICAL, REFER TO CIVIL FOR FURTHER INFORMATION
 - CJ CONTROL JOINTS TYPICAL, REFER TO CIVIL FOR FURTHER INFORMATION
 - WP WORK POINT - LOCATED FROM A COLUMN GRID LINE TYPICAL
 - DOOR NUMBER - REFER TO SHEET A8.0
 - LOCATED WITHIN A PARTITION INDICATES FULL HEIGHT PARTITION - REFER TO PARTITION CALLOUTS ON A1.0 AND PARTITION TYPES A5.0
 - AP METAL ACCESS PANEL (REFER TO ELEVATIONS FOR ACCESS PANEL SIZE AND MATERIAL SPECIFICATION SHEET A1.2 FOR MANUFACTURER, TYPICAL) - WHERE NOT NOTED ON INTERIOR ELEVATIONS ACCESS PANELS ARE TO BE 2'-0" x 2'-0" WITH THE BOTTOM OF THE PANEL AT 10" ABOVE FINISHED FLOOR
 - DECORATIVE ALUMINUM TRUSS

CONSTR. DOC. & REVISIONS	
No.	Description
1	DATE: 12/06/22
2	CODE RESPONSE: 06/13/23
3	FIRE DEPARTMENT CODE RESPONSE #2: 07/10/23
4	FIRE DEPARTMENT CODE RESPONSE #1: 08/12/23
5	CODE COMMENTS RESPONSE: 11/29/23
6	APPENDIX 2


PROFESSIONAL OF RECORD
MICHAEL SCOTT SUNDERMEYER
License No. AR030305
Expiration Date 02/28/25

Drawn By/Checked By: **dir/MSB**
Project Number: **2101445**
Bid Date: **11/09/23**
Permit: **03/28/23**
Owner Date: **07/06/22**

ROOMS TO GO STORE EXPANSION AND REMODEL
18722 SOUTH DIXIE HIGHWAY,
CUTLER BAY, FL 33157

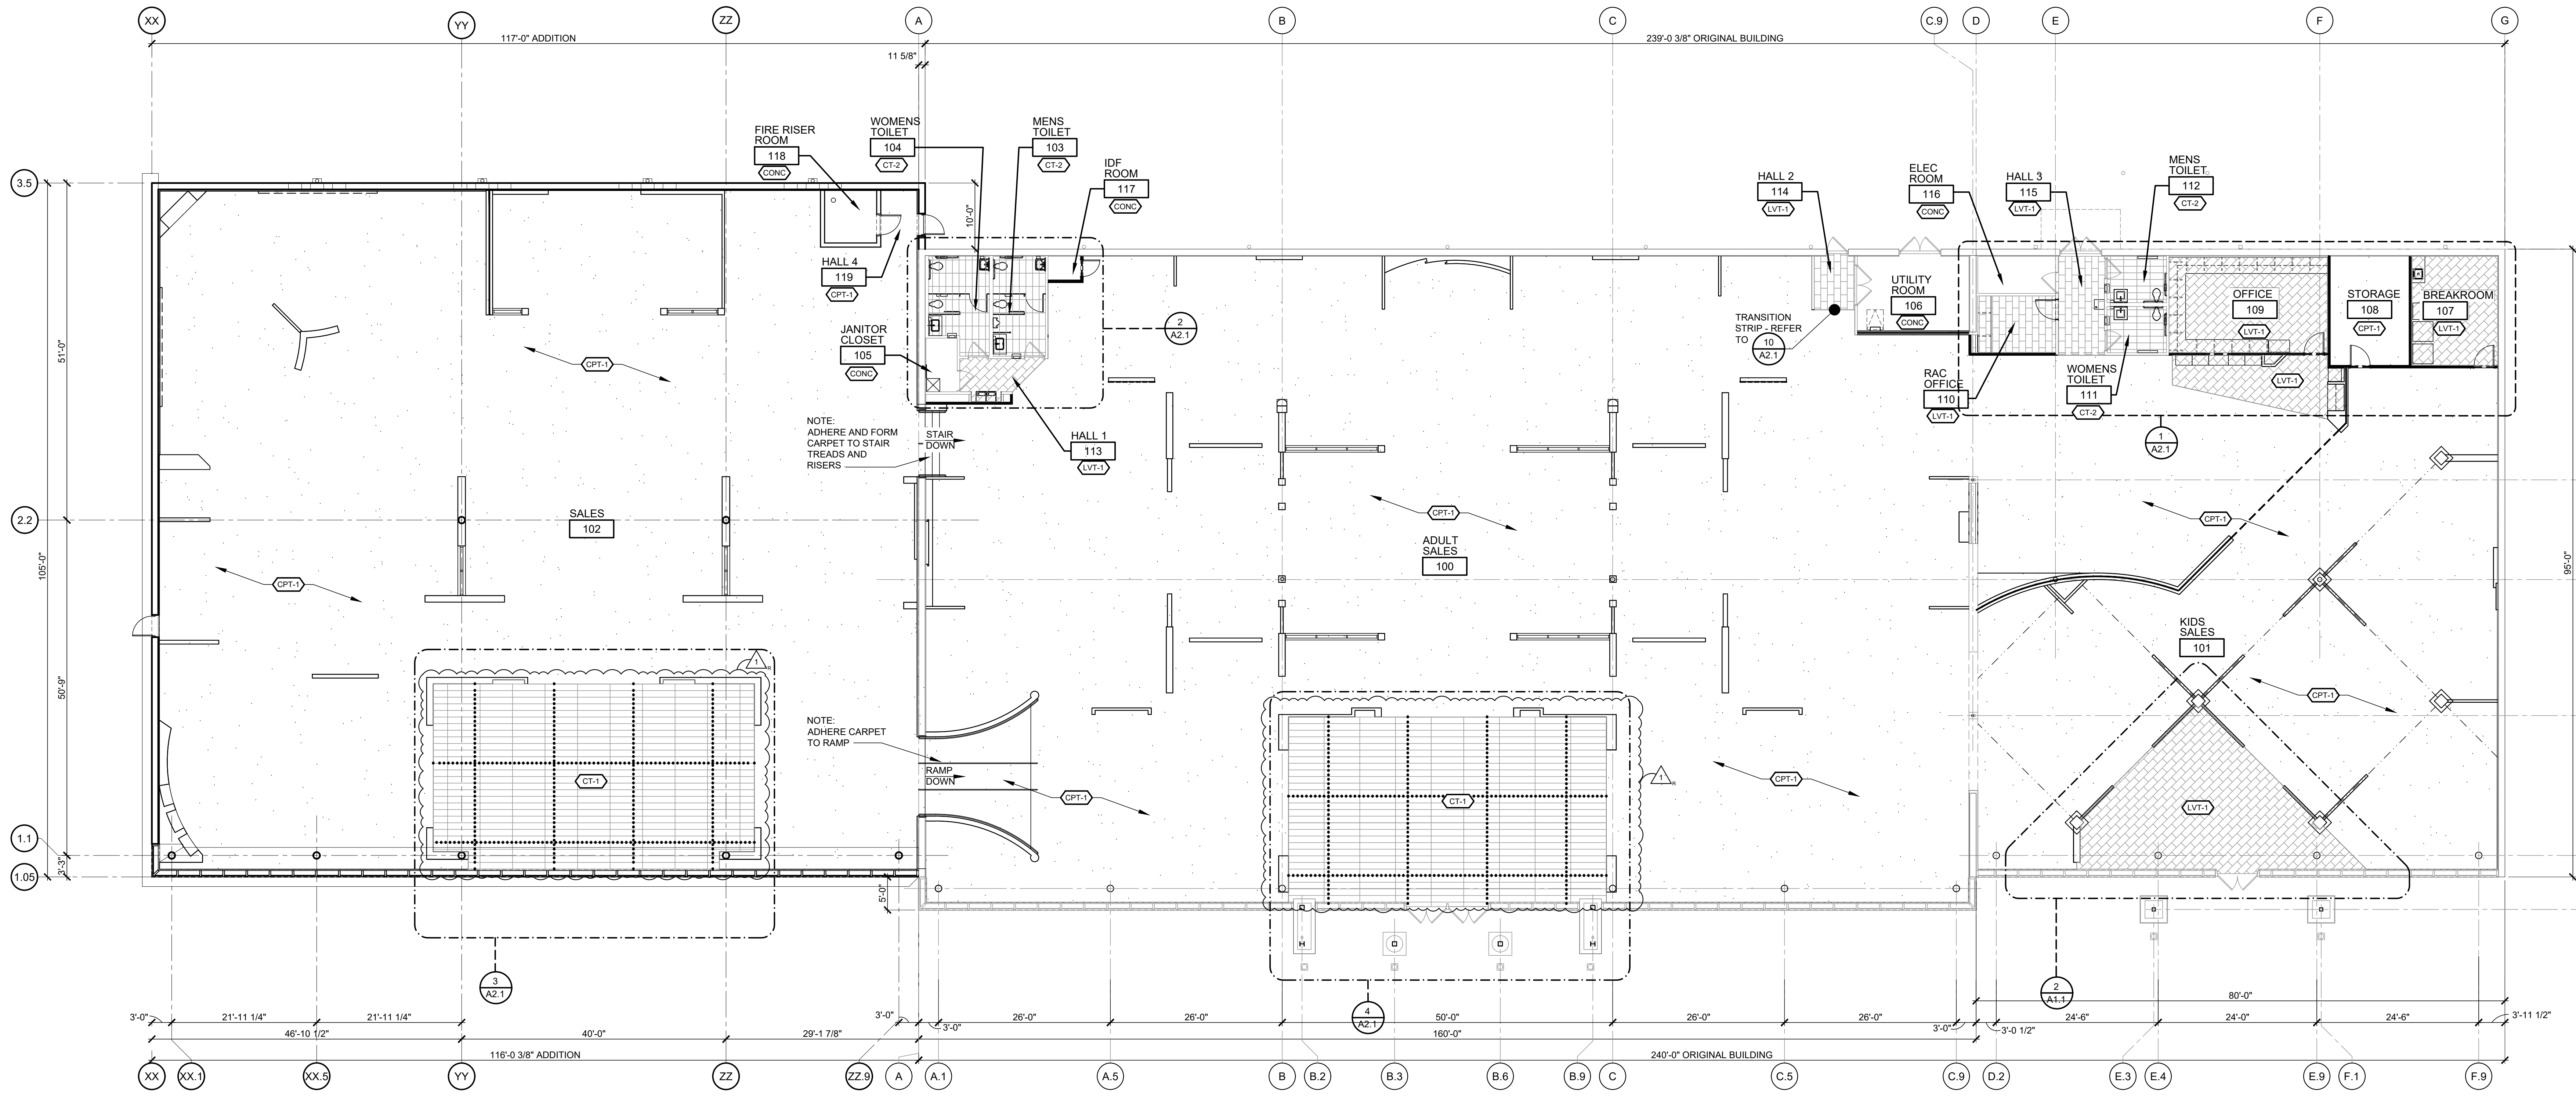


1 FLOOR FINISH PLAN
SCALE: 3/32" = 1'-0"
NORTH

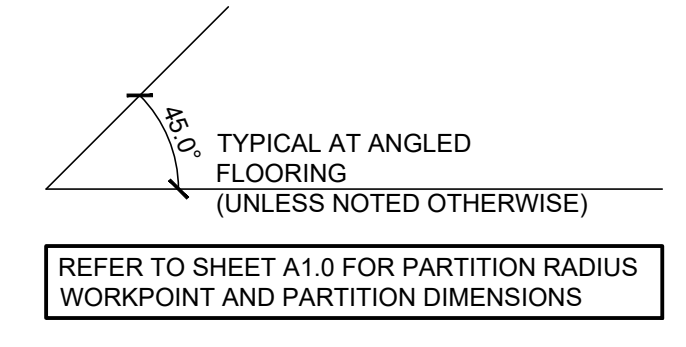

LEGEND
TILE MOVEMENT JOINT
AT 12'-0" ON CENTER
EACH WAY


FLOOR FINISH LEGEND	
LUXURY VINYL TILE	
(LVT-1)	PATCRAFT, SUBSTRACTIVE LAYERS, STYLE: I418V, COLOR: 00100 UNBLEACHED TITANIUM, PATTERN: RUNNING BOND
CARPET	
(CPT-1)	J-J INVISION, RTG 924460722-00113 SOLUTION DYE, SOLID
CERAMIC TILE	
(CT-1)	FLOOR & DECOR, WOODVILLE NATURAL WOOD PLANK, SKU: 100581628, 12" x 59", PATTERN: STACK BOND, GROUT: CUSTOM BUILDING PRODUCTS -PRISM #186 KHAKI 186 SEAL JOINTS PER SPECIFICATIONS.
(CT-2)	DAL TILE, ASTRONOMY, ORION AT71, SIZE 12" x 24", PATTERN: STACK BOND, GROUT: CUSTOM BUILDING PRODUCTS -PRISM #135 MUSHROOM. SEAL JOINTS PER SPECIFICATIONS.
CONCRETE	
(CONC)	EXPOSED CONCRETE WITH SMOOTH TOWELED FINISH. APPLY 2 COATS OF ACRYLIC FLOOR ENAMEL (MEDIUM GRAY COLOR)

FLOOR GENERAL NOTES:
1- IN THE CASE OF VINYL TILE AND CERAMIC TILE, THE PATTERN DEPICTED INDICATES THE FLOOR COVERING JOINT PATTERN
2- DIMENSIONS TO FLOORING FROM COLUMN GRID LINES OR FACE OF GYPSUM BOARD TYPICAL UNLESS NOTED OTHERWISE
3- LUXURY VINYL TILE SHALL BE INSTALLED PER MANUFACTURERS GLUE DOWN INSTALLATION GUIDELINES.

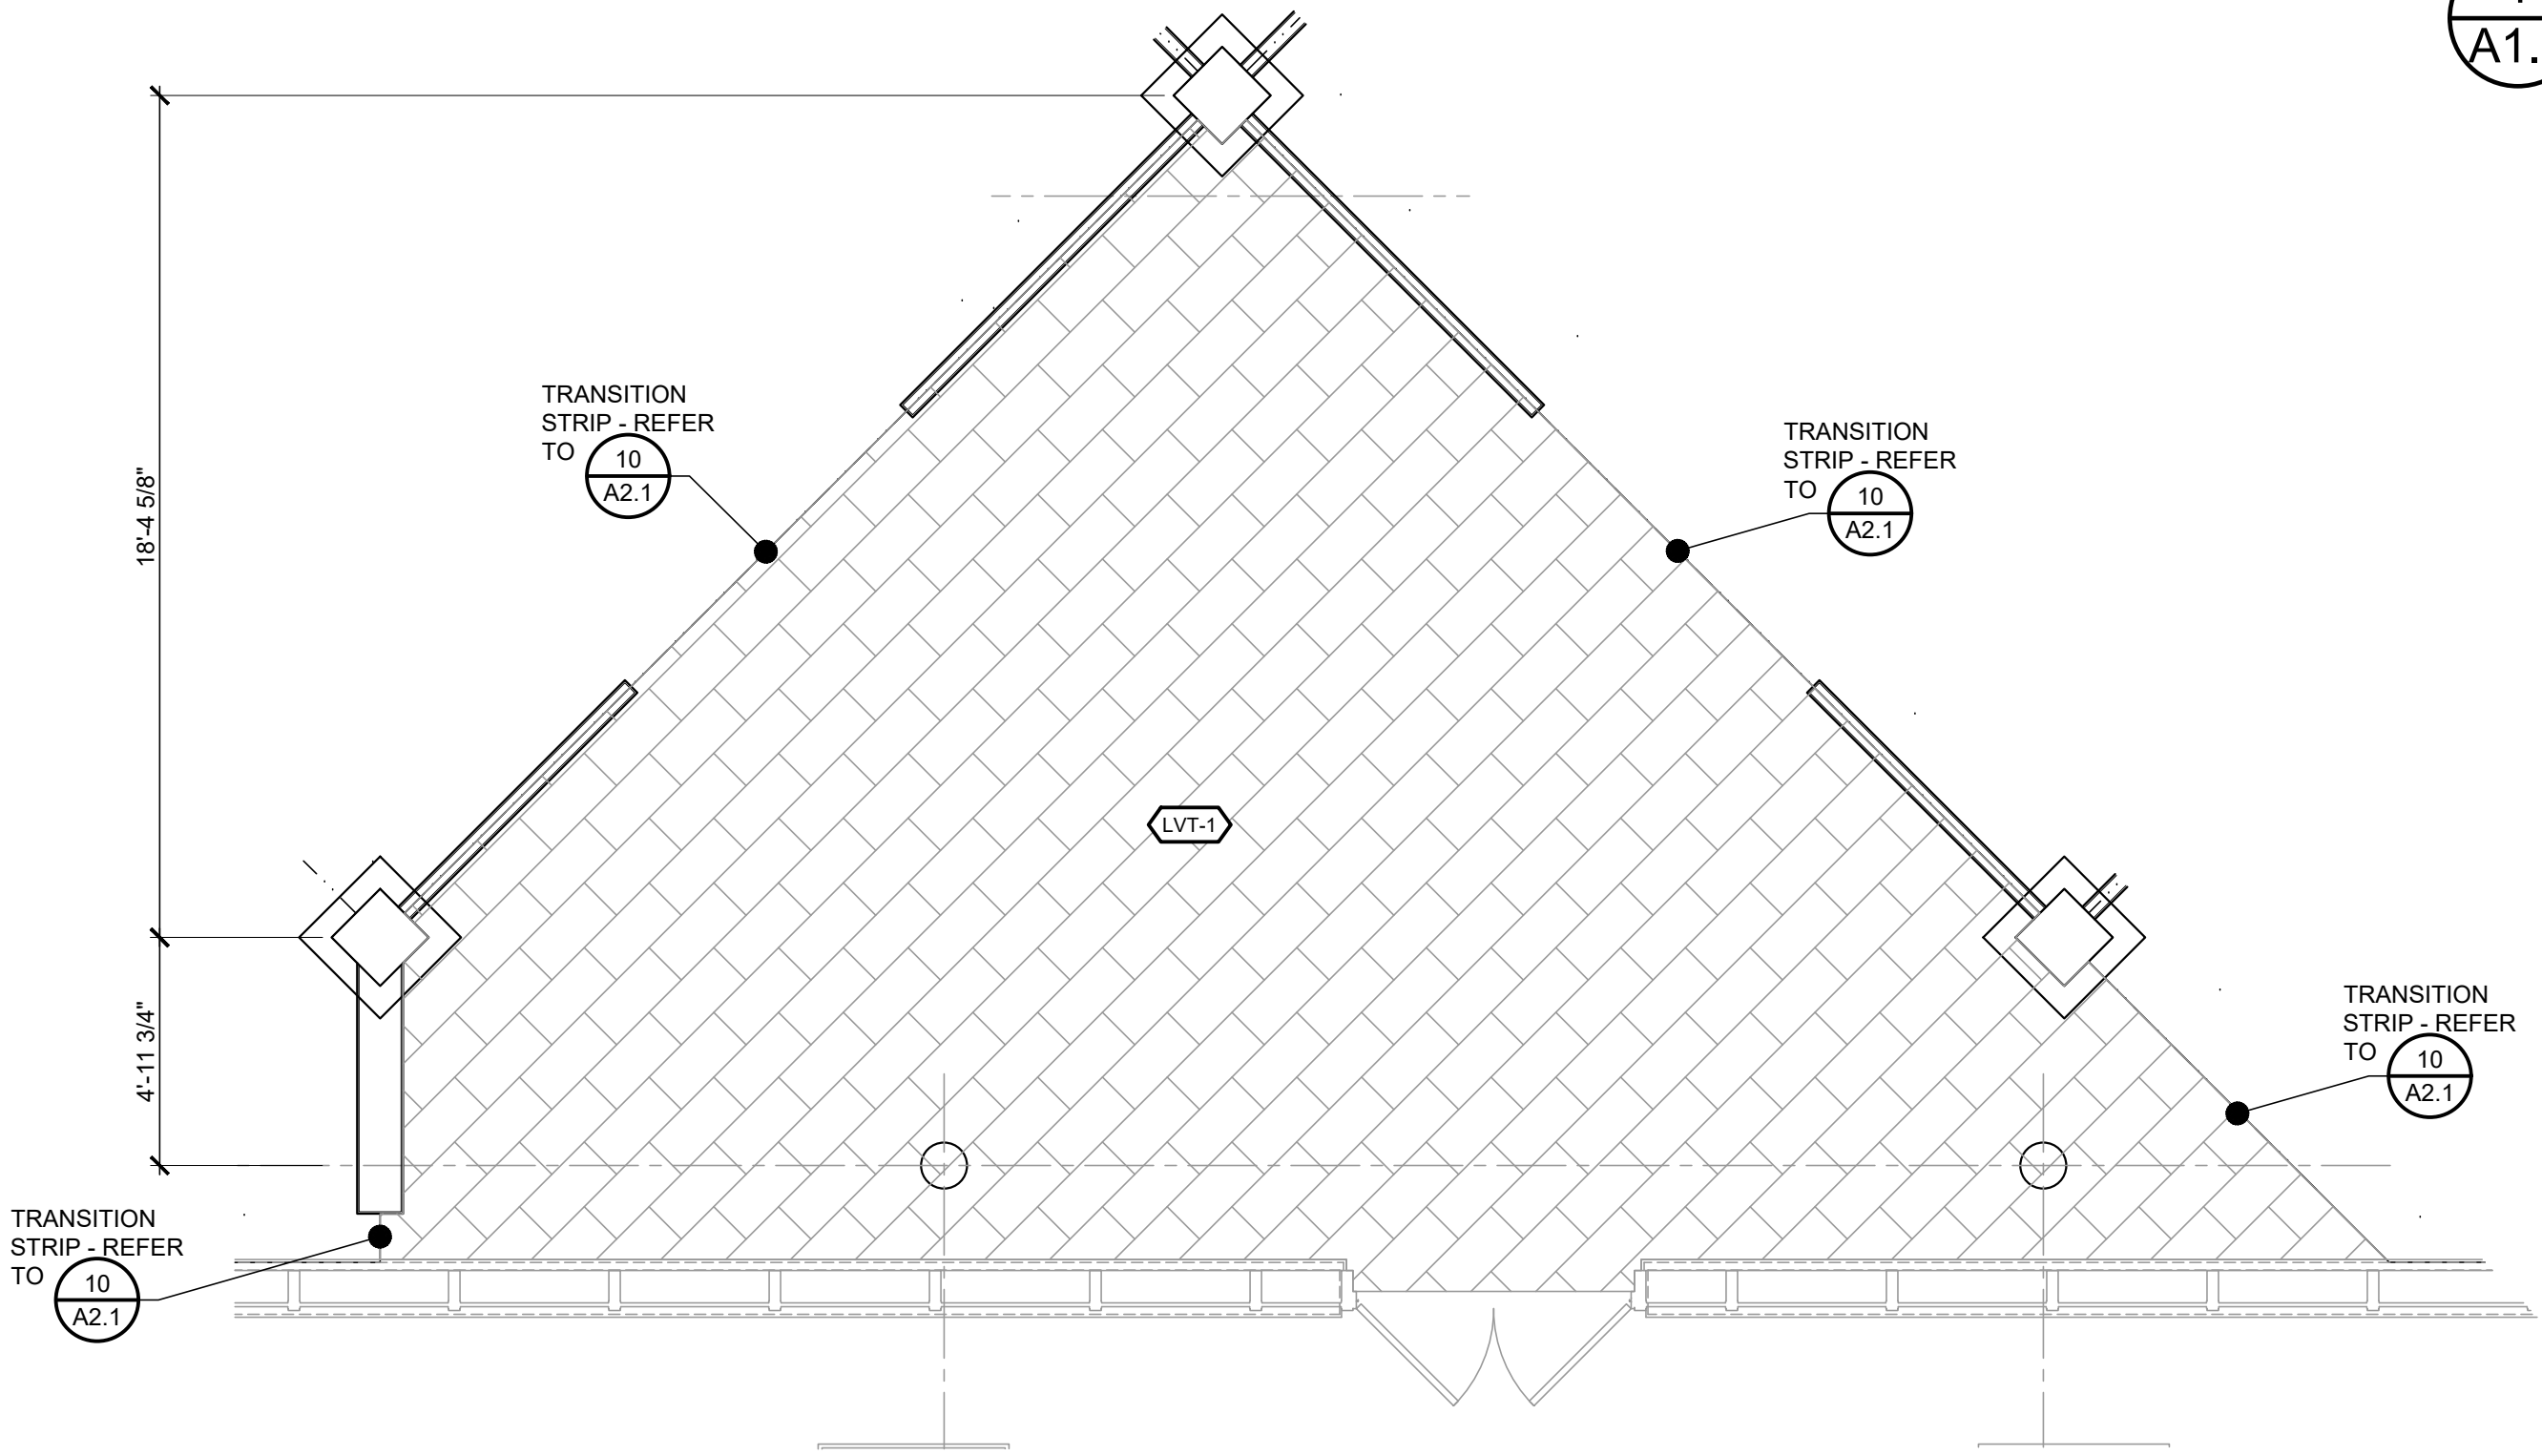


2 FLOORING PLAN
SCALE: 1/4" = 1'-0"
NORTH

CONSTR. DOC. & REVISIONS
Date: 11/29/23
Description: 1 ADDENDUM 2

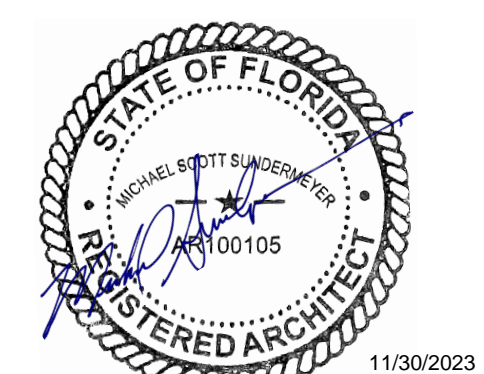


Drawn By/Checked By: dir/MSB
Project Number: 2101445
Bid Date: 11/09/23
Permit: 03/28/23
Owner Date: 07/06/22


FLOOR FINISH PLAN
A1.1

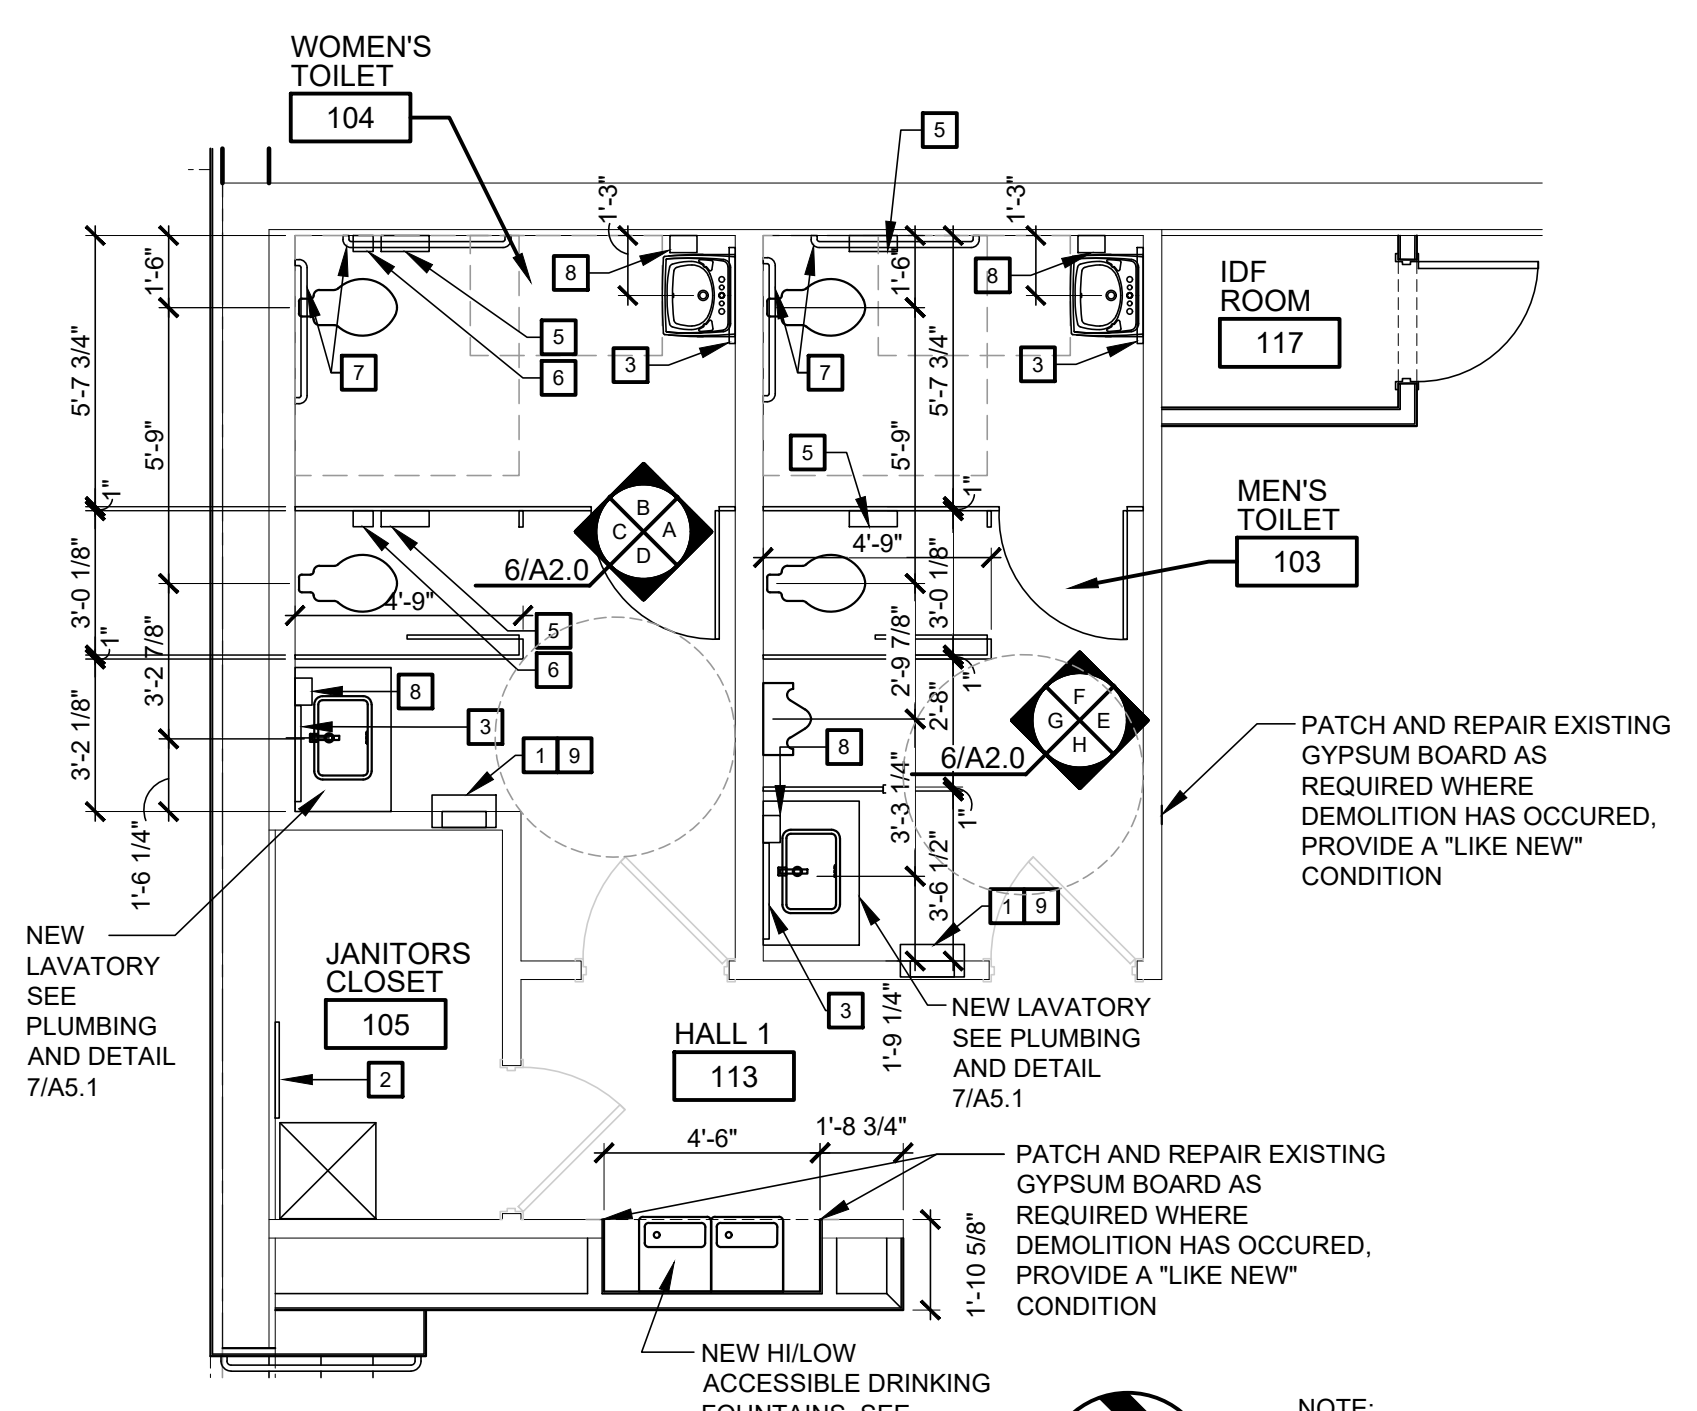


1 FLOOR PLAN
A2.0 SCALE: 1/4" = 1'-0"

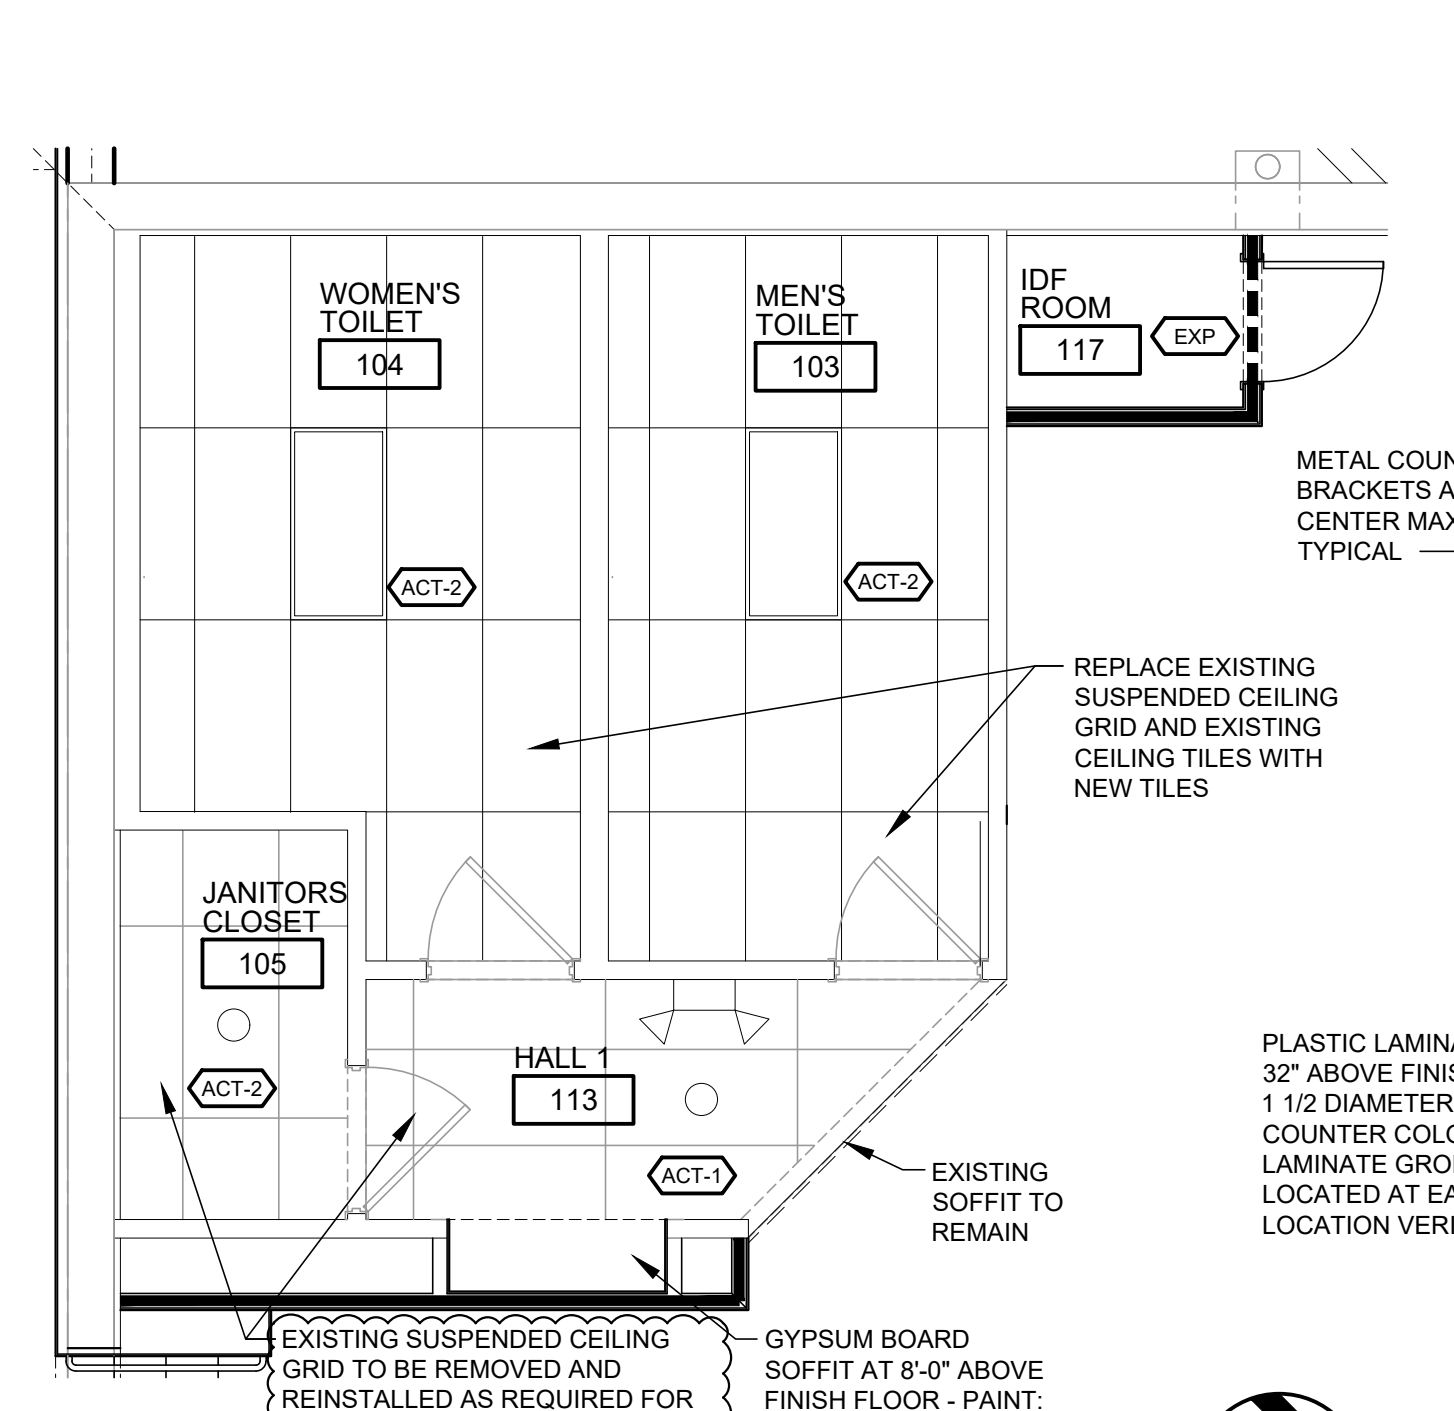

2 REFLECTED CEILING PLAN
A2.0 SCALE: 1/4" = 1'-0"

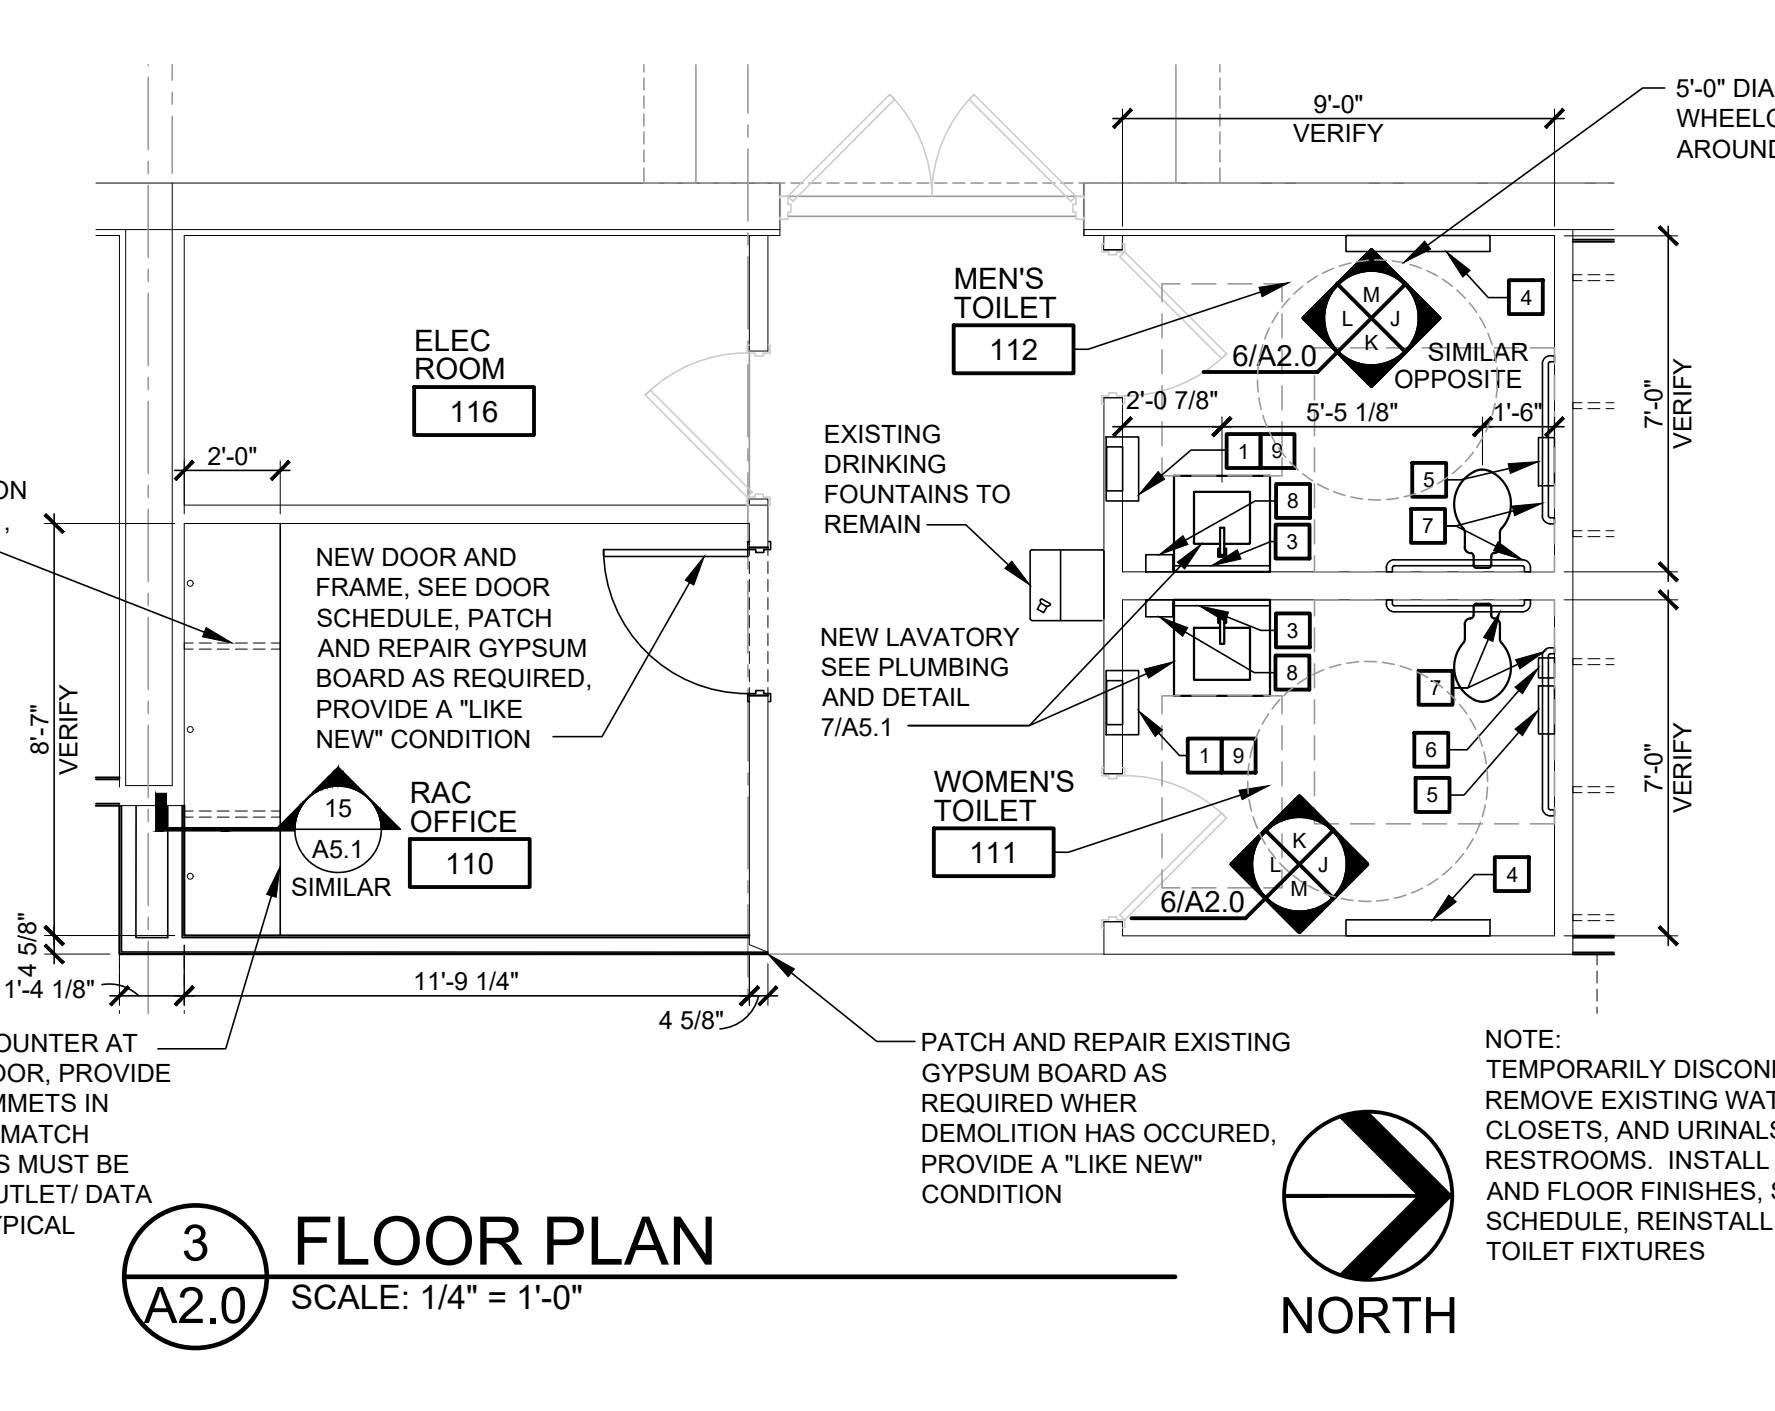

3 FLOOR PLAN
A2.0 SCALE: 1/4" = 1'-0"

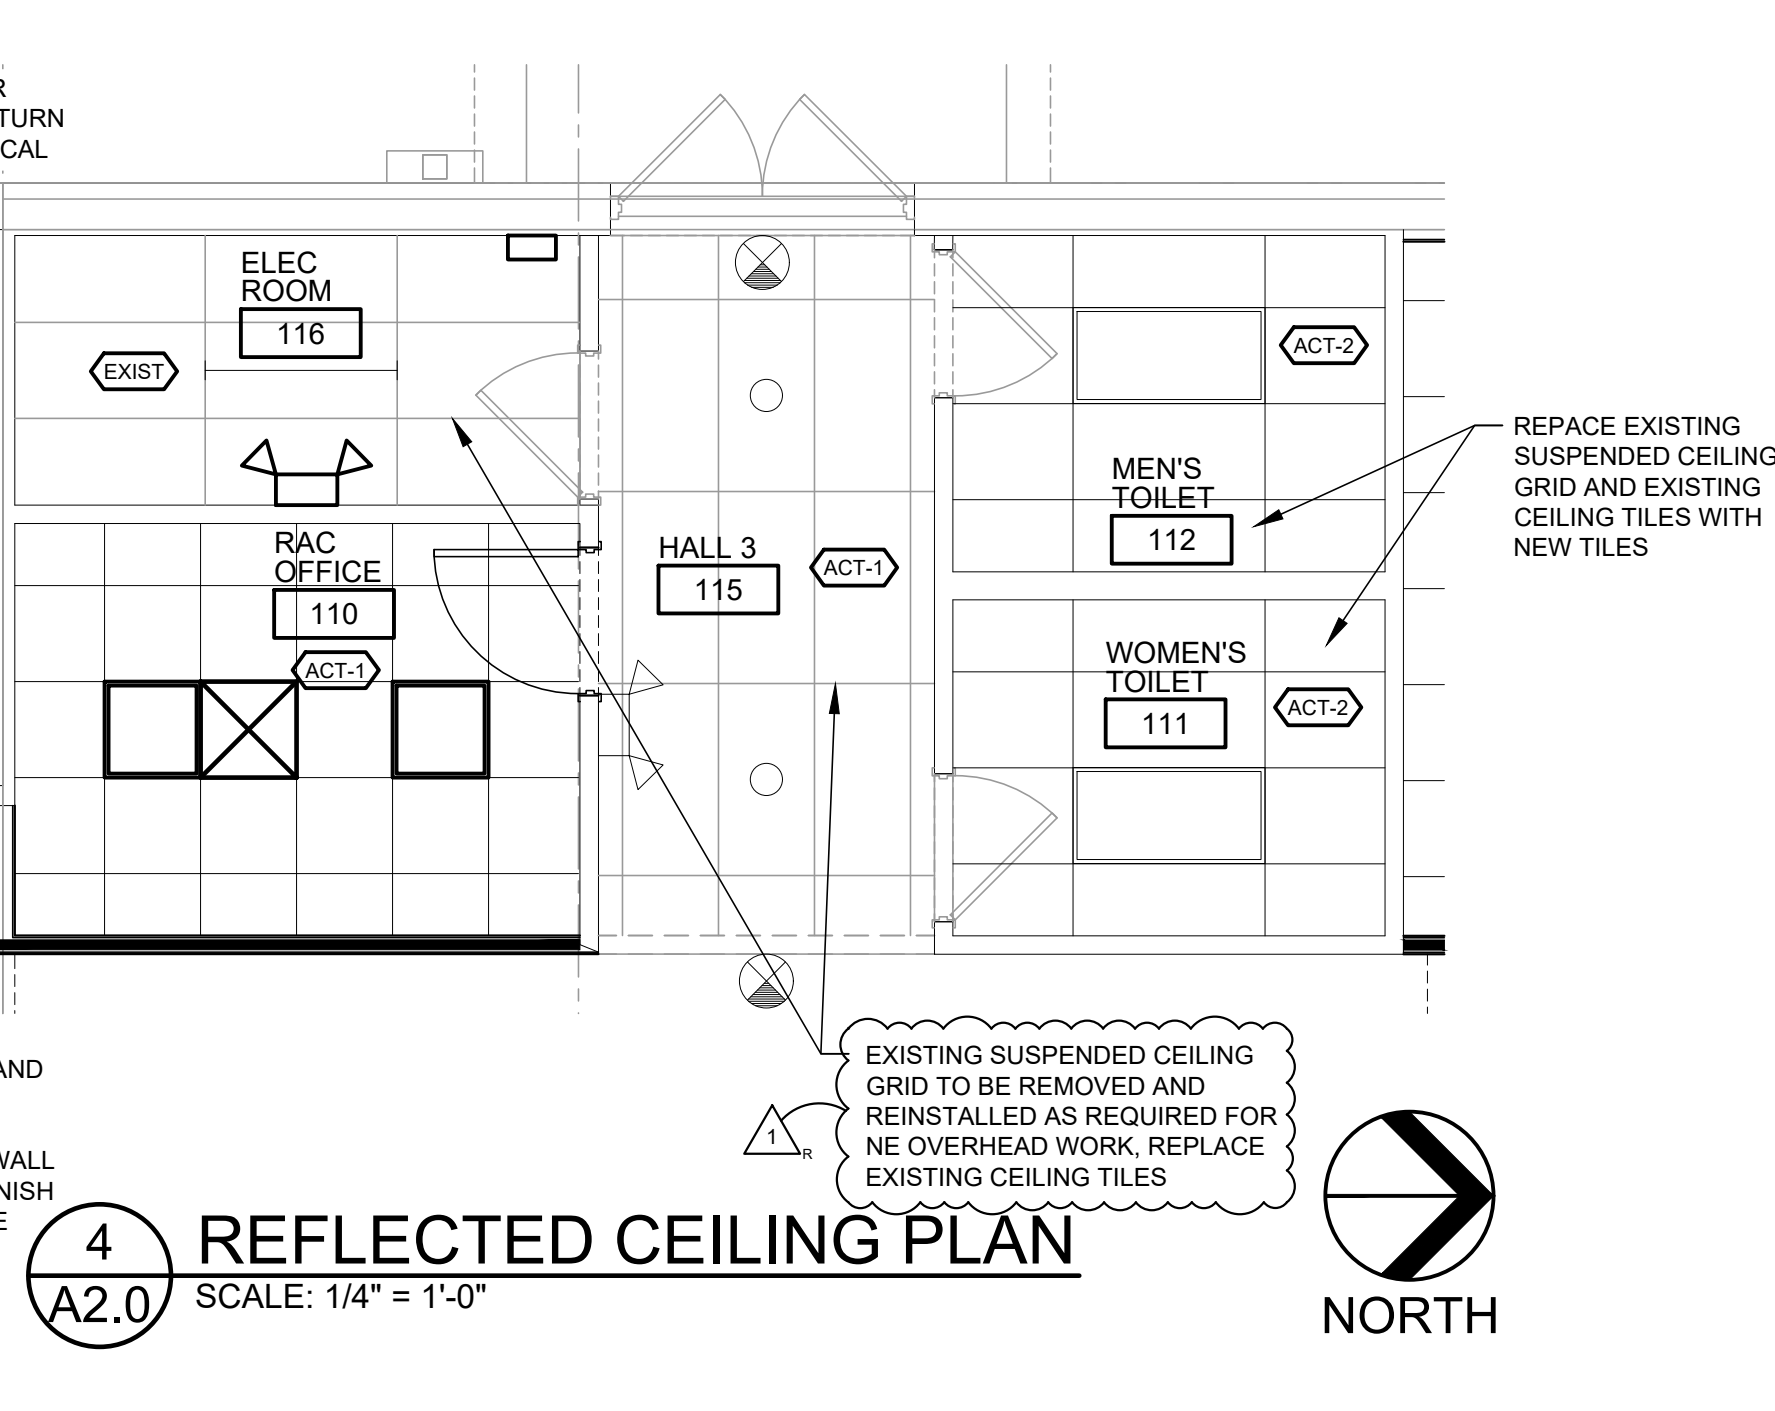


4 REFLECTED CEILING PLAN
A2.0 SCALE: 1/4" = 1'-0"

FLOOR PLAN GENERAL NOTES


- HOLD INTERIOR DOORS OFF 6" FROM WALL UNLESS NOTED OTHERWISE
- ALL INTERIOR DIMENSIONS SHOWN ARE TO FACE OF GYPSUM BOARD
- ALL ANGLED WALLS SHOWN ARE AT 45° UNLESS NOTED OTHERWISE
- DIMENSIONS TO CENTER OF TOILET FIXTURES TYPICAL

REFLECTED CEILING PLAN LEGEND


- FULL HEIGHT WALL - REFER TO PARTITION TYPES
- GYPSUM BOARD SOFFIT ABOVE DOORWAY / WALL OPENING TO CONTINUE TO STRUCTURE ABOVE
- CEILING MATERIAL - REFER TO ROOM FINISH SCHEDULE ON SHEET A8.0
- RECESSED LIGHT FIXTURE - REFER TO ELECTRICAL
- SURFACE MOUNTED STRIP LIGHT FIXTURE - REFER TO ELECTRICAL
- SUPPLY AIR DIFFUSER - REFER TO MECHANICAL
- EXHAUST DIFFUSER - REFER TO MECHANICAL
- RECESSED DOWNLIGHT - REFER TO ELECTRICAL
- EXIT LIGHT FIXTURE - REFER TO ELECTRICAL
- EMERGENCY LIGHT FIXTURE - REFER TO ELECTRICAL

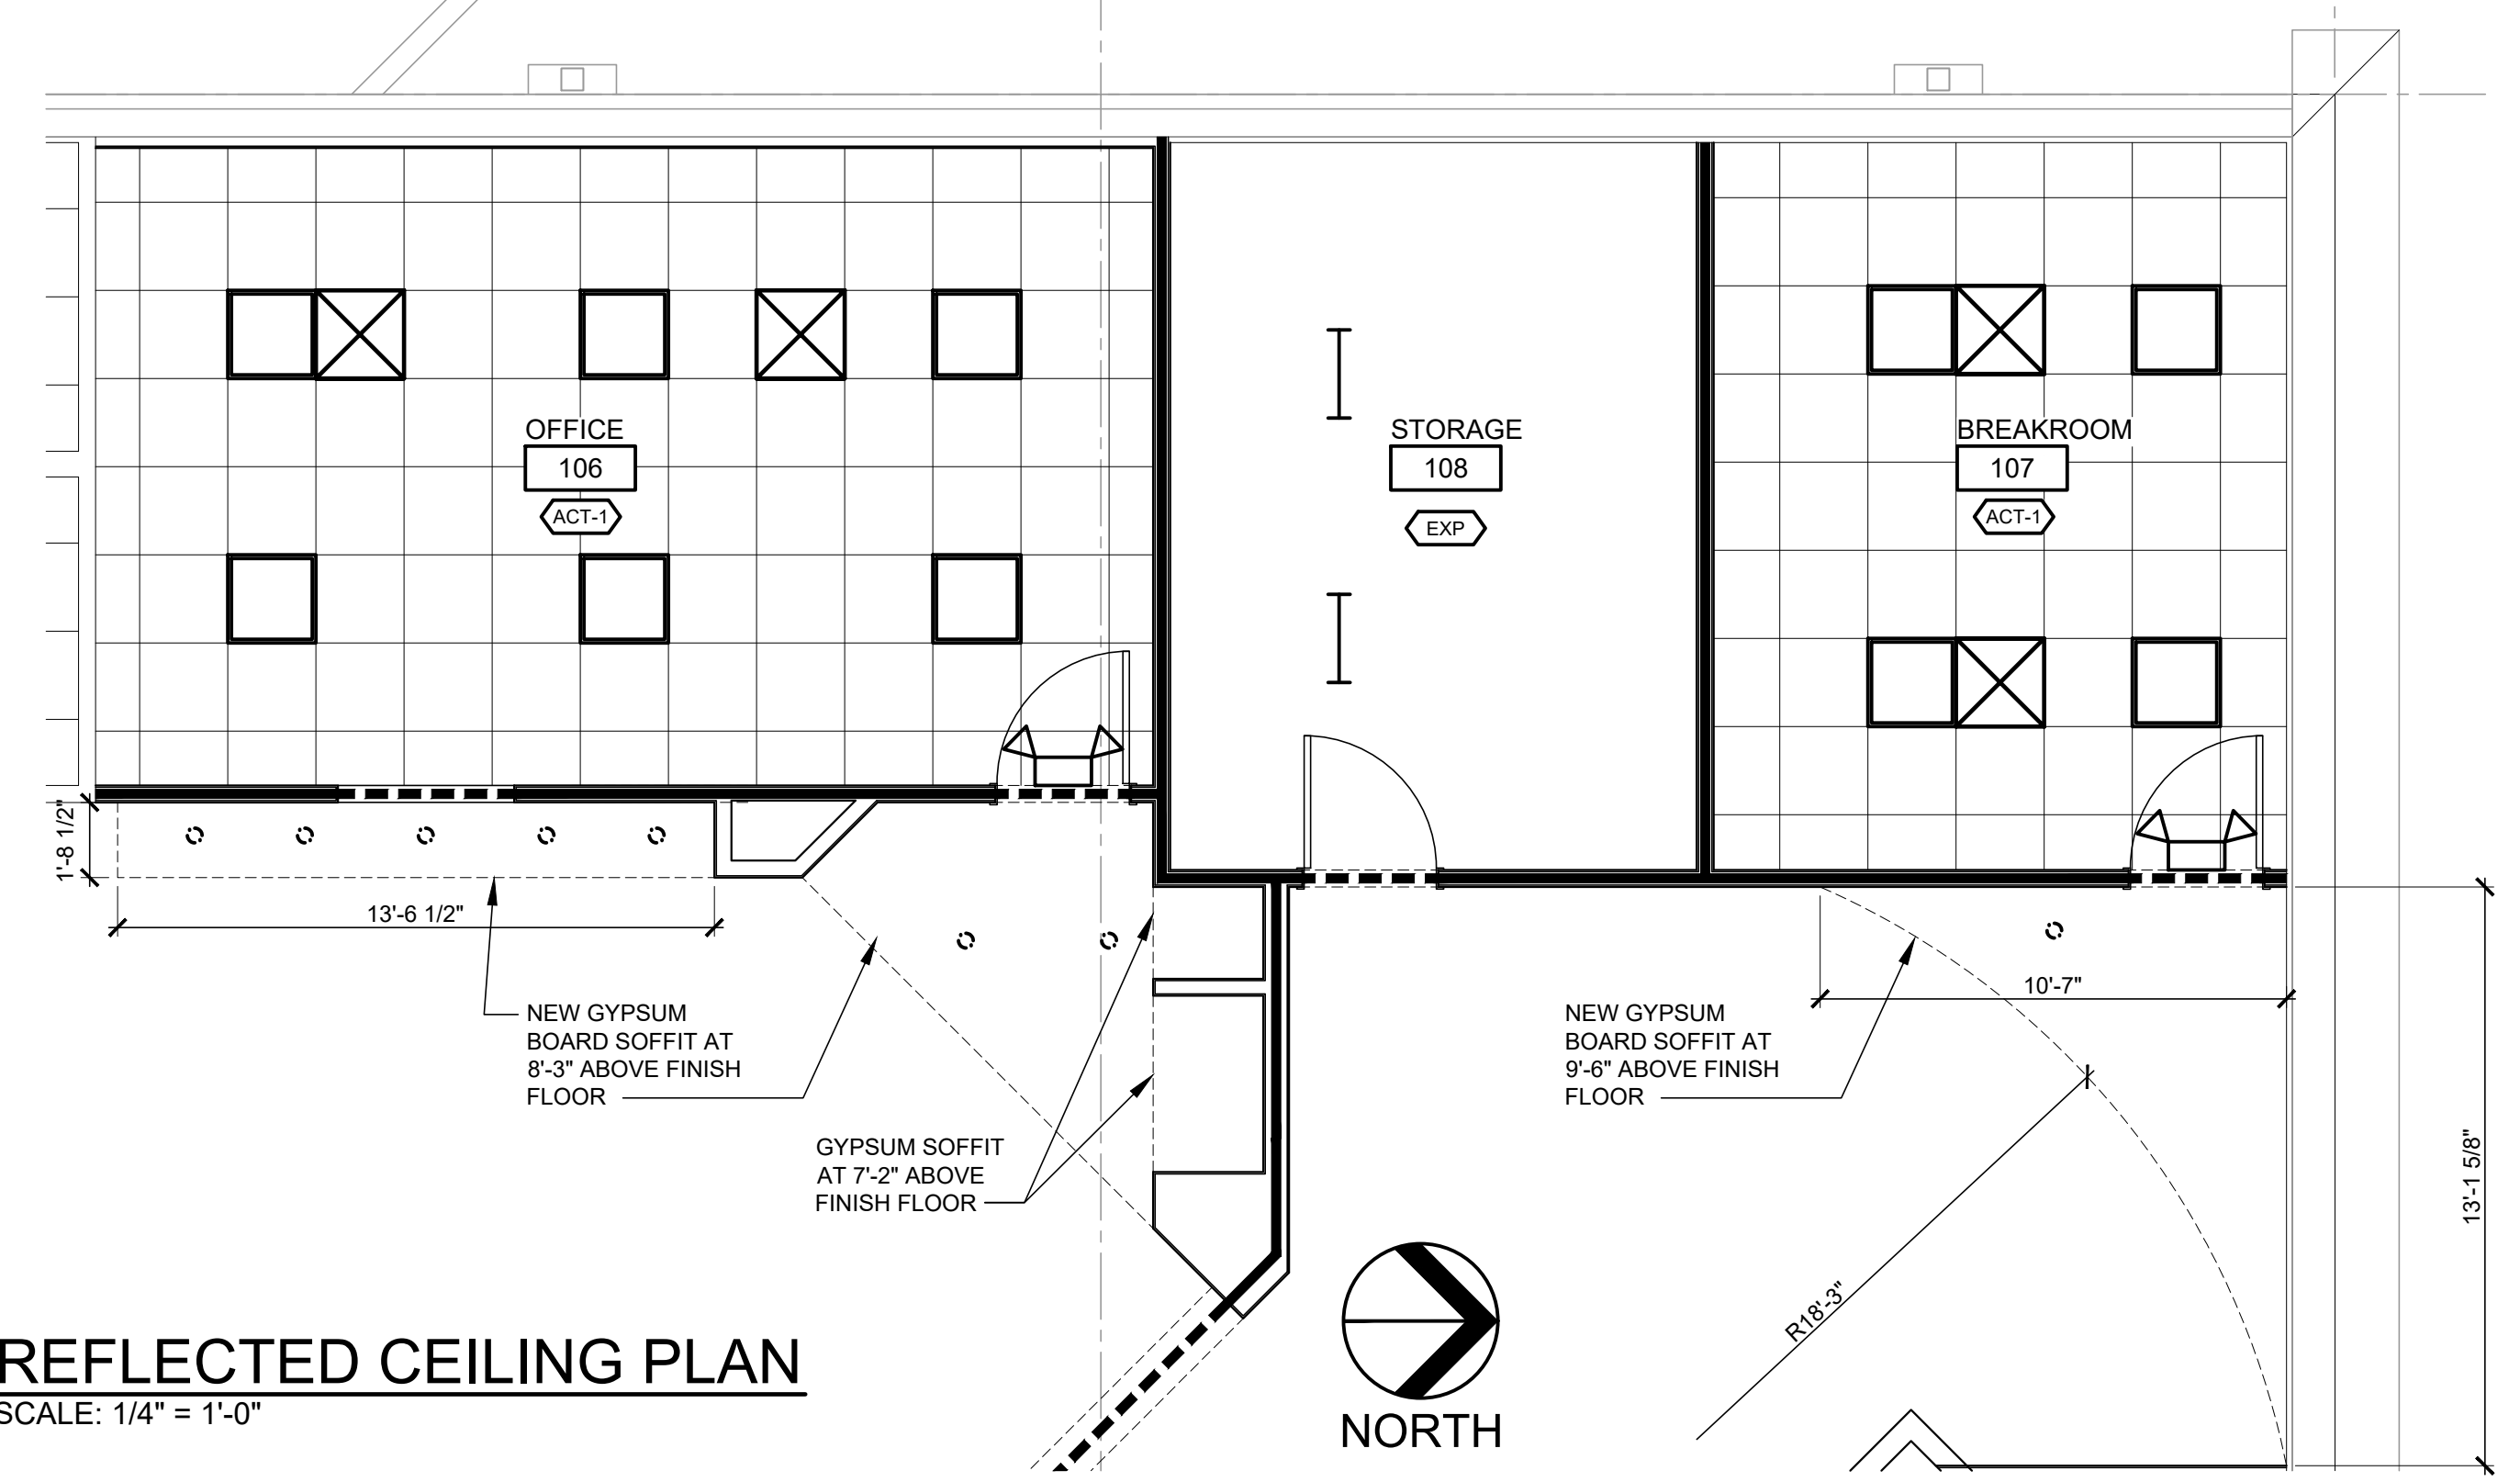

8 REFLECTED CEILING PLAN
A2.0 SCALE: 1/4" = 1'-0"

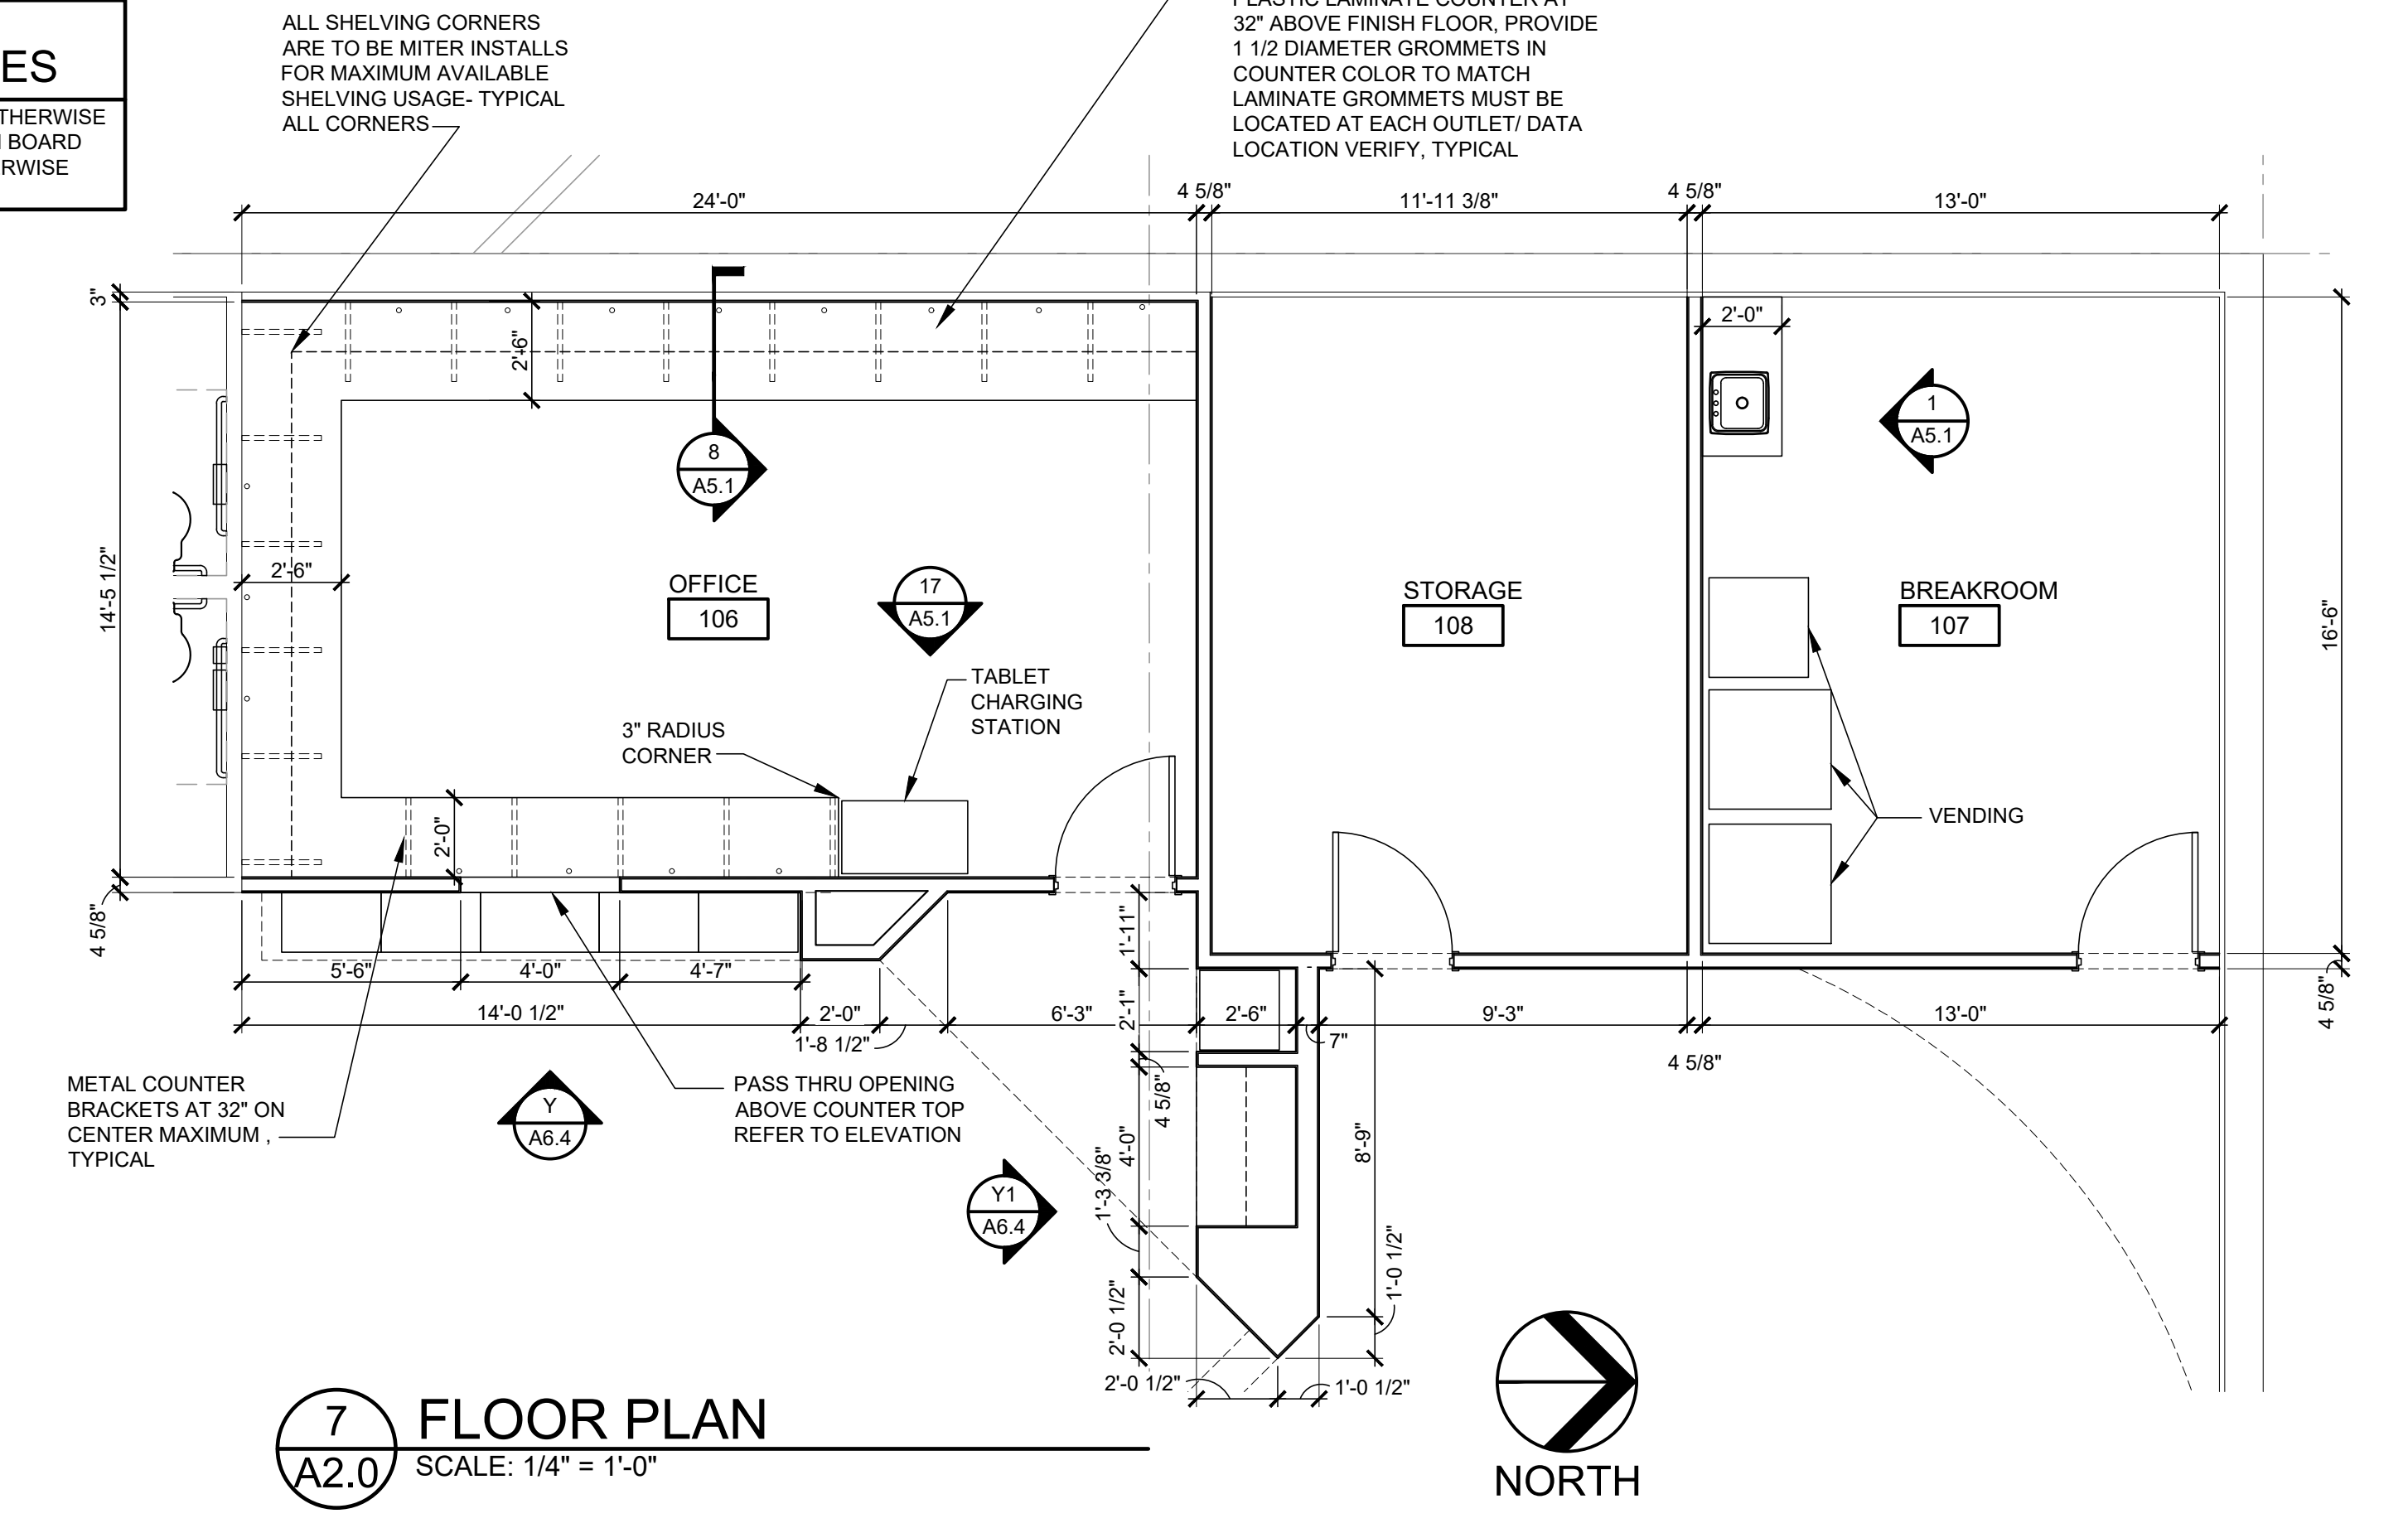


7 FLOOR PLAN
A2.0 SCALE: 1/4" = 1'-0"

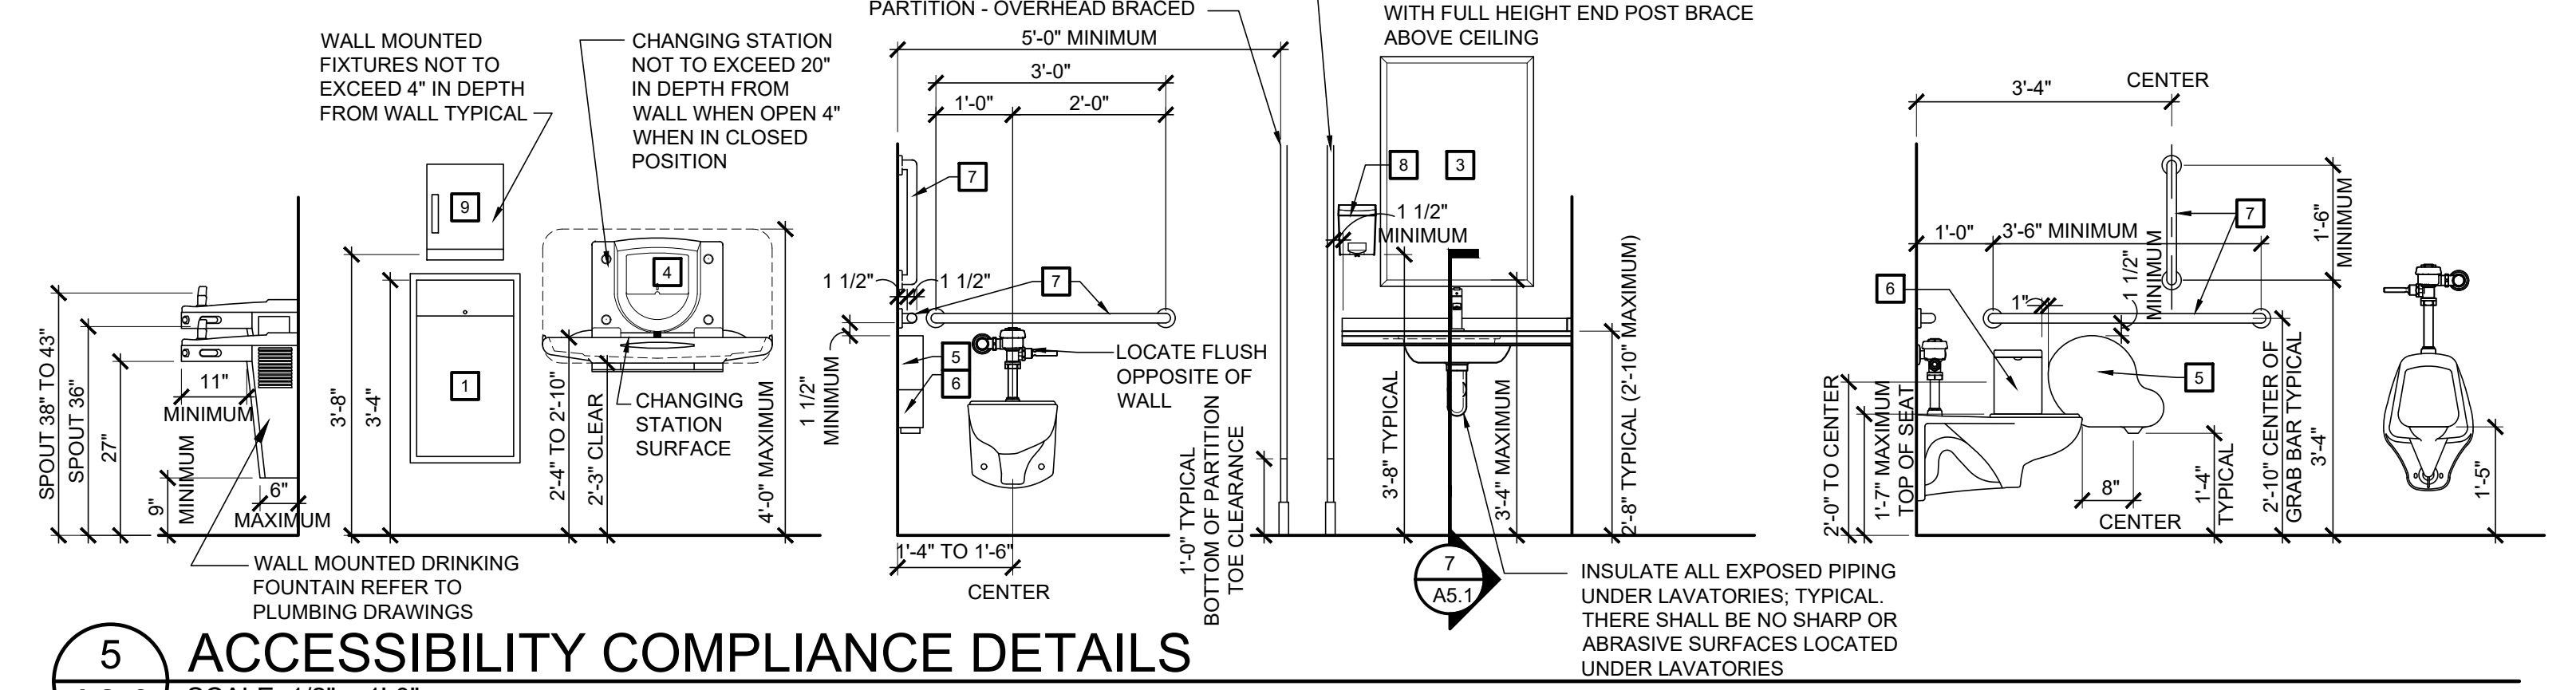

5 ACCESSIBILITY COMPLIANCE DETAILS
A2.0 SCALE: 1/2" = 1'-0"

TOILET ACCESSORIES					
NUMBER	DESCRIPTION	MANUFACTURER	CATALOG NUMBER	FINISH	REMARKS
1	WASTE RECEPTACLE (SEMI-RECESSED)	BOBRICK	B-3644	STAINLESS STEEL	THE OPERATING PARTS OF ANY DISPENSING / DISPOSAL FIXTURE SHALL BE WITHIN 48" MAXIMUM OF FINISHED FLOOR
2	MOP HOLDER	BOBRICK	B-223x24	STAINLESS STEEL	MOUNT CENTER AT 5'-0" ABOVE FINISHED FLOOR
3	MIRROR	BOBRICK	B-165-2436	STAINLESS STEEL	MOUNT AT 3'-4" ABOVE FINISHED FLOOR TO BOTTOM EDGE OF REFLECTIVE SURFACE
4	BABY CHANGING STATION	AMERICAN SPECIALTIES, INC.	9012	FACTORY	SEE ACCESSIBILITY COMPLIANCE DETAILS ON THIS SHEET FOR MOUNTING HEIGHT INFORMATION
5	TOILET PAPER HOLDER	BY OWNER			MOUNT TO MAINTAIN 1 1/2" MINIMUM CLEAR FROM GRAB BAR ABOVE. LOCATE CENTER LINE 7" MINIMUM 9" MAXIMUM FROM FRONT OF TOILET AND 15" MINIMUM ABOVE FINISHED FLOOR TO CENTER OF DISPENSER OPENING
6	FEMININE NAPKIN DISPOSAL	BOBRICK	B-270	STAINLESS STEEL	MOUNT AT 2'-0" ABOVE FINISHED FLOOR TO CENTER OF DISPOSAL MOUNT ADJACENT TO TOILET PAPER HOLDER
7	GRAB BARS	BOBRICK	B-8806-99 18" VERTICAL 36" HORIZONTAL 42" HORIZONTAL	STAINLESS STEEL	18" VERTICAL BAR MOUNT AT 3'-4" ABOVE FINISHED FLOOR TO CENTER OF BOTTOM BAR END. LOCATE BAR 3'-4" FROM REAR WALL. 36" HORIZONTAL BAR MOUNT AT 2'-10" ABOVE FINISHED FLOOR TO CENTER LOCATE ONE END 6" FROM SIDE WALL. 42" HORIZONTAL BAR MOUNT AT 3'-10" ABOVE FINISHED FLOOR TO CENTER LOCATE ONE END 12" FROM REAR WALL
8	SOAP DISPENSER	BY OWNER			MOUNT AT 3'-8" ABOVE FINISHED FLOOR TO CENTER OF NOZZLE
9	HAND TOWEL DISPENSER	BY OWNER			MOUNT AT 3'-8" ABOVE FINISHED FLOOR TO CENTER OF OPERATOR MECHANISM

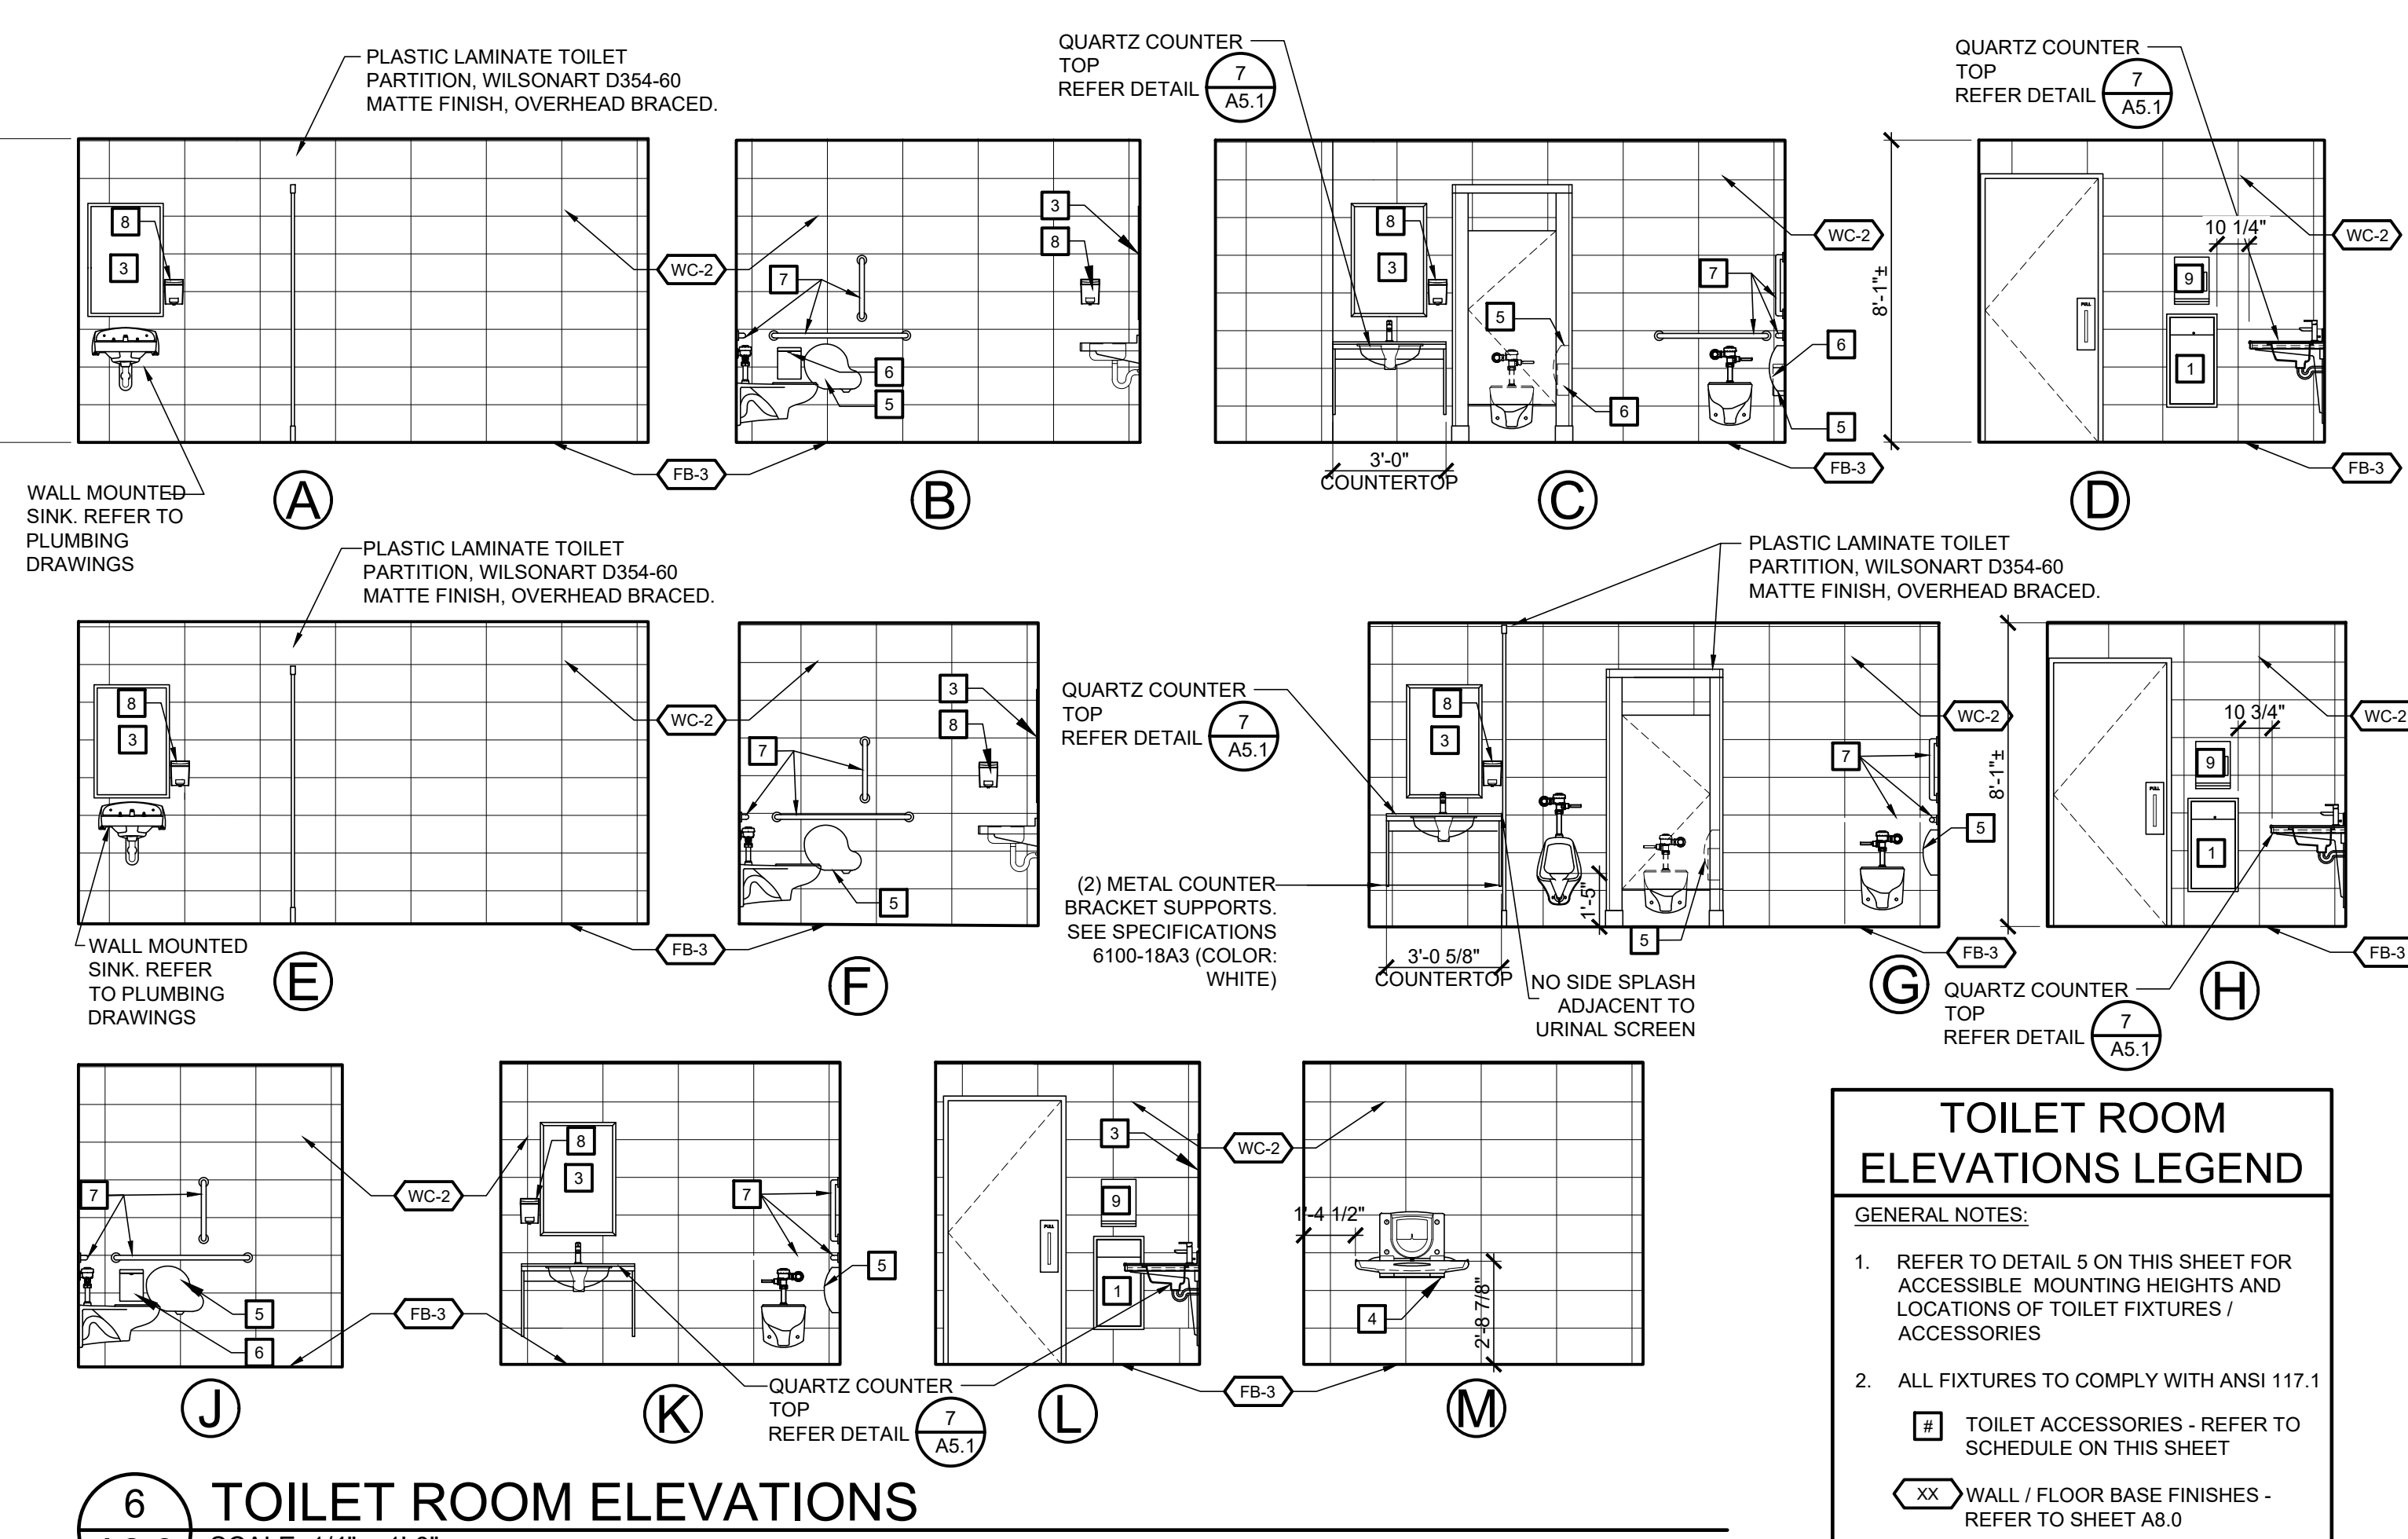

6 TOILET ROOM ELEVATIONS
A2.0 SCALE: 1/4" = 1'-0"

TOILET ROOM ELEVATIONS LEGEND

GENERAL NOTES:

- REFER TO DETAIL 5 ON THIS SHEET FOR ACCESSIBLE MOUNTING HEIGHTS AND LOCATIONS OF TOILET FIXTURES / ACCESSORIES
- ALL FIXTURES TO COMPLY WITH ANSI 117.1

TOILET ACCESSORIES - REFER TO SCHEDULE ON THIS SHEET

XX WALL / FLOOR BASE FINISHES - REFER TO SHEET A8.0

ROOMS TO GO STORE EXPANSION AND REMODEL


18722 SOUTH DIXIE HIGHWAY, CUTLER BAY, FL 33157

Date: 11/29/23
CONSTR. DOC. & REVISIONS



No. Description: 1. ADDENDUM 2

Drawn By/Checked By: dir/MSB
Project Number: 2101445
Bid Date: 11/09/23
Permit: 03/28/23
Owner Date: 07/06/22



ENLARGED PLANS AND ELEVATIONS A2.0

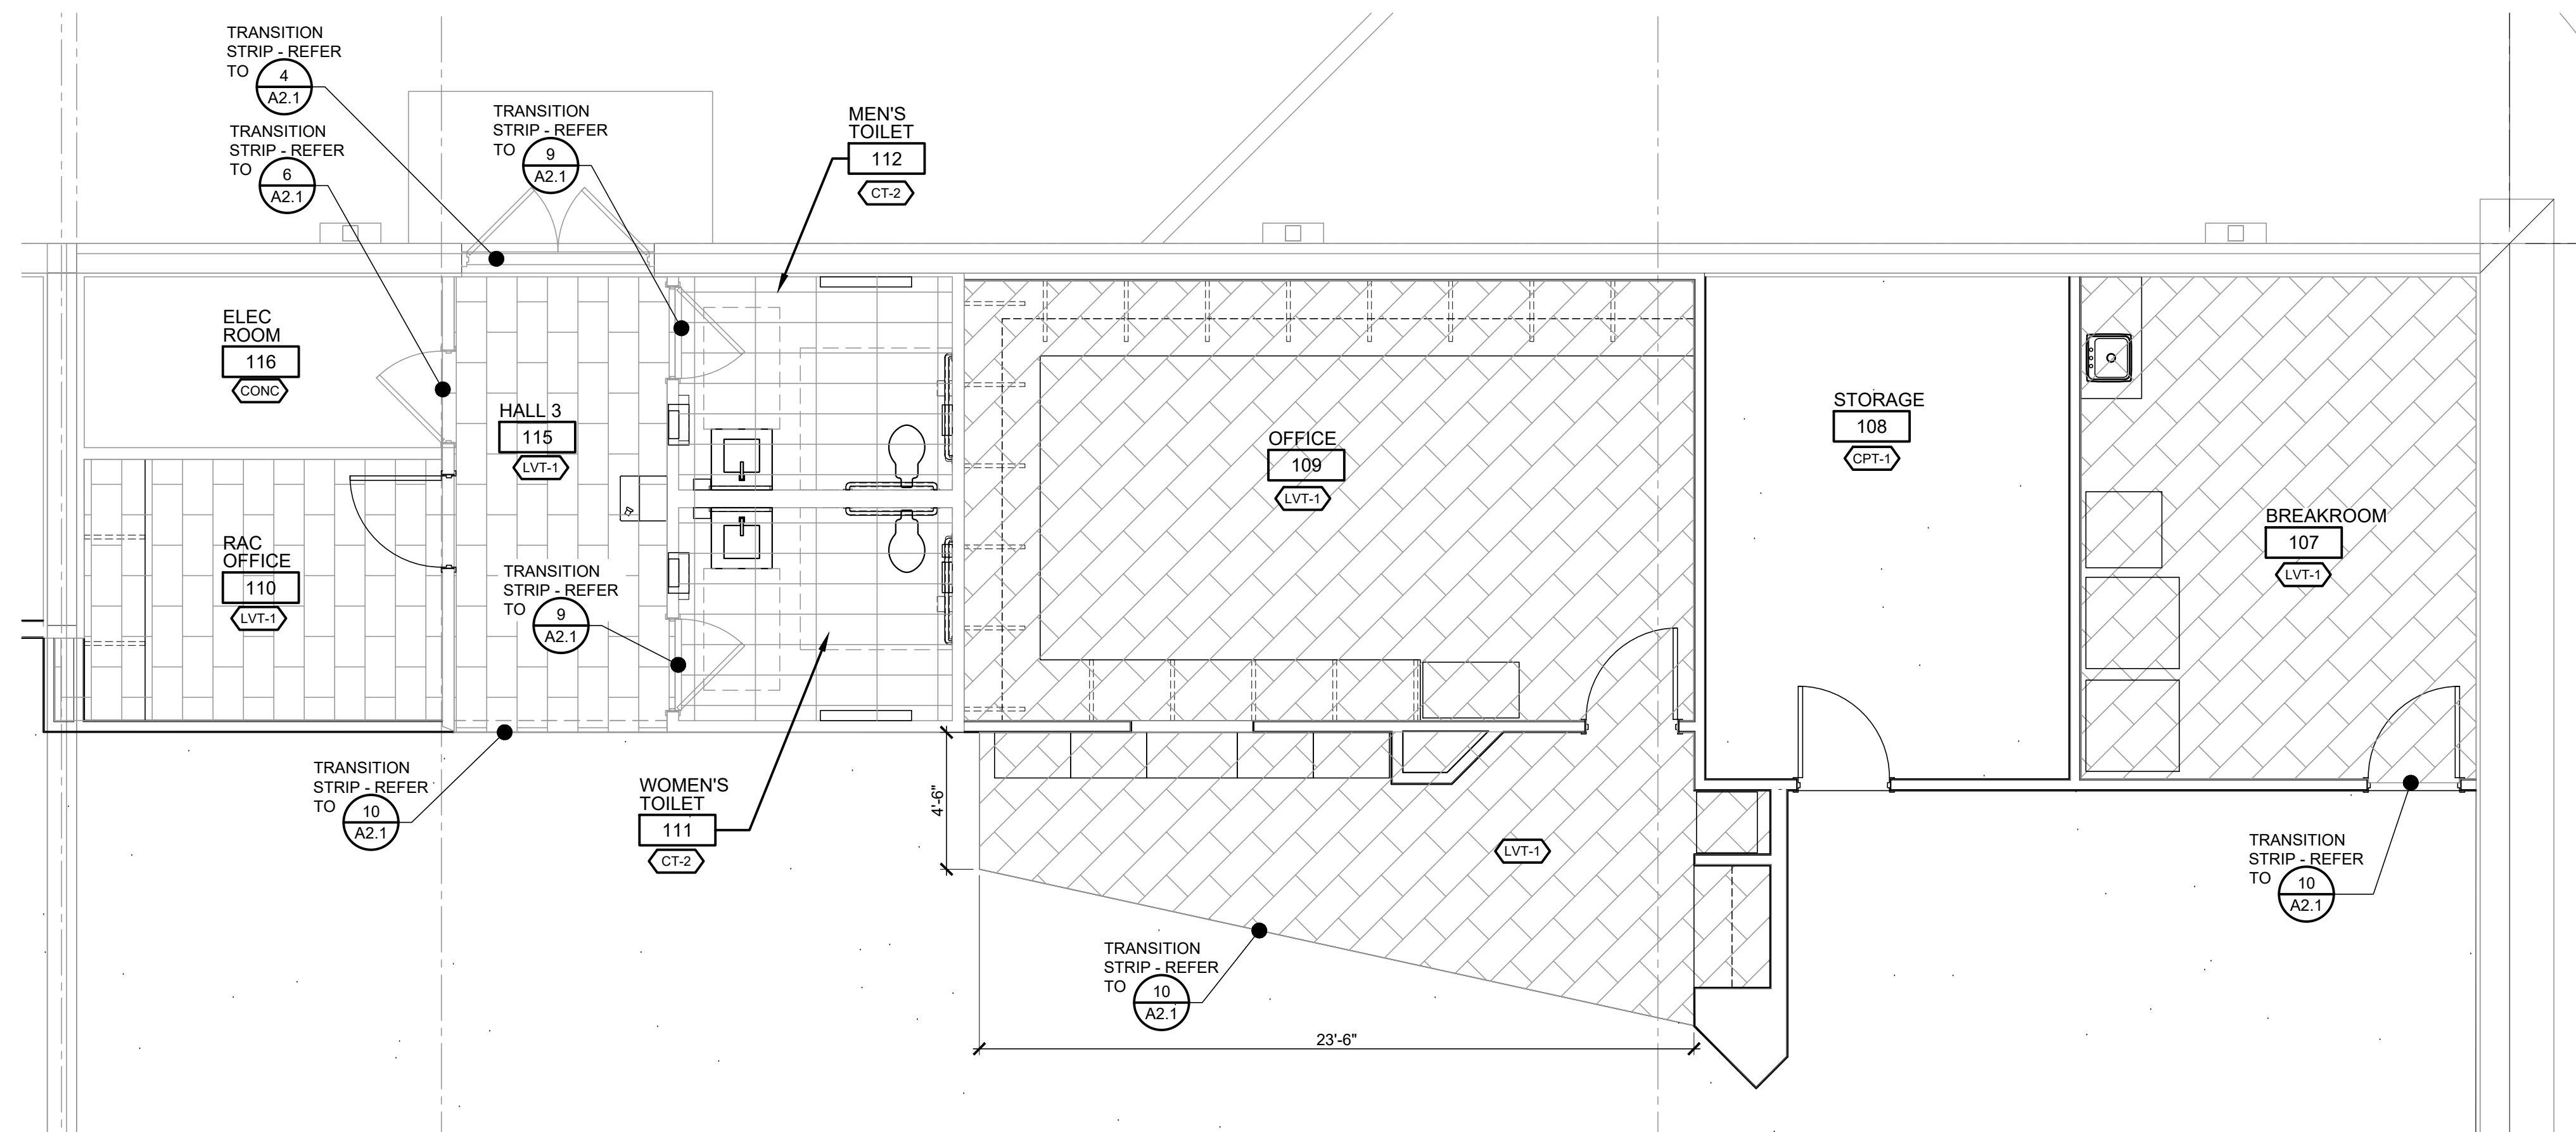



1 FLOORING PLAN
SCALE: 1/4" = 1'-0"

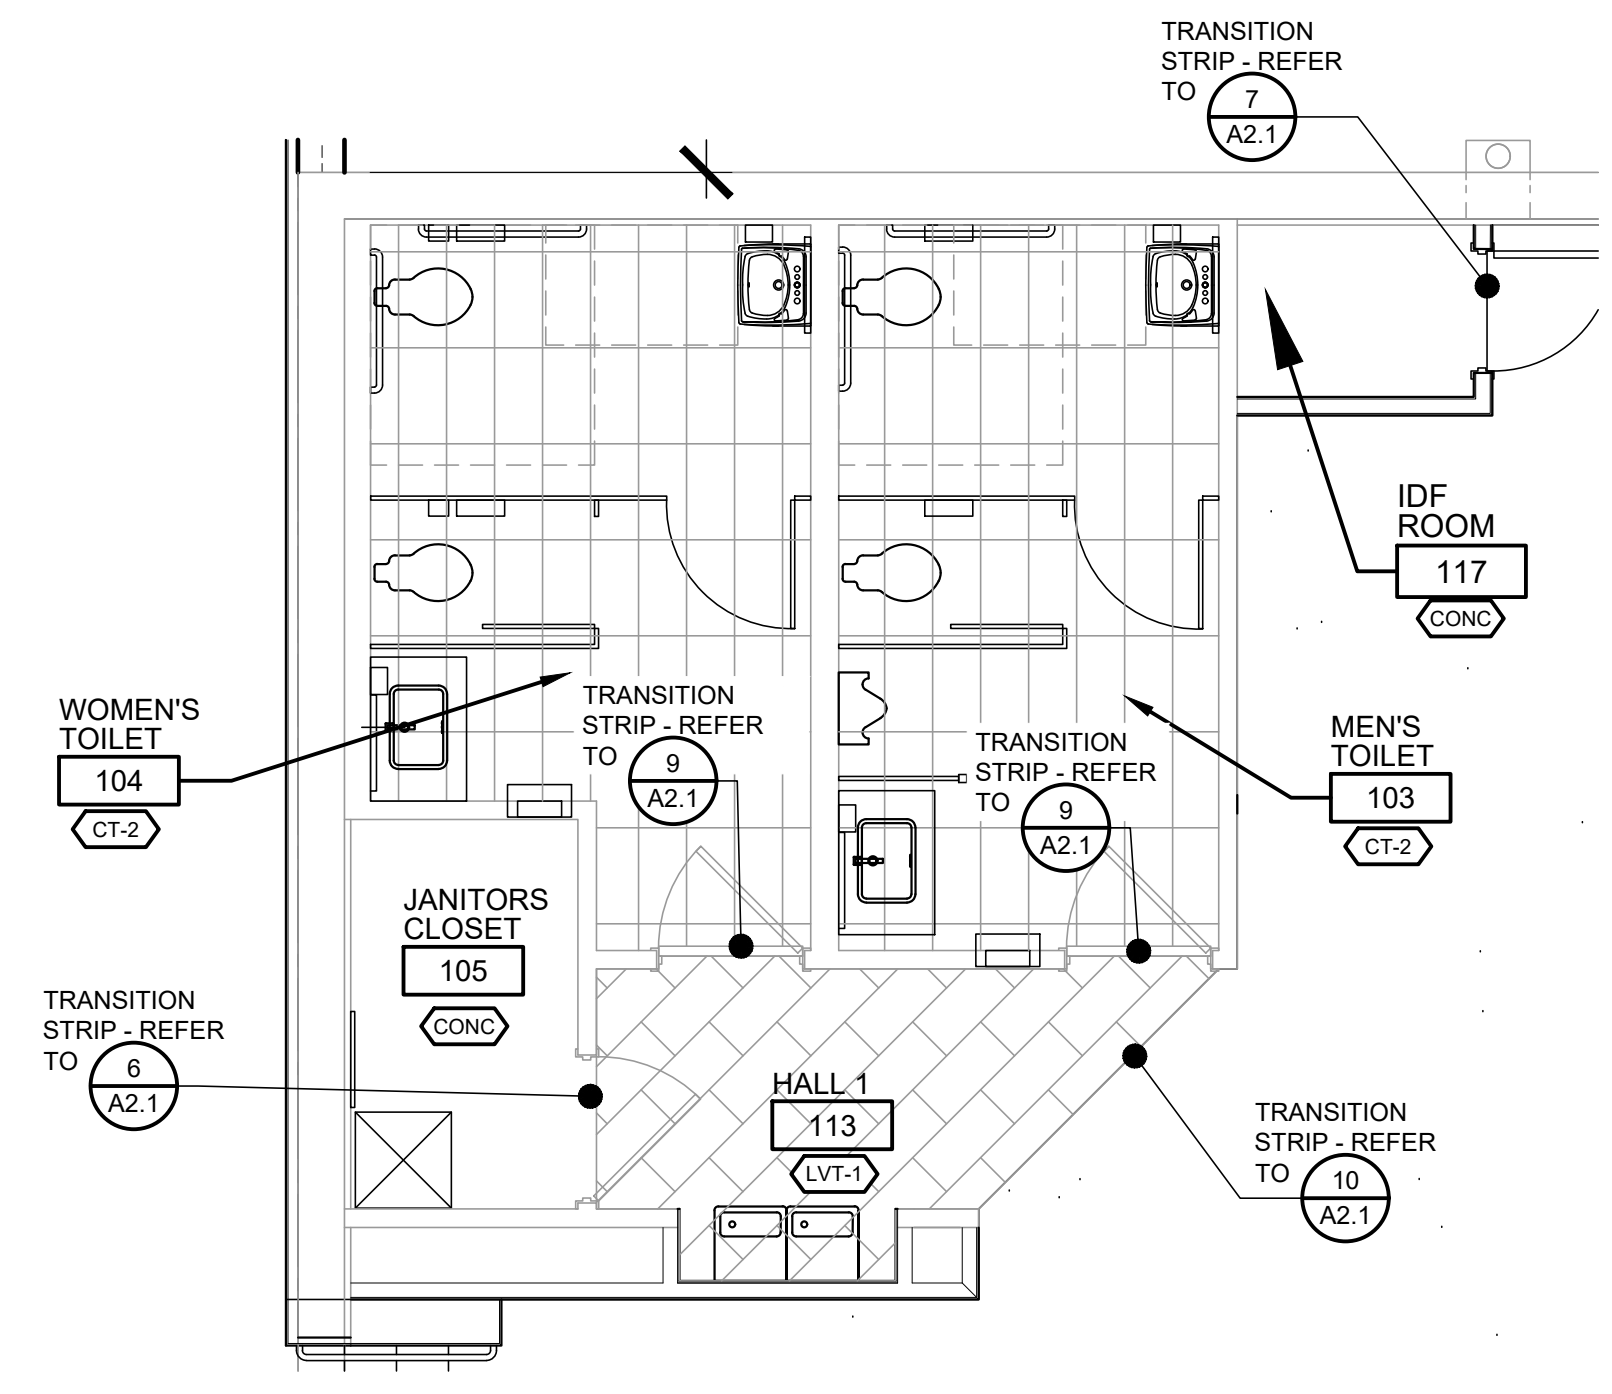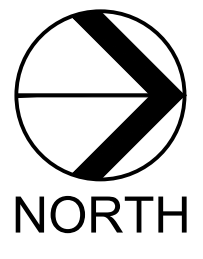



2 FLOORING PLAN
SCALE: 1/4" = 1'-0"

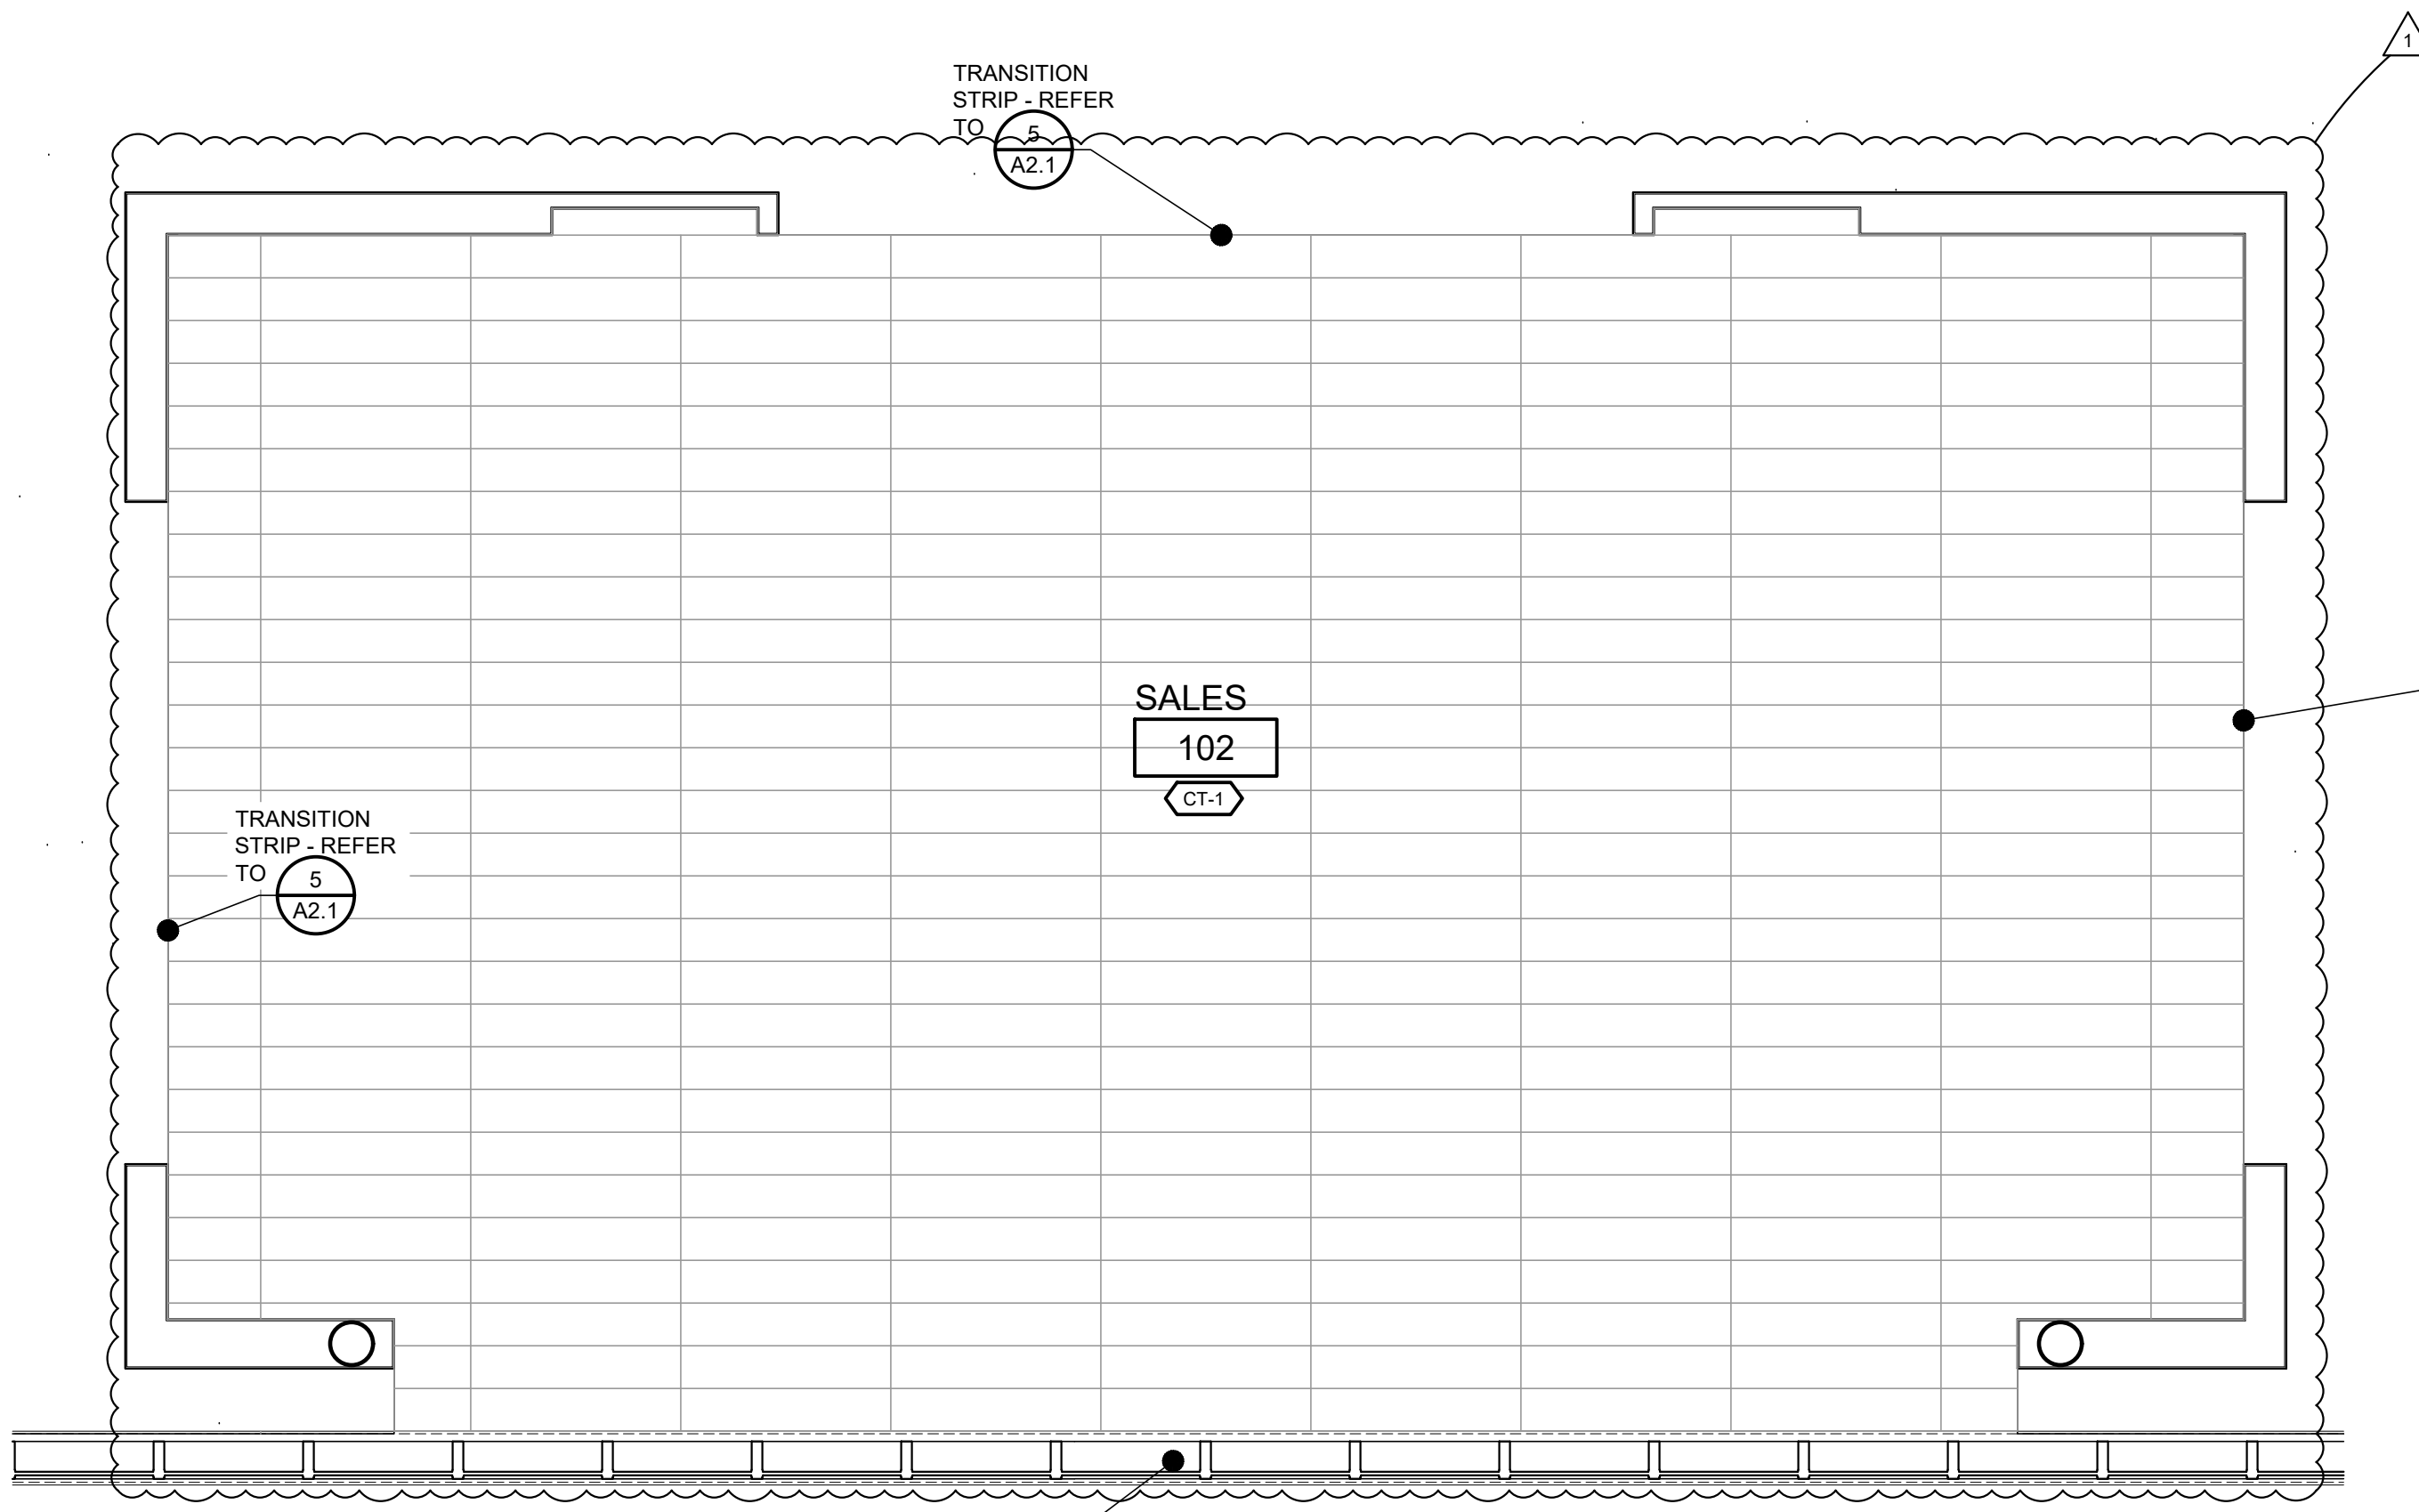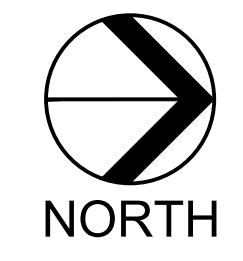

3 FLOORING PLAN
SCALE: 1/4" = 1'-0"

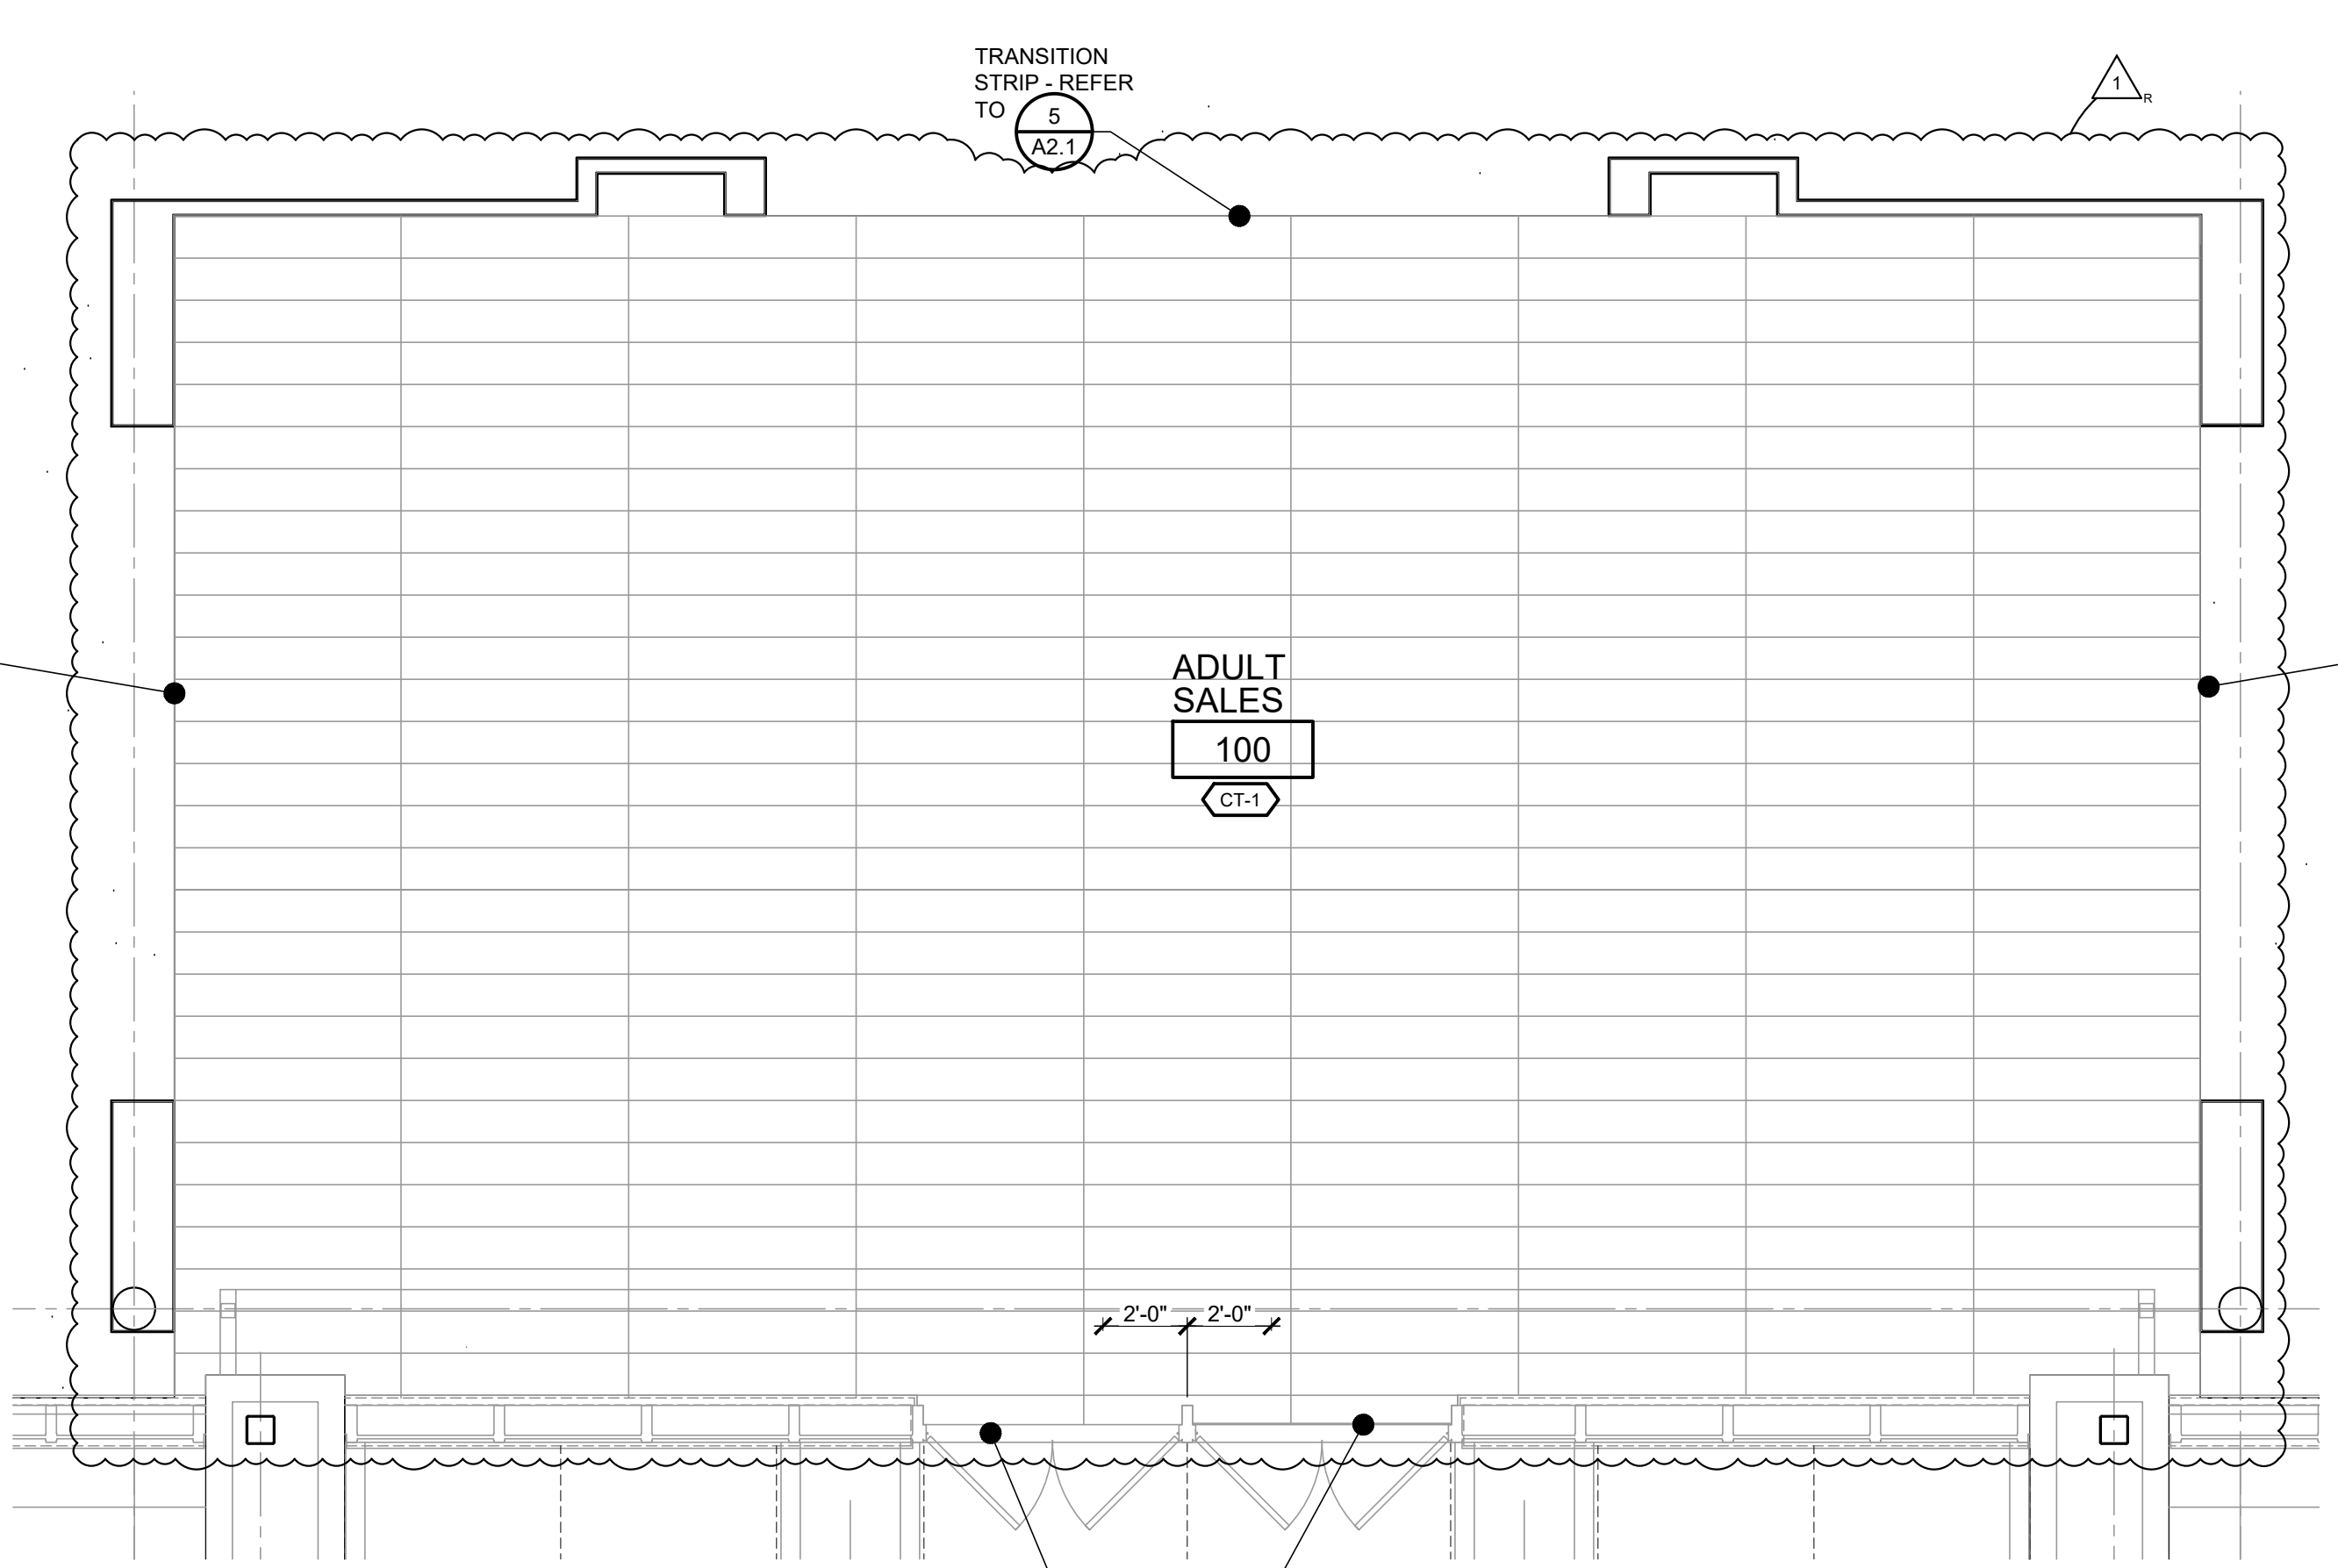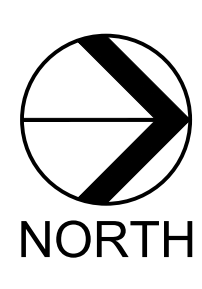


4 FLOORING PLAN
SCALE: 1/4" = 1'-0"

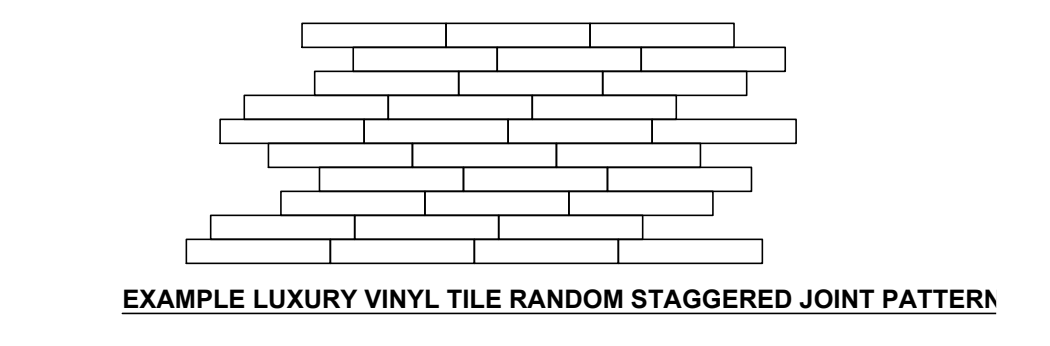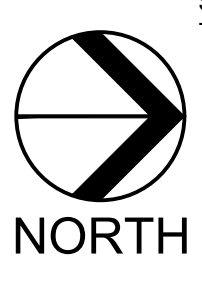


11 JOINT PATTERN EXAMPLE
SCALE: NOT TO SCALE


TARKETT TRANSITION STRIP PART NUMBER CT-XX-H SECURED WITH CHEMPREX CX-848 TUBE ADHESIVE. NO SUBSTITUTES. COLOR: 48 GREY TO BE APPROVED BY OWNERS REPRESENTATIVE

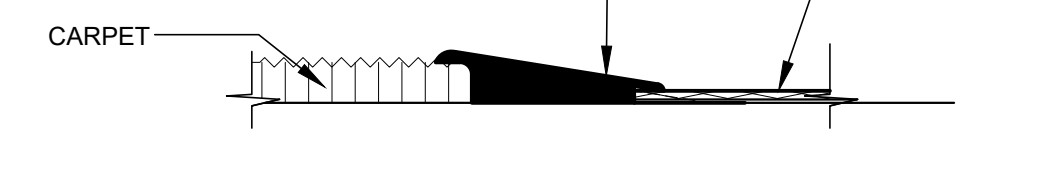


10 TRANSITION DETAIL
SCALE: 3" = 1'-0"

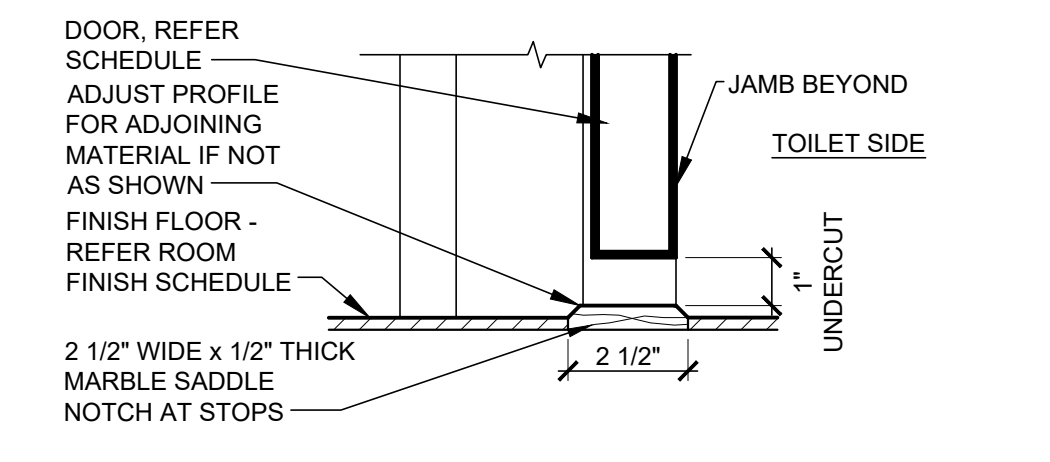


9 TRANSITION DETAIL
SCALE: 3" = 1'-0"

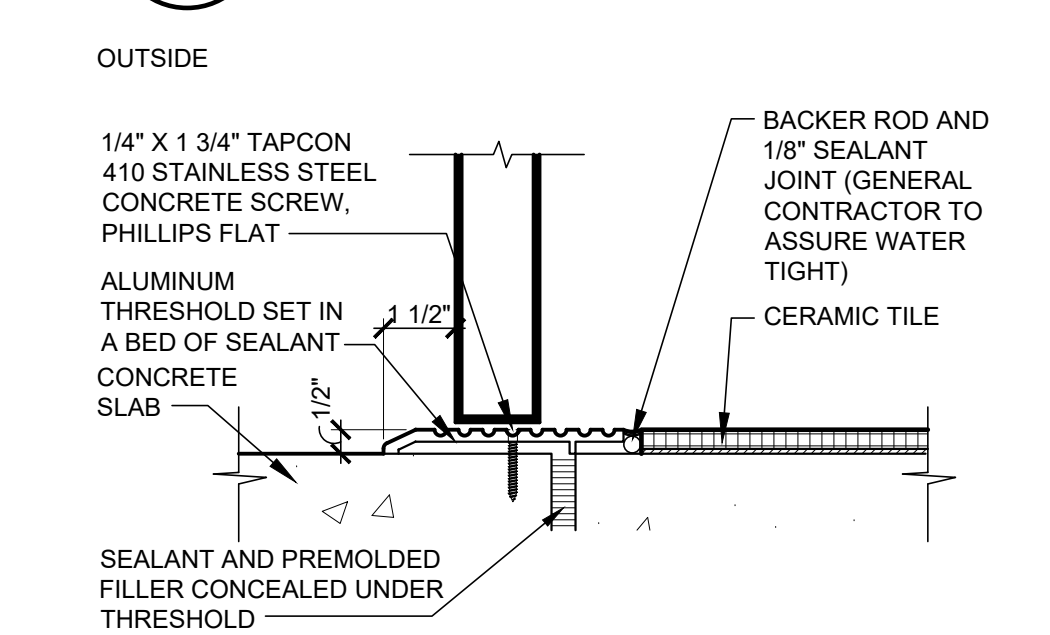


8 TRANSITION DETAIL
SCALE: 3" = 1'-0"

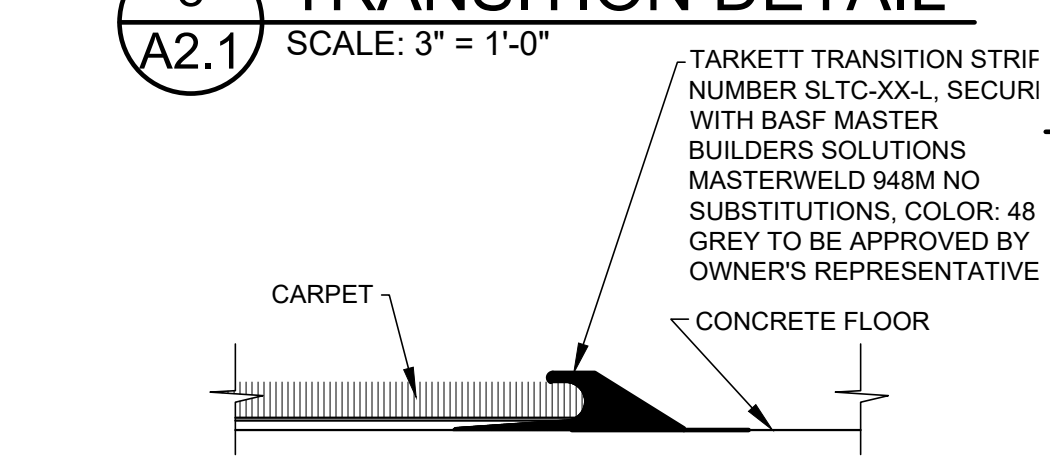


7 TRANSITION DETAIL
SCALE: 6" = 1'-0"

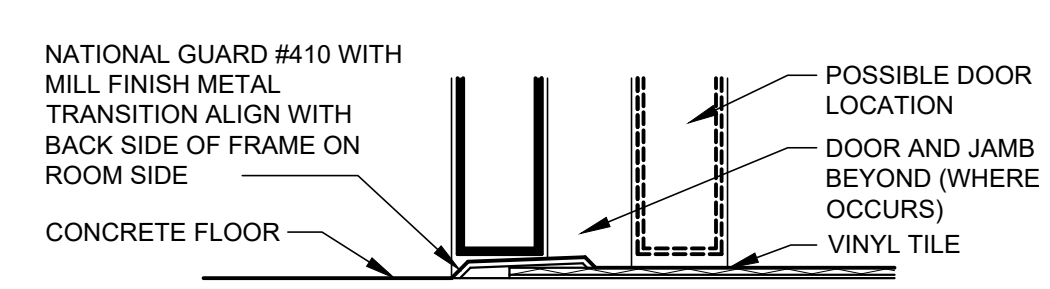

6 TRANSITION DETAIL
SCALE: 3" = 1'-0"

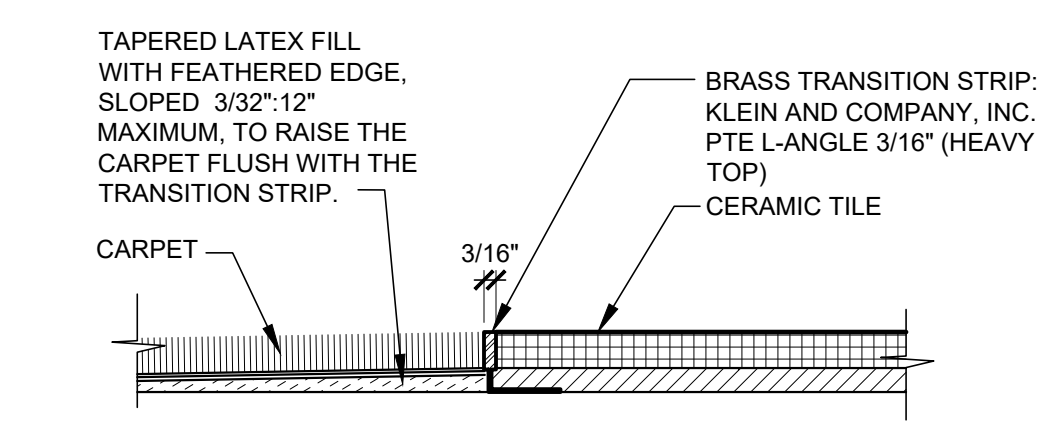

5 TRANSITION DETAIL
SCALE: 3" = 1'-0"

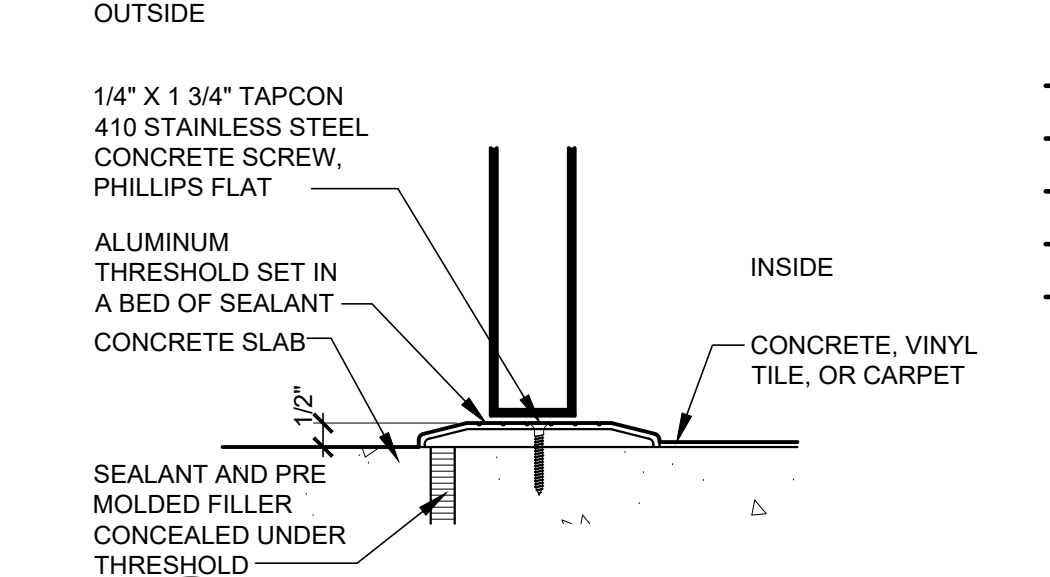


4 TRANSITION DETAIL
SCALE: 3" = 1'-0"

STORE EXPANSION AND REMODEL

ROOMS TO GO

18722 SOUTH DIXIE HIGHWAY,
CUTLER BAY, FL 33157


CONSTR. DOC. & REVISIONS
No. Description
1 ADDENDUM 2

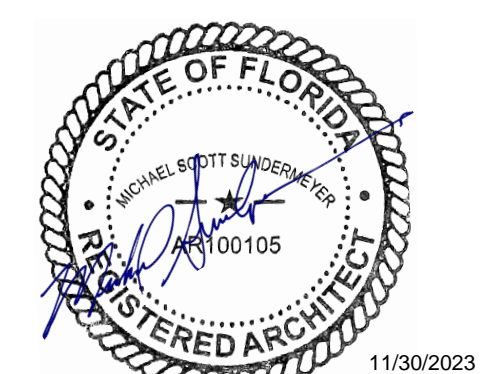


PROFESSIONAL OF RECORD
MICHAEL SCOTT SUNDERMEYER
License No.: AR000005
Expiration Date: 03/28/25

Drawn By/Checked By: dir/MSB
Project Number: 2101445
Bid Date: 11/09/23
Permit: 03/28/23
Owner Date: 07/06/22

ENLARGED FLOOR FINISH PLANS A2.1

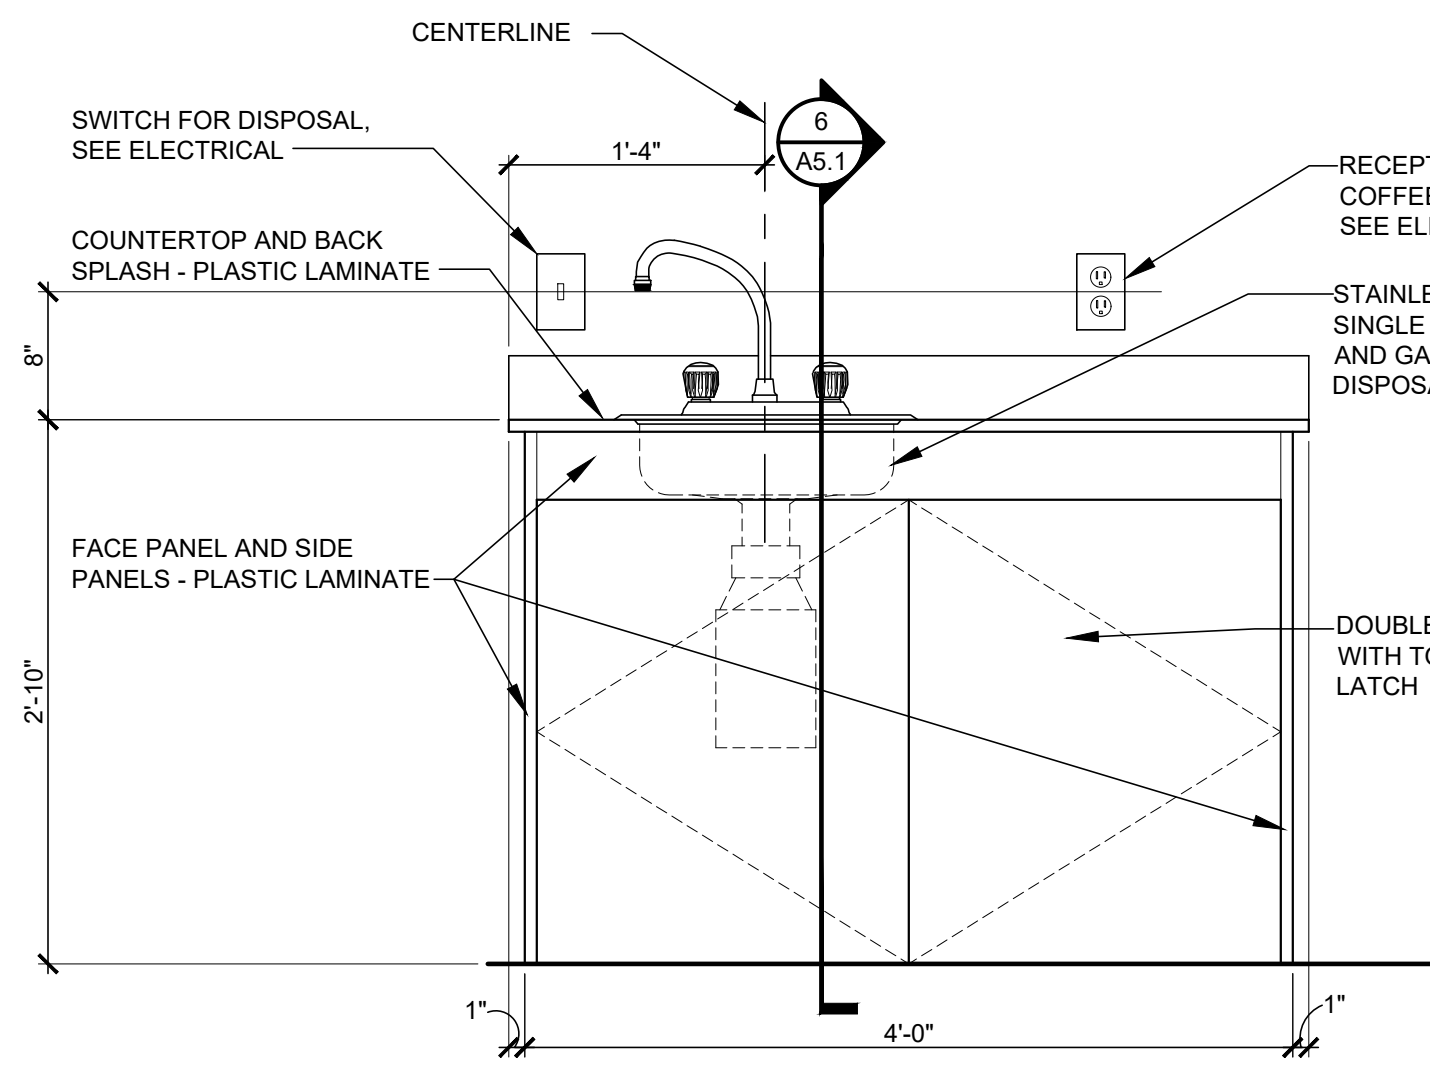

1 BREAK ROOM SINK ELEVATION
A5.1 SCALE: 1" = 1'-0"

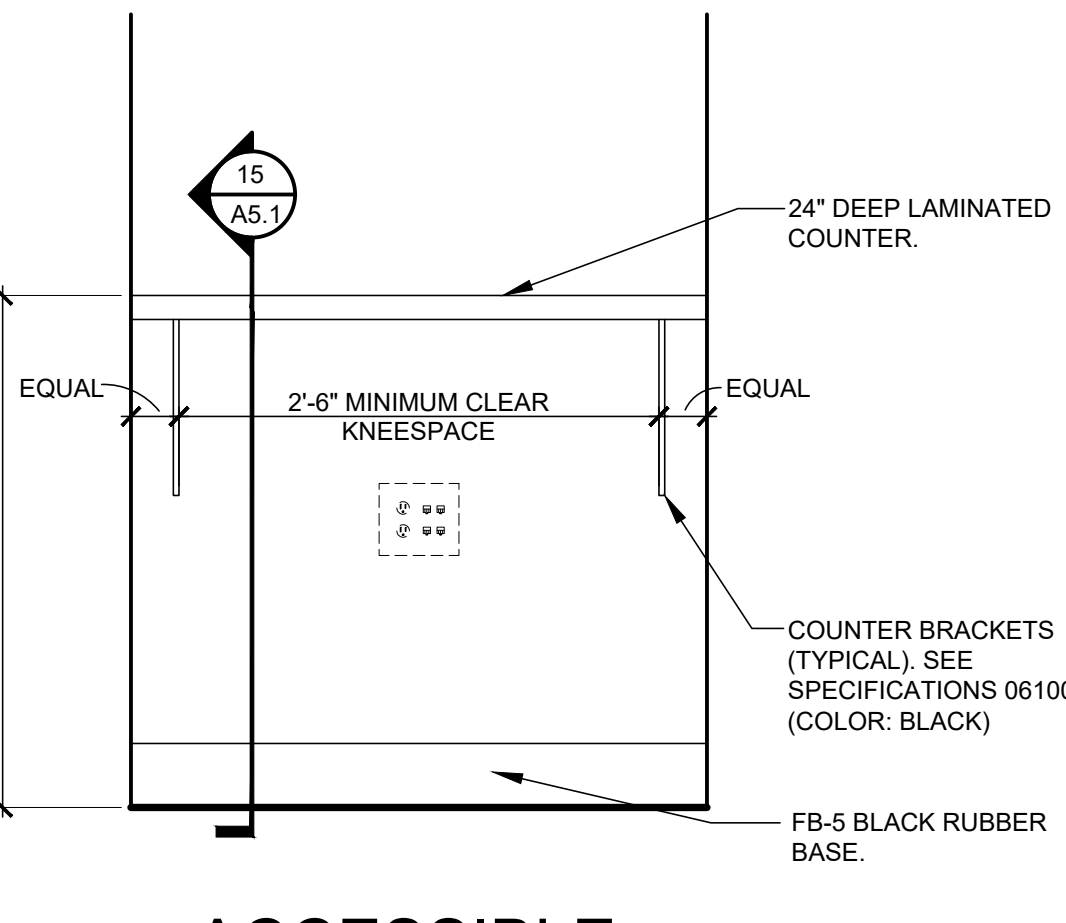


2 ACCESSIBLE COUNTER ELEVATION
A5.1 SCALE: 1" = 1'-0"


3 NOT USED
A5.1 SCALE: 1/2" = 1'-0"

4 NOT USED
A5.1 SCALE:


5 NOT USED
A5.1 SCALE:

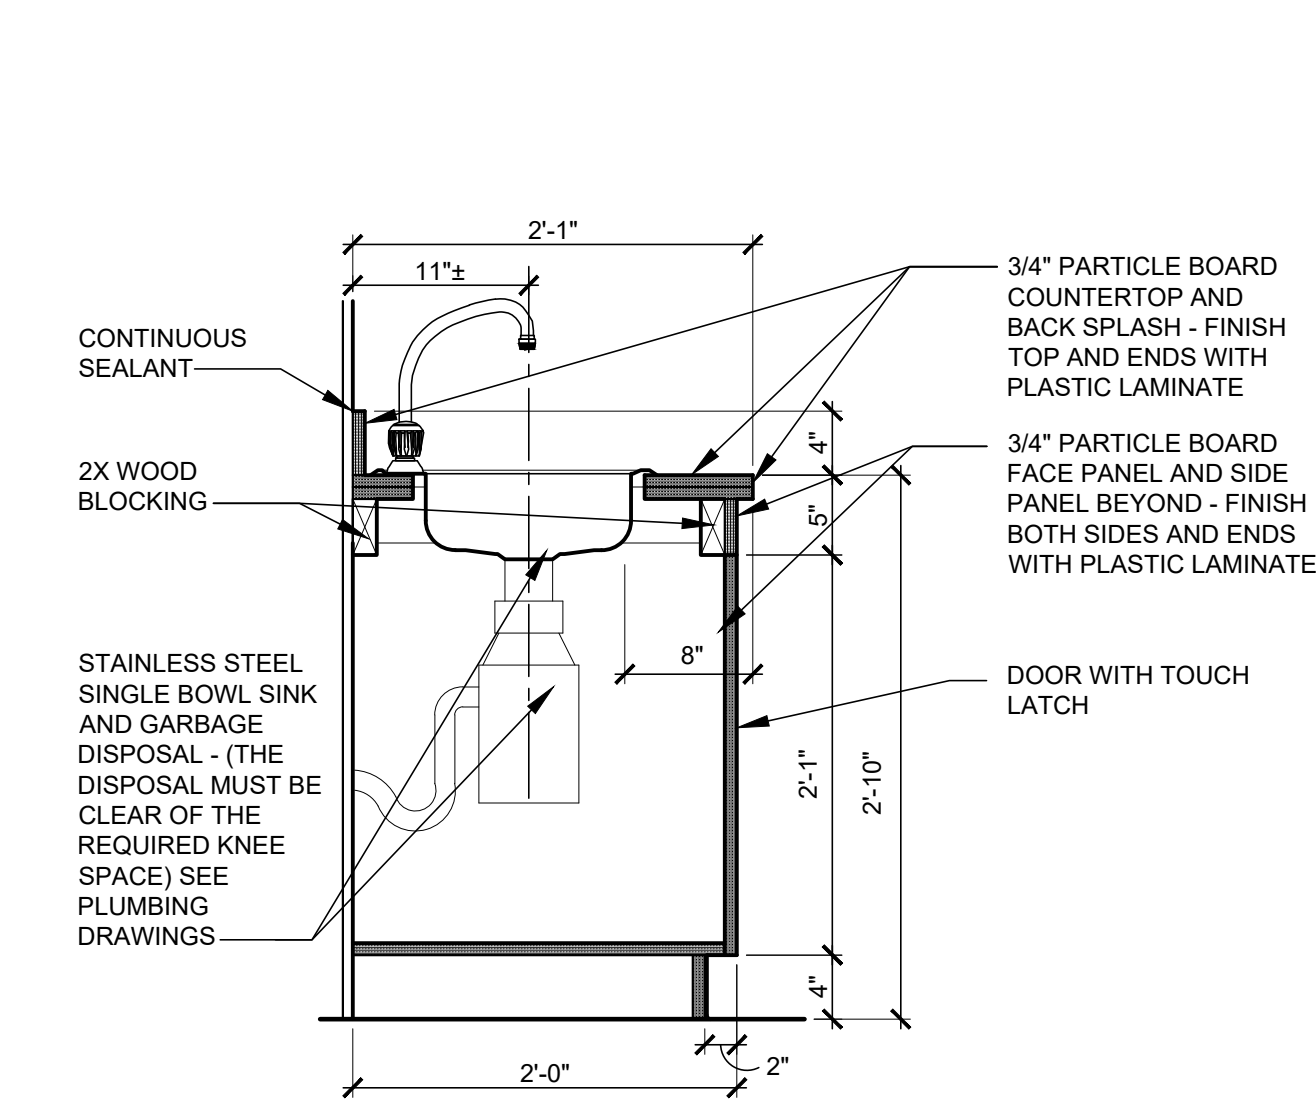


6 BREAK ROOM CABINET DETAIL
A5.1 SCALE: 1" = 1'-0"

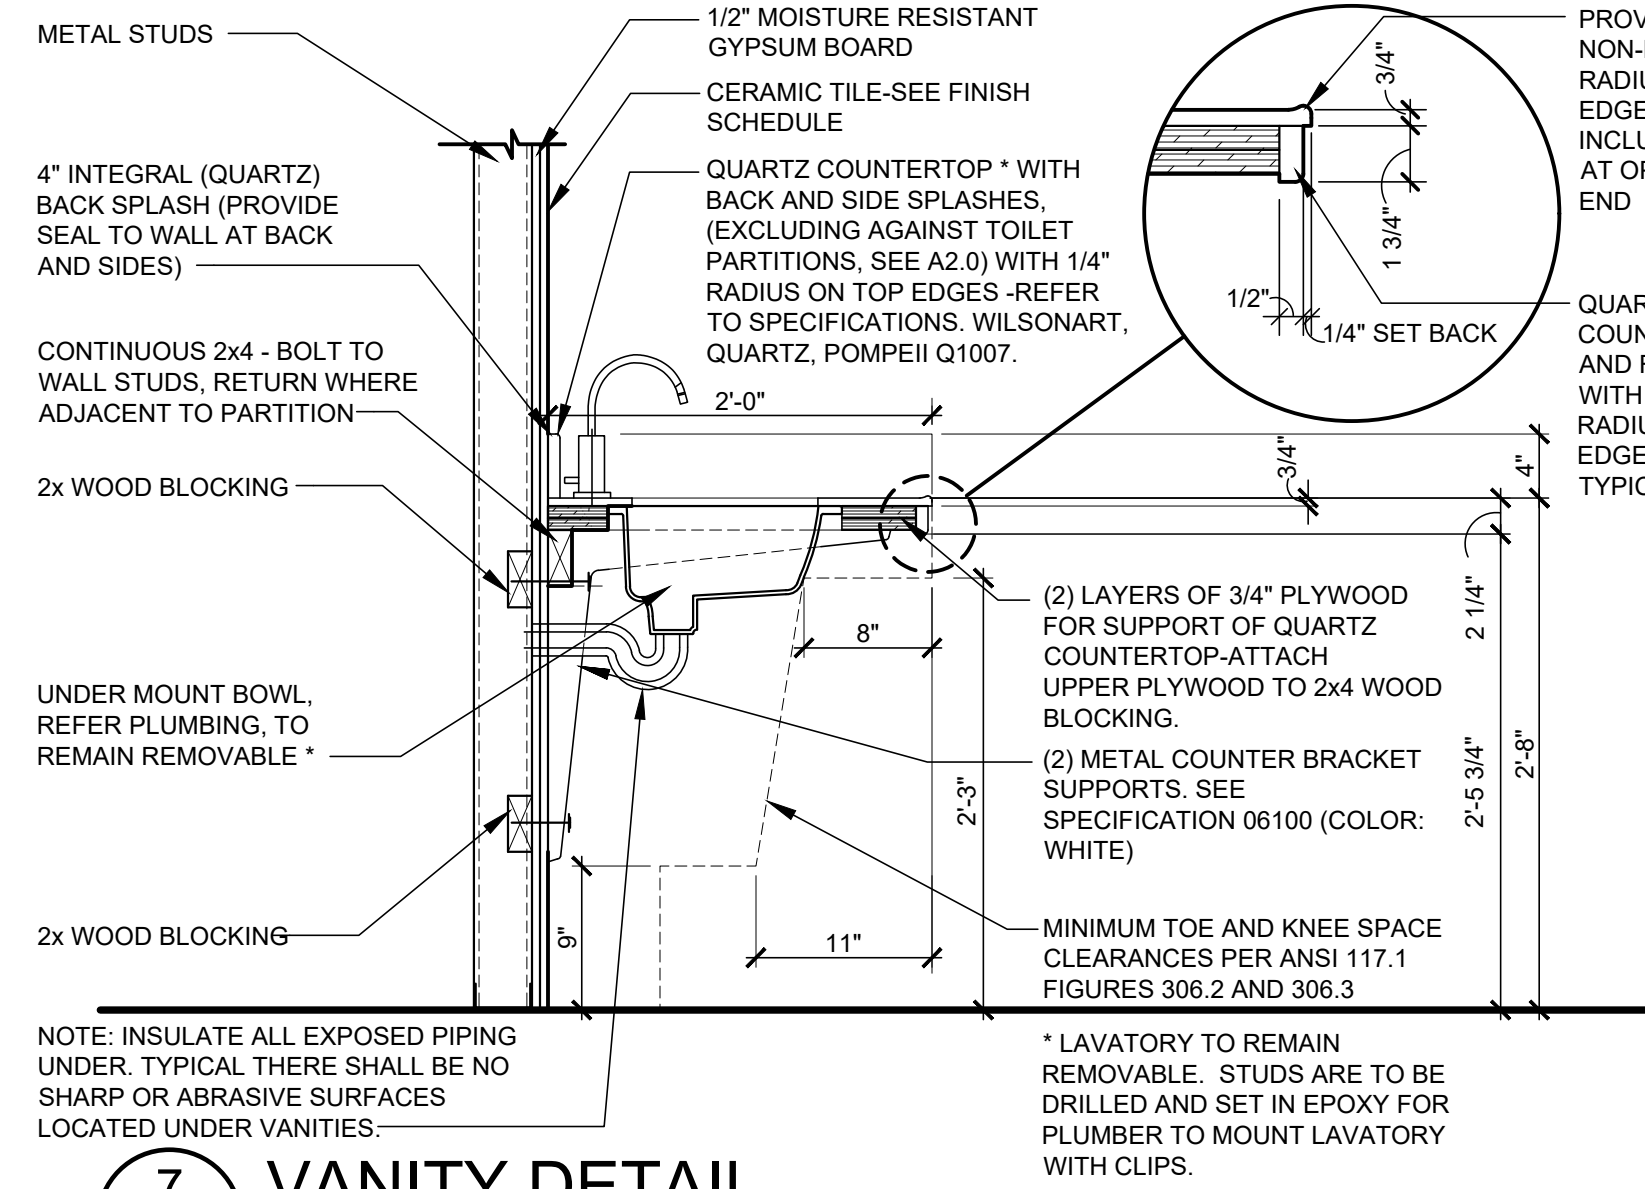


7 VANITY DETAIL
A5.1 SCALE: 1" = 1'-0"

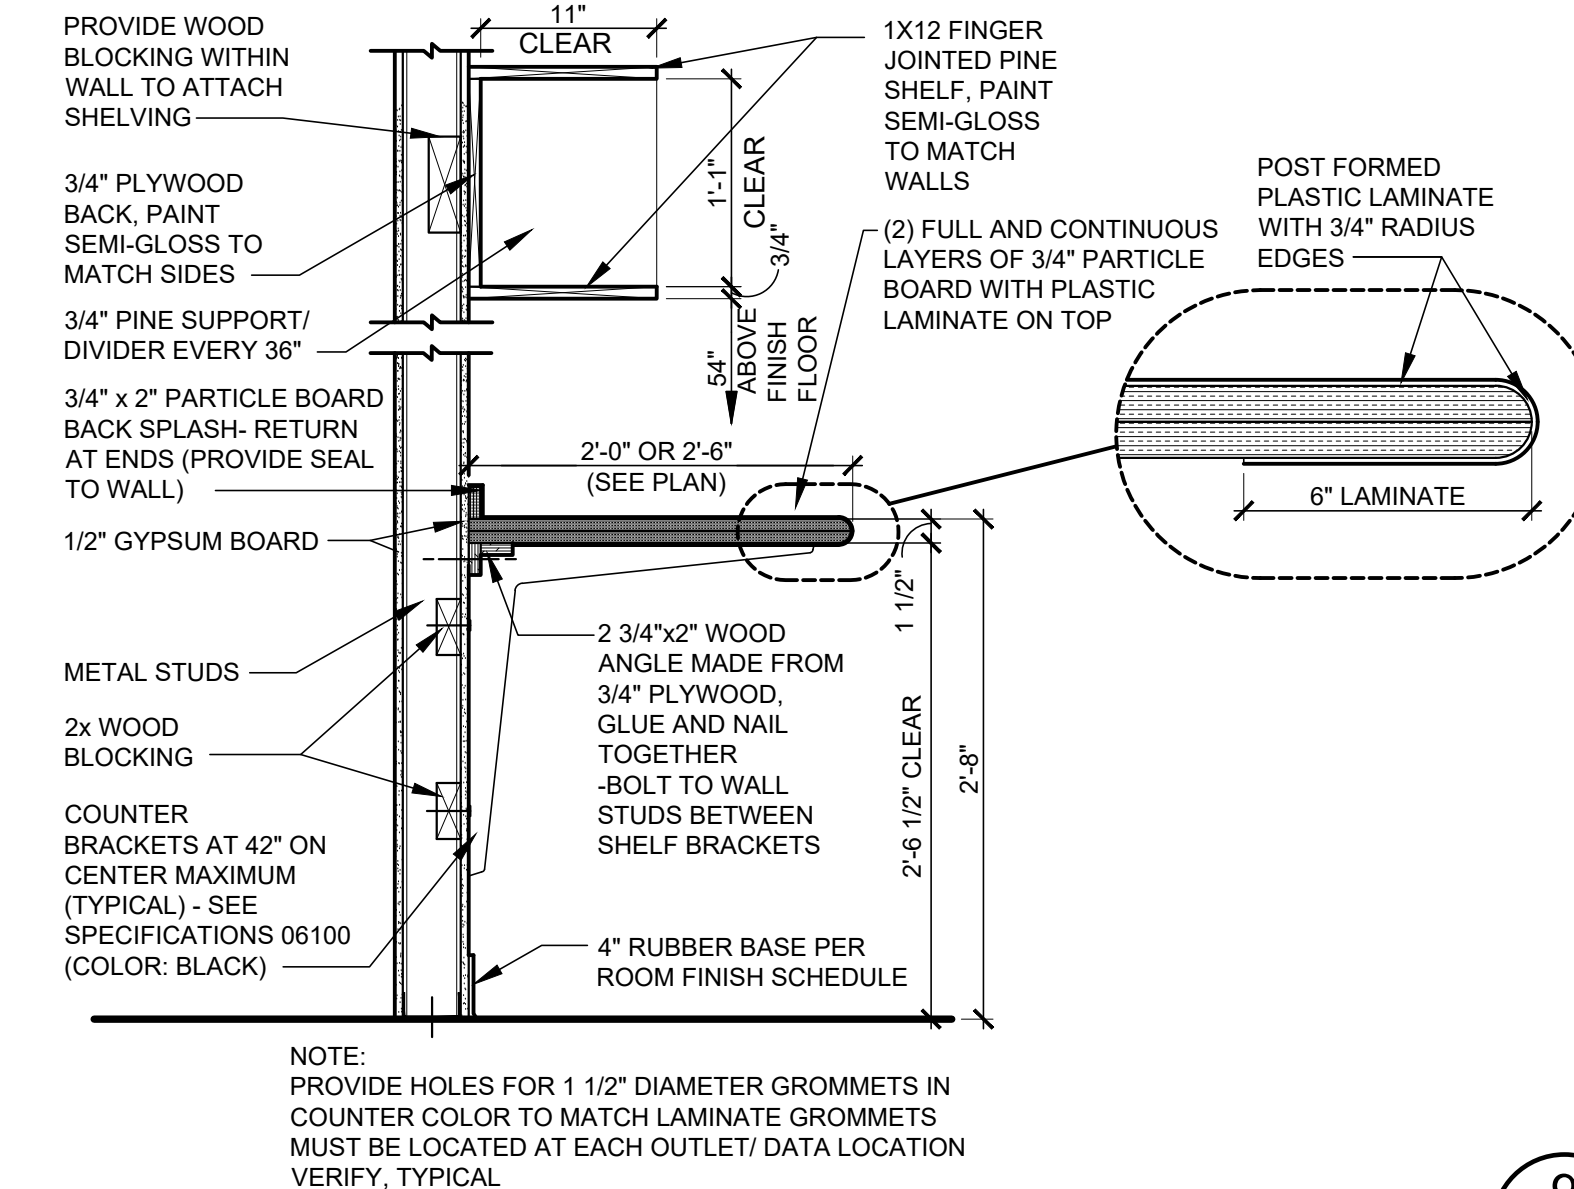


8 COUNTER DETAIL
A5.1 SCALE: 1" = 1'-0"

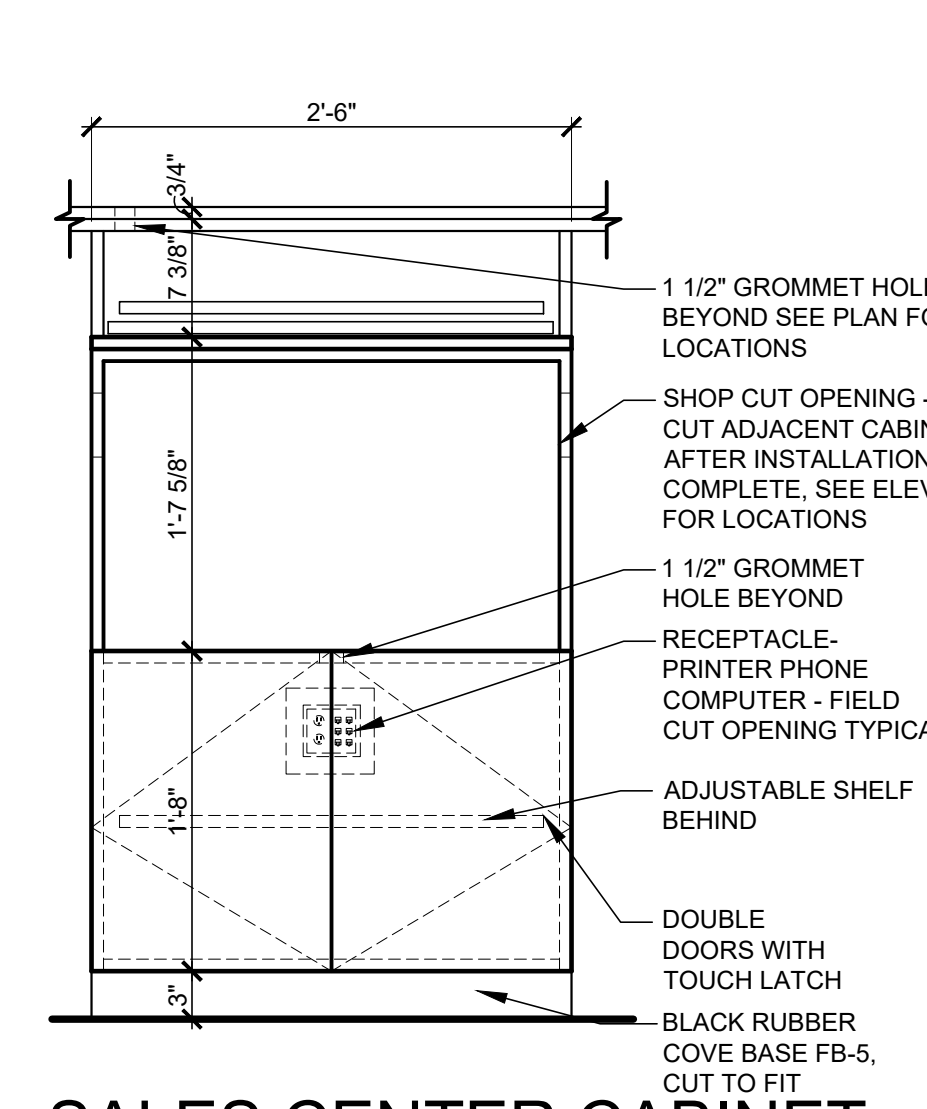


9 SALES CENTER CABINET ELEVATION
A5.1 SCALE: 1" = 1'-0"

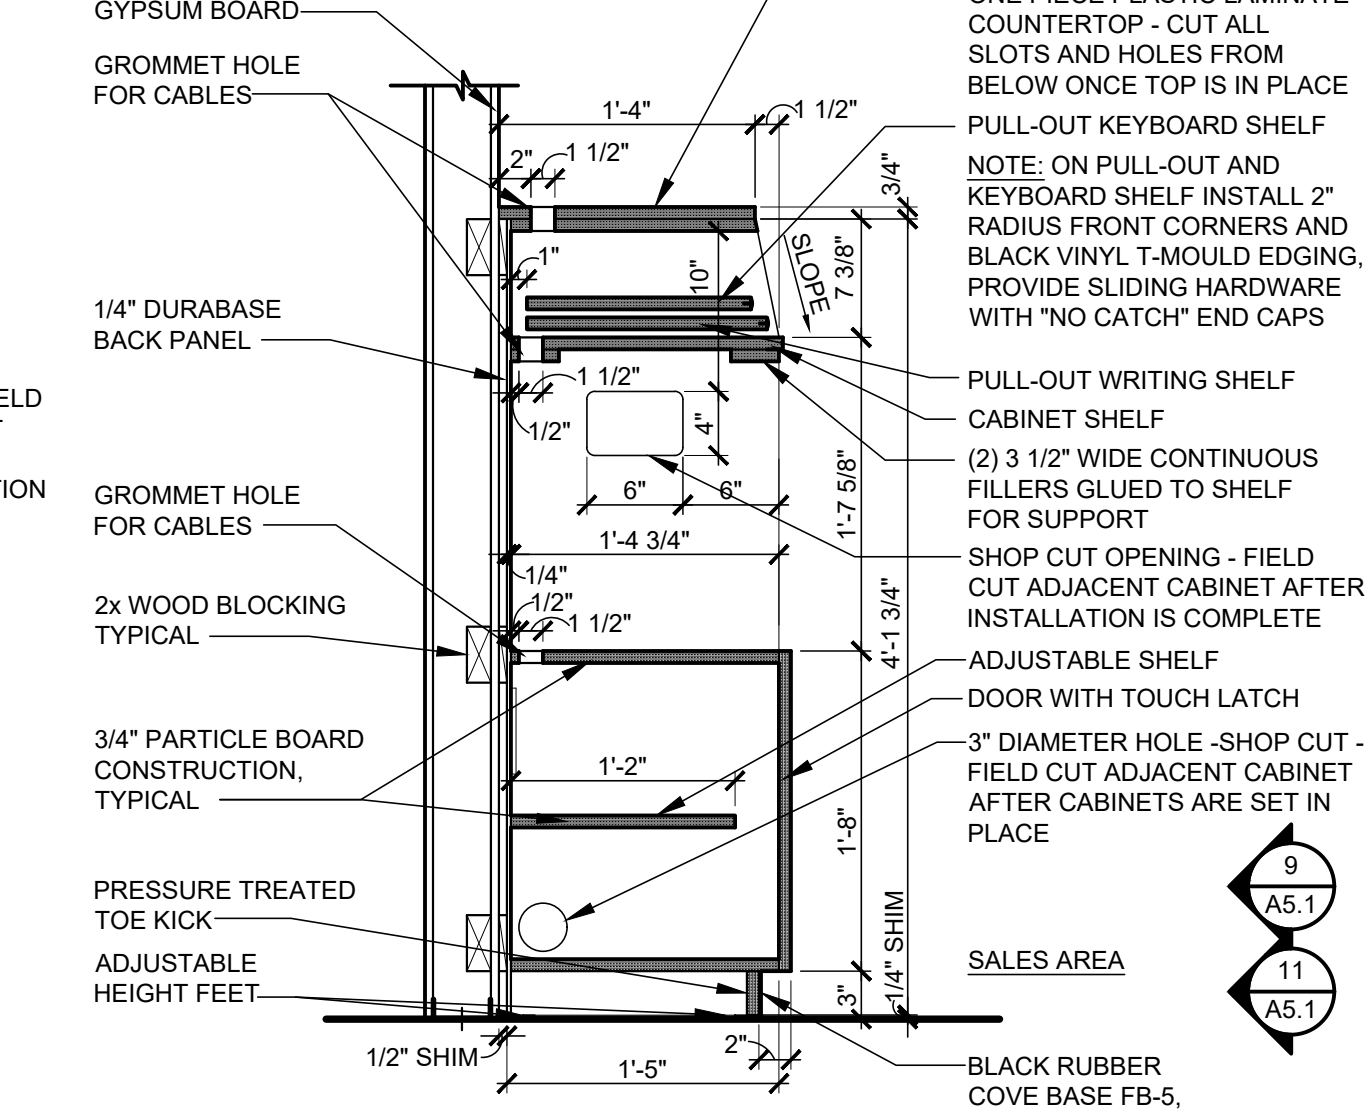

10 SALES CENTER CABINET DETAIL
A5.1 SCALE: 1" = 1'-0"

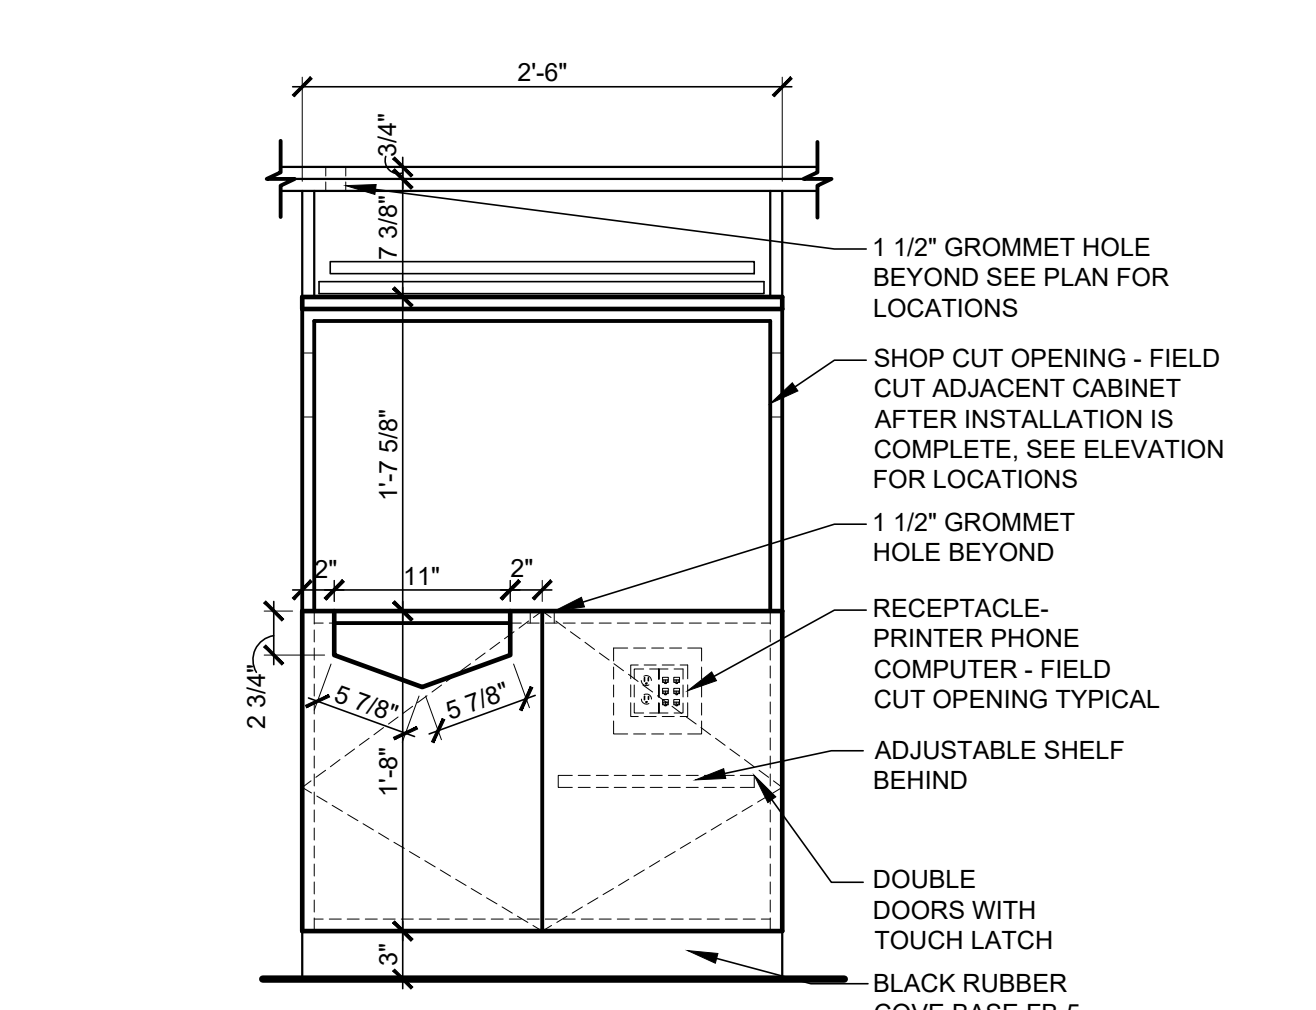

11 SALES TRASH CABINET ELEVATION
A5.1 SCALE: 1" = 1'-0"

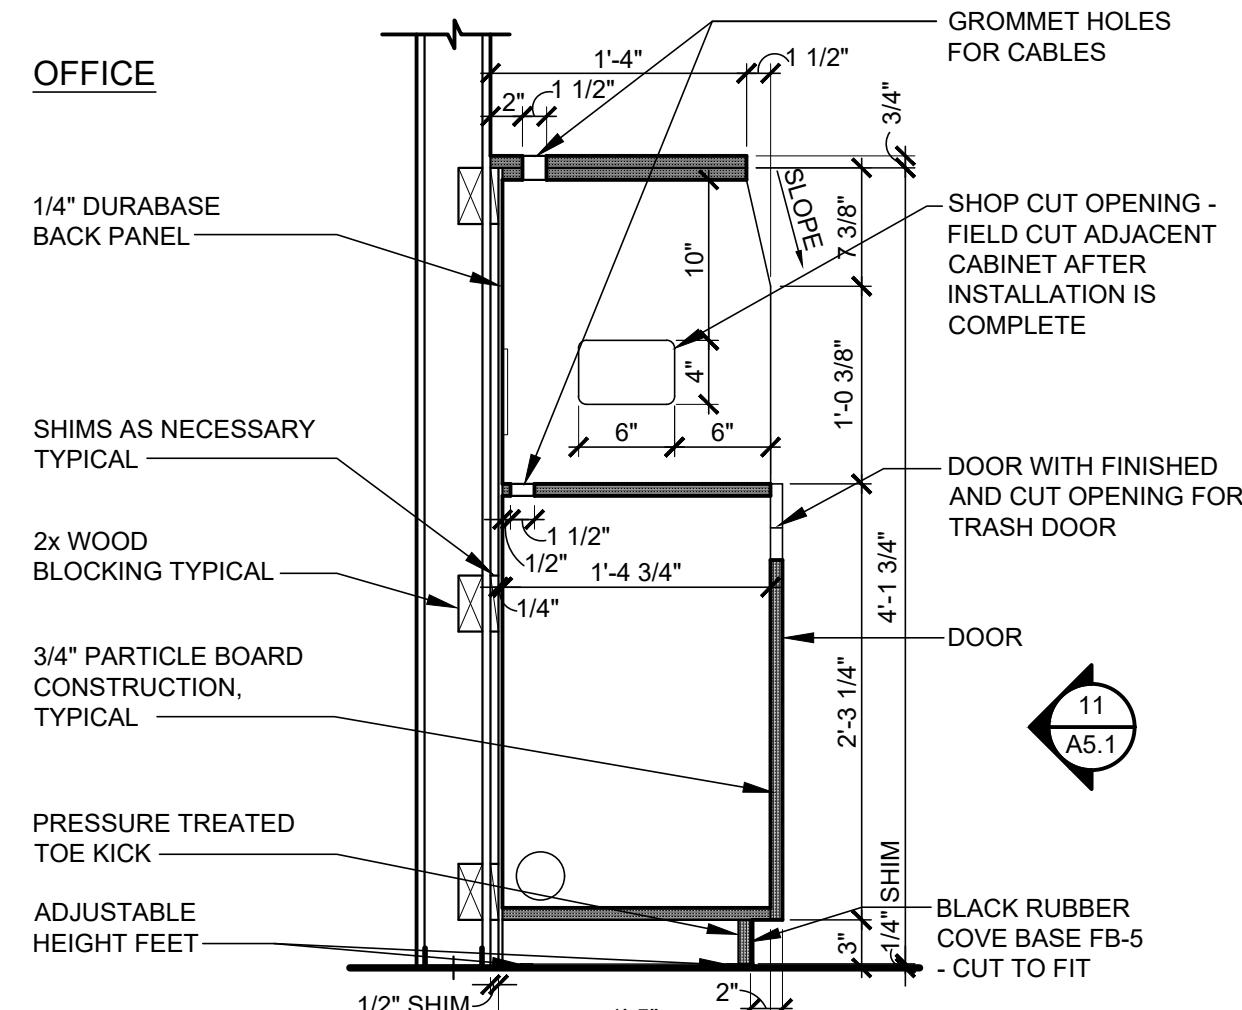

12 SALES PRINTER CABINET DETAIL
A5.1 SCALE: 1" = 1'-0"


13 NOT USED
A5.1 SCALE: 1" = 1'-0"

14 NOT USED
A5.1 SCALE: 1" = 1'-0"


15 ACCESSIBLE COUNTER SECTION
A5.1 SCALE: 1" = 1'-0"




16 NOT USED
A5.1 SCALE: 1" = 1'-0"

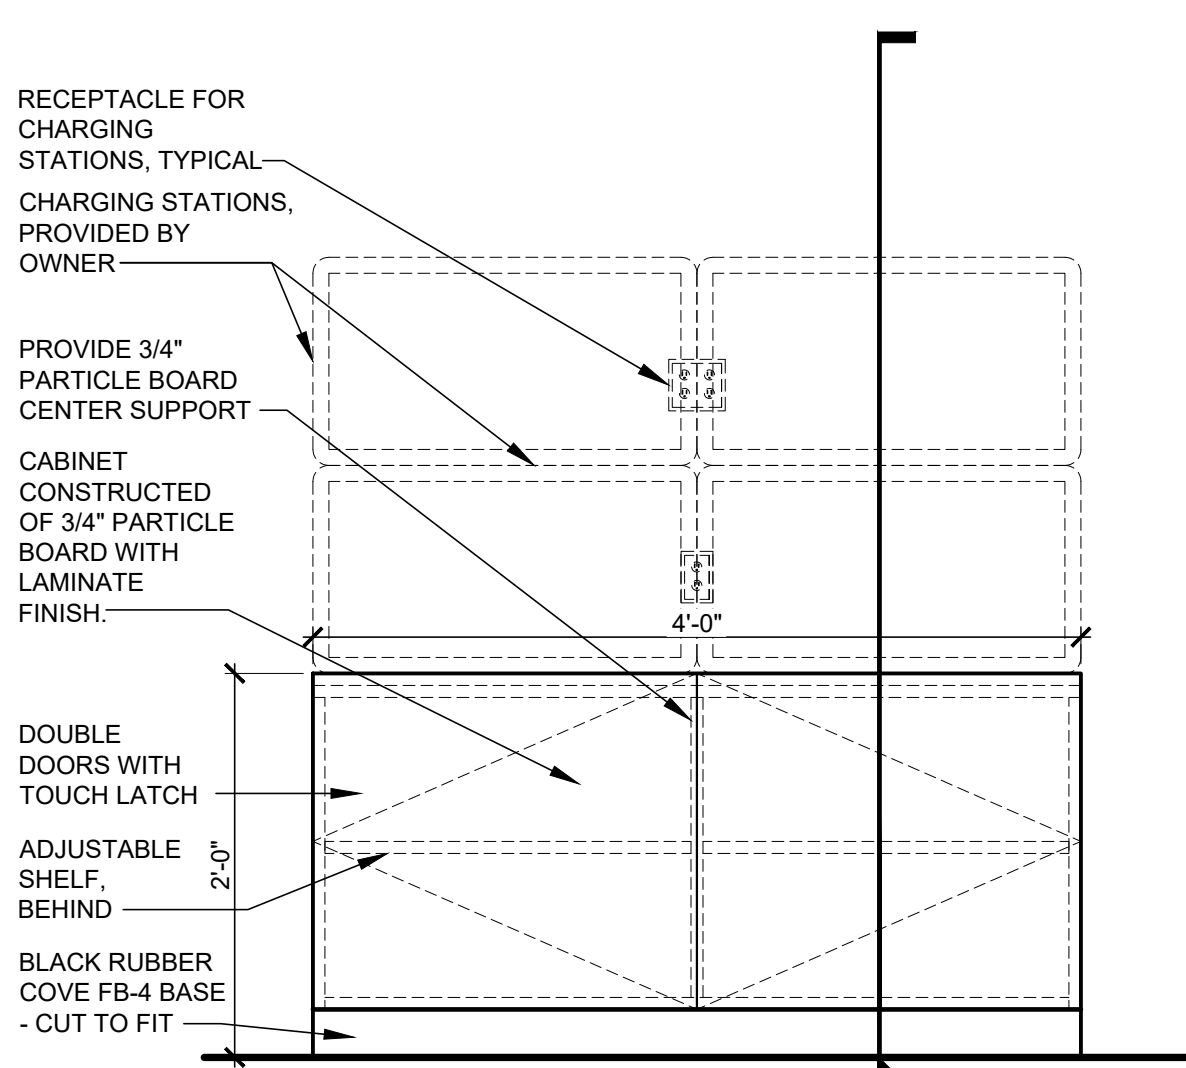

17 TABLET CHARGING STATION ELEVATION
A5.1 SCALE: 1" = 1'-0"

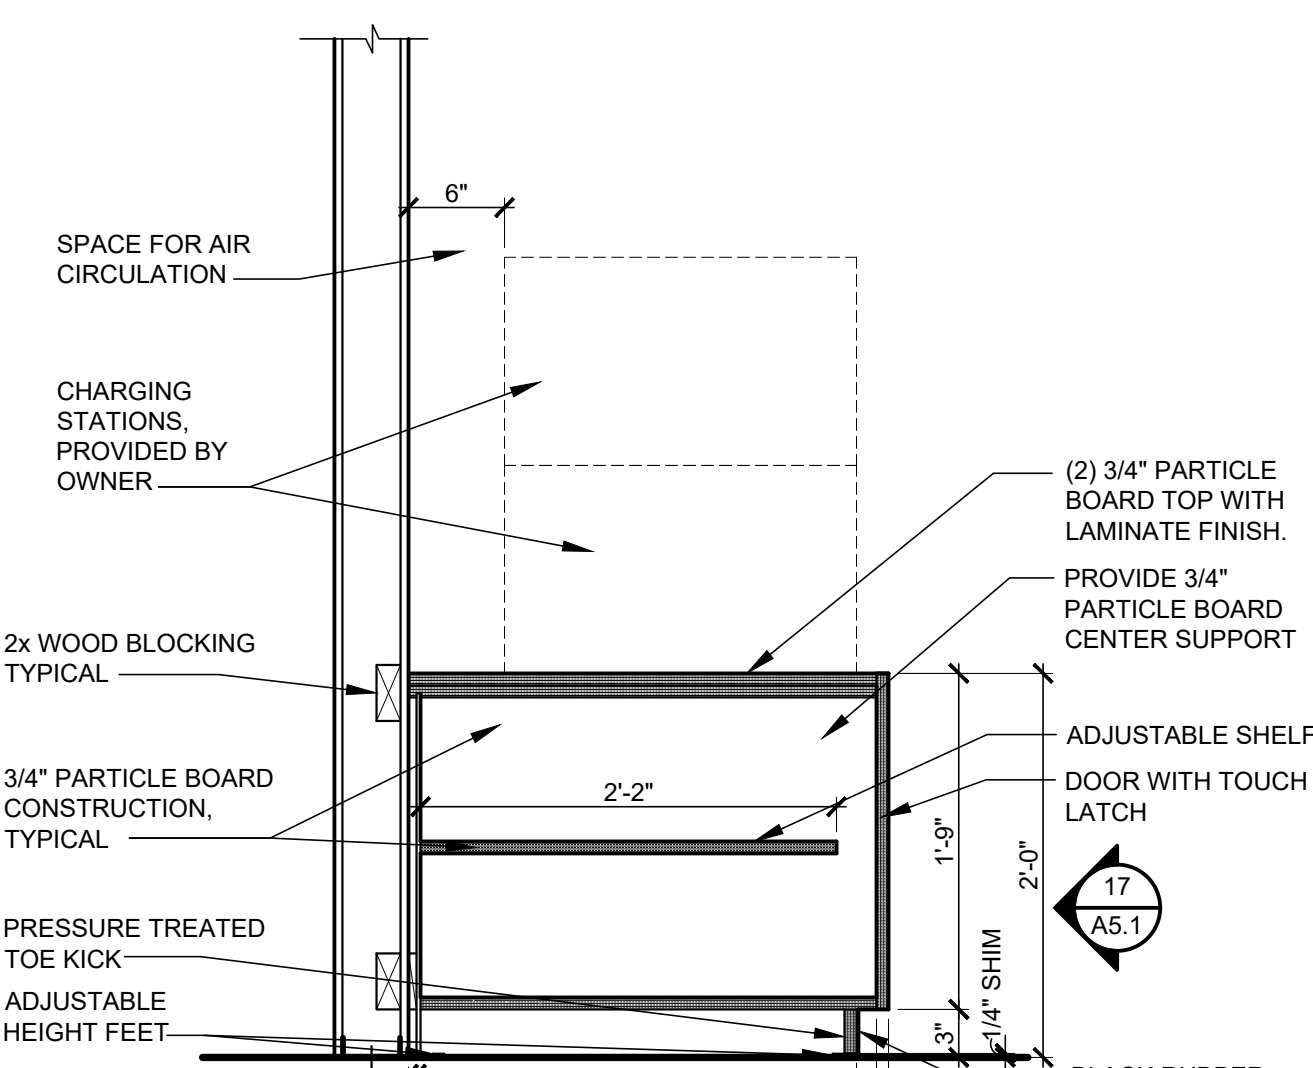

18 TABLET CHARGING STATION SECTION
A5.1 SCALE: 1" = 1'-0"

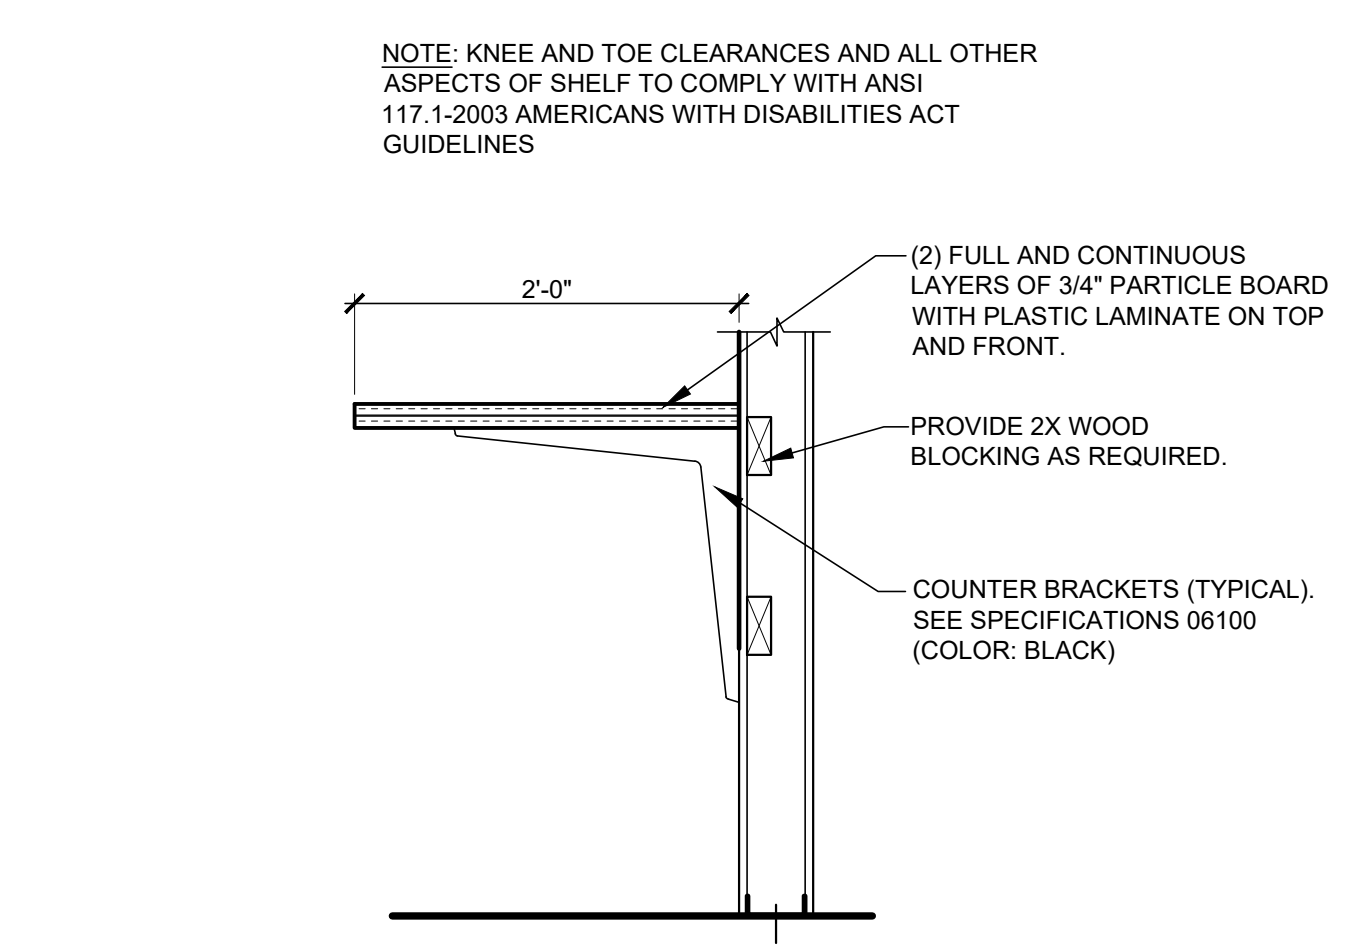


GENERAL NOTES:
1- CONSTRUCT MILLWORK OF 3/4" COMMERCIAL GRADE PARTICLE BOARD, UNLESS NOTED OTHERWISE. OFFICE SHELVES ARE SOLID PINE BOARDS AND RESTROOM VANITIES HAVE PLYWOOD SUBSTRATE.
2- PROVIDE KNAPE AND VOGT MEDIUM DUTY (45 POUND CAPACITY) FULL EXTENSION SLIDE FOR PULL OUT SHELVES
3- ALL HARDWARE TO BE CHROME FINISH UNLESS NOTED OTHERWISE.

MILLWORK FINISH SCHEDULE	
DESCRIPTION	FINISH
SHOWROOM CURTAIN WALL WINDOW SILLS:	WILSONART "DESIGNER WHITE" MATTE FINISH D354-60
ALL SALES CENTER MILLWORK INCLUDING AMERICAN DISABILITY ACT COUNTER, TABLET CHARGING STATION, OFFICE DUTCH DOORS	VISIBLE EXTERIOR SURFACES: WILSONART "NORTH SEA" D90-60; CONCEALED INTERIOR SURFACES: STANDARD GRAY LINER
BREAKROOM BASE CABINET:	VISIBLE EXTERIOR SURFACES: WILSONART "NORTH SEA" D90-60; CONCEALED INTERIOR SURFACES: STANDARD GRAY LINER
BREAKROOM COUNTERTOP AND BACK SPLASH:	WILSONART "NORTH SEA" D90-60;
RESTROOM VANITY COUNTERTOP:	SOLID SURFACE: WILSONART, QUARTZ, POMPEII Q1007

ROOMS TO GO
 STORE EXPANSION AND REMODEL
 18722 SOUTH DIXIE HIGHWAY,
 CUTLER BAY, FL 33157

Date: 11/29/23
 CONSTR. DOC. & REVISIONS
 Description: 1. ADDENDUM 2
 No. 1

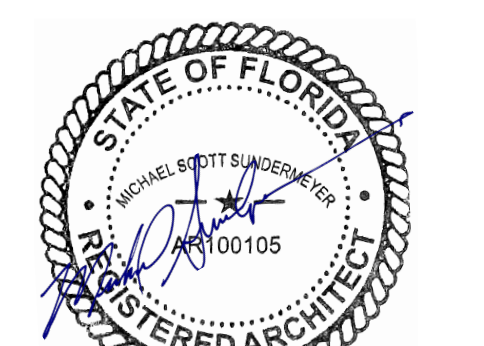

PROFESSIONAL OF RECORD
 MICHAEL SCOTT SUNDERMEYER
 License No.: AR00005
 Expiration Date: 03/28/25
 Drawn By/Checked By: dir/MSB
 Project Number: 2101445
 Bid Date: 11/09/23
 Permit: 03/28/23
 Owner Date: 07/06/22

MILLWORK DETAILS
A5.1

1 NOT USED
A5.5 SCALE:

2 NOT USED
A5.5 SCALE: 1/8" = 1'-0"

3 NOT USED
A5.5 SCALE:

4 NOT USED
A5.5 SCALE:

5 NOT USED
A5.5 SCALE:



6 NOT USED
A5.5 SCALE:

7 NOT USED
A5.5 SCALE: 1/8" = 1'-0"

8 NOT USED
A5.5 SCALE:

9 NOT USED
A5.5 SCALE:

10 GATE JAMB DETAIL
A5.5 SCALE: 1 1/2" = 1'-0"

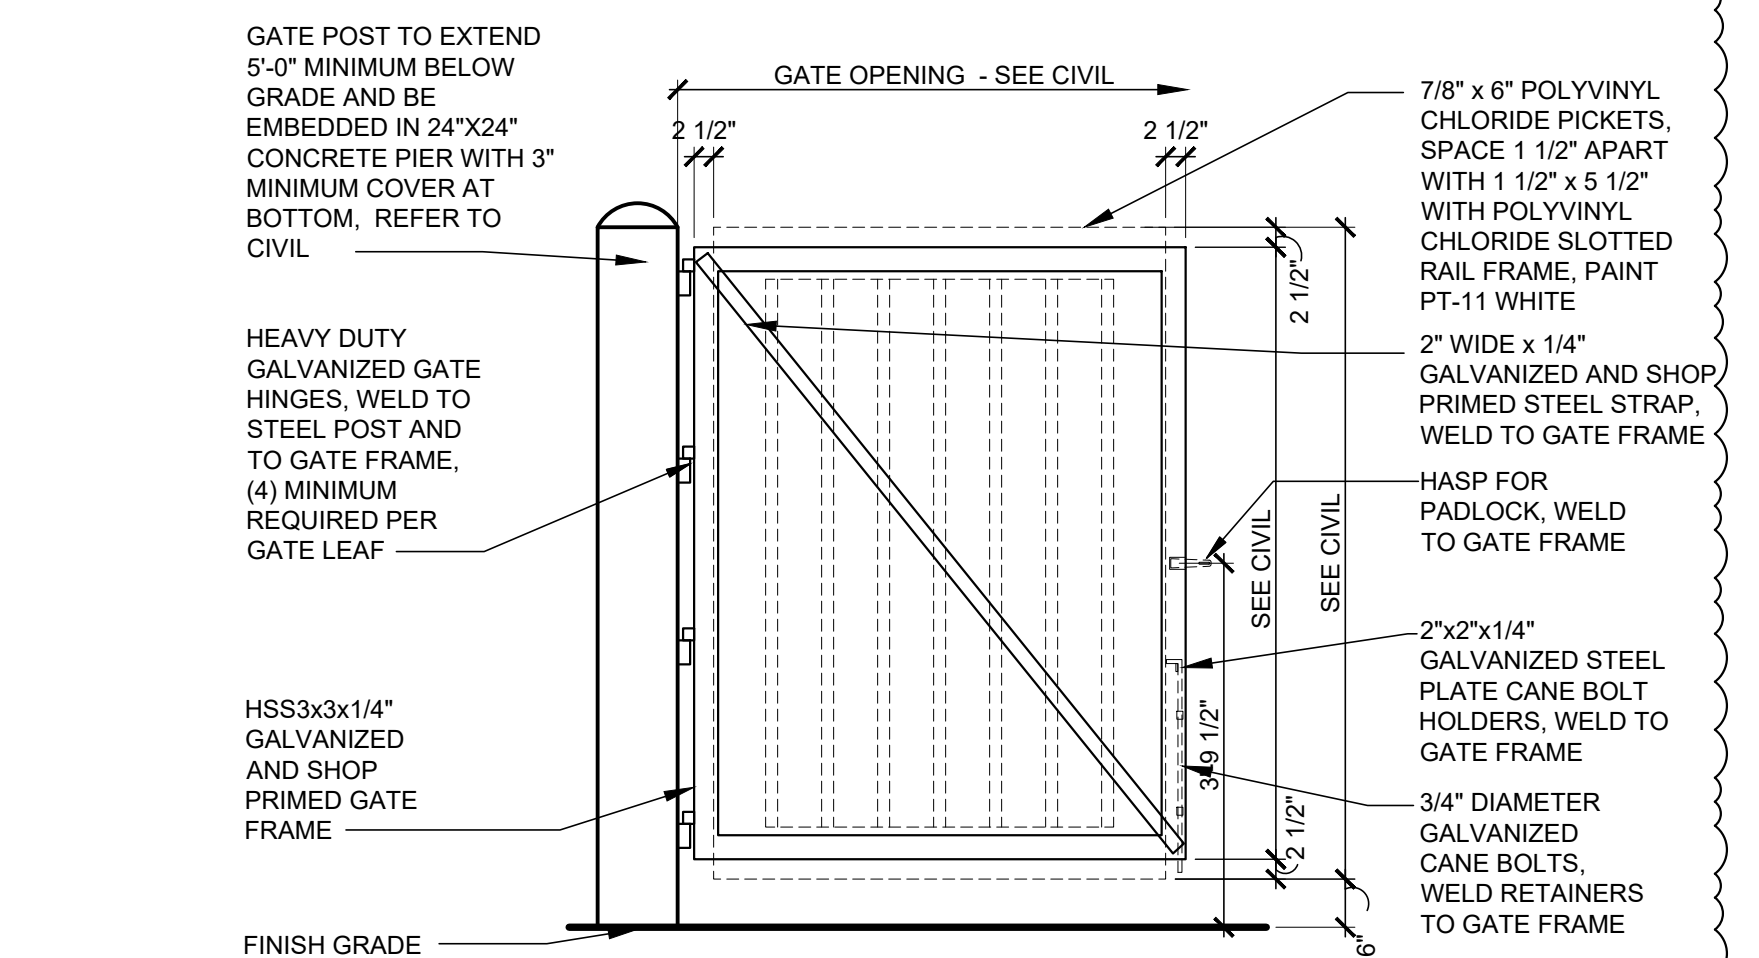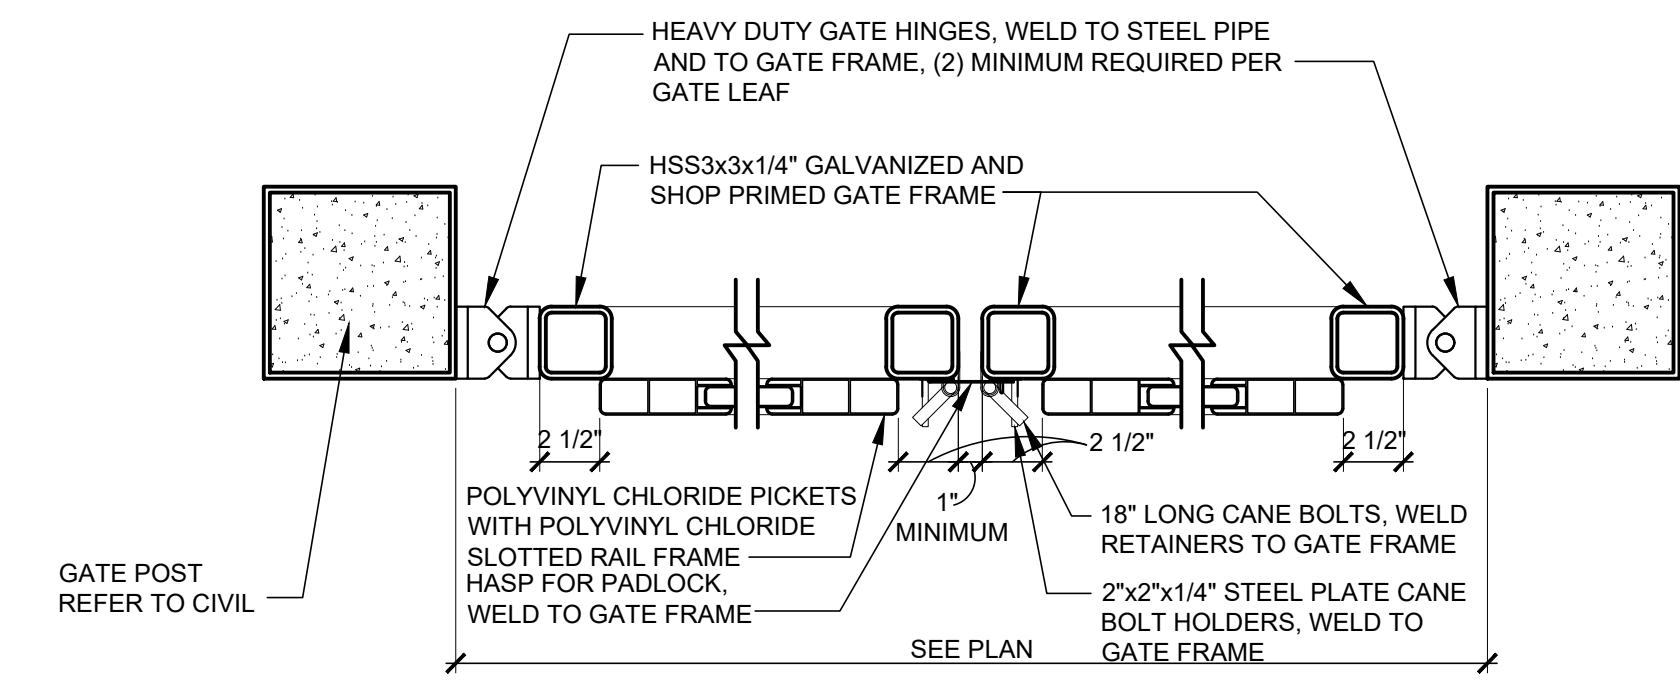

14 GATE FRAME ELEVATION
A5.5 SCALE: 1/2" = 1'-0"

11 NOT USED
A5.5 SCALE: 3/4" = 1'-0"

12 NOT USED
A5.5 SCALE: 3/4" = 1'-0"


13 NOT USED
A5.5 SCALE:

STORE EXPANSION AND REMODEL

ROOMS TO GO

18722 SOUTH DIXIE HIGHWAY,
CUTLER BAY, FL 33157

No.	Description	Date
C	CODE COMMENT RESPONSE	08/21/23
1	ADDENDUM 2	11/29/23

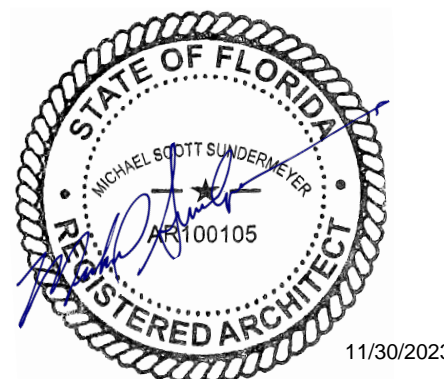


PROFESSIONAL OF RECORD
MICHAEL SCOTT SUNDERMEYER
License No.: AR000105
Expiration Date: 02/28/25


Drawn By/Checked By: dir/MSB
Project Number: 2101445
Bid Date: 11/09/23
Permit: 03/28/23
Owner Date: 07/06/22

DUMPSTER
ENCLOSURE
DETAILS
A5.5


CASCO
12 Sunnen Drive, Suite 100, St. Louis, MO 63143 T: 314.821.1100

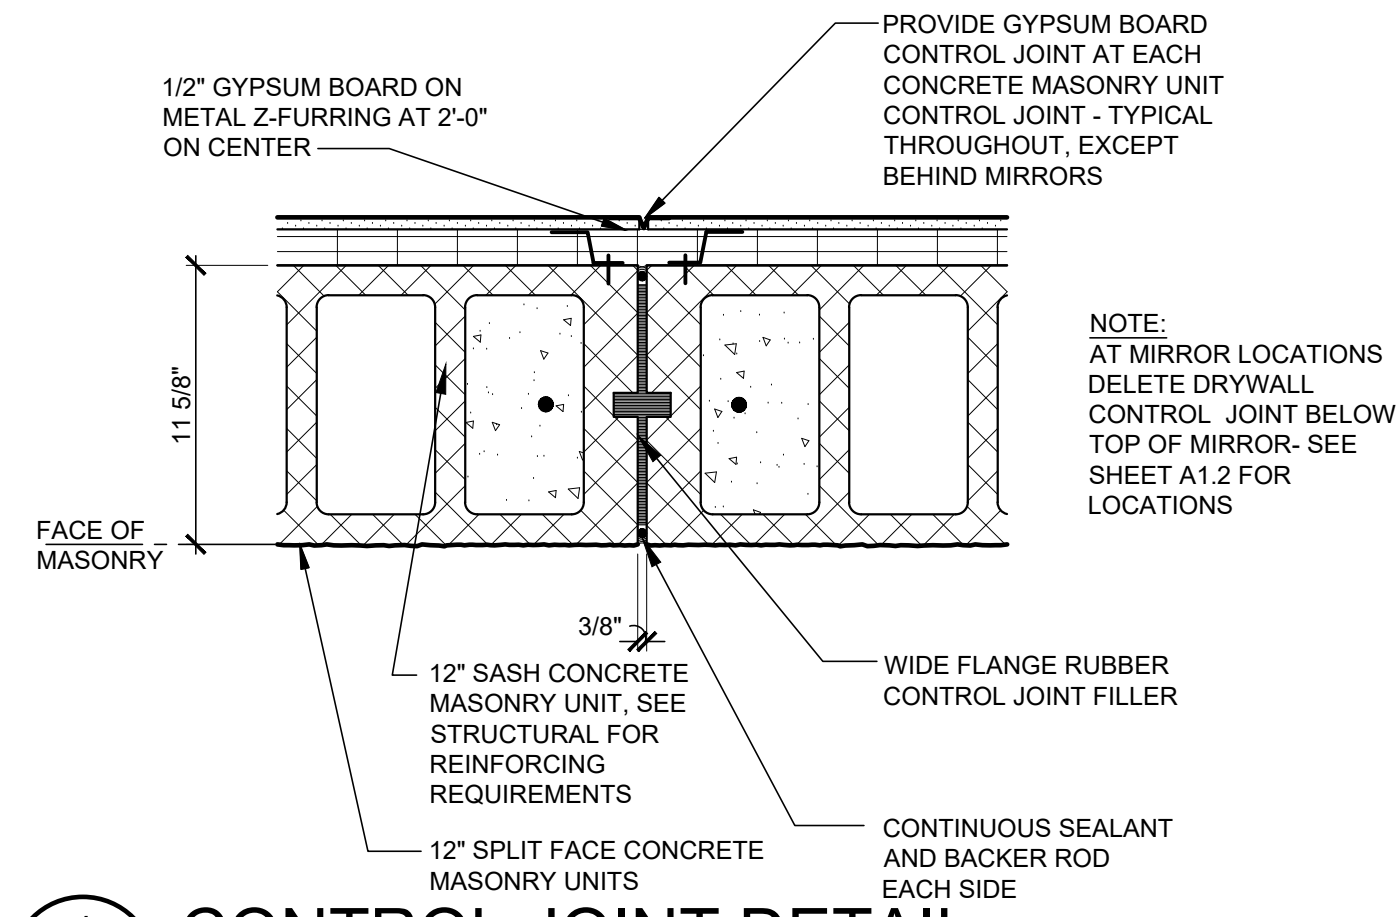

1
A5.6 CONTROL JOINT DETAIL
SCALE: 1 1/2" = 1'-0"

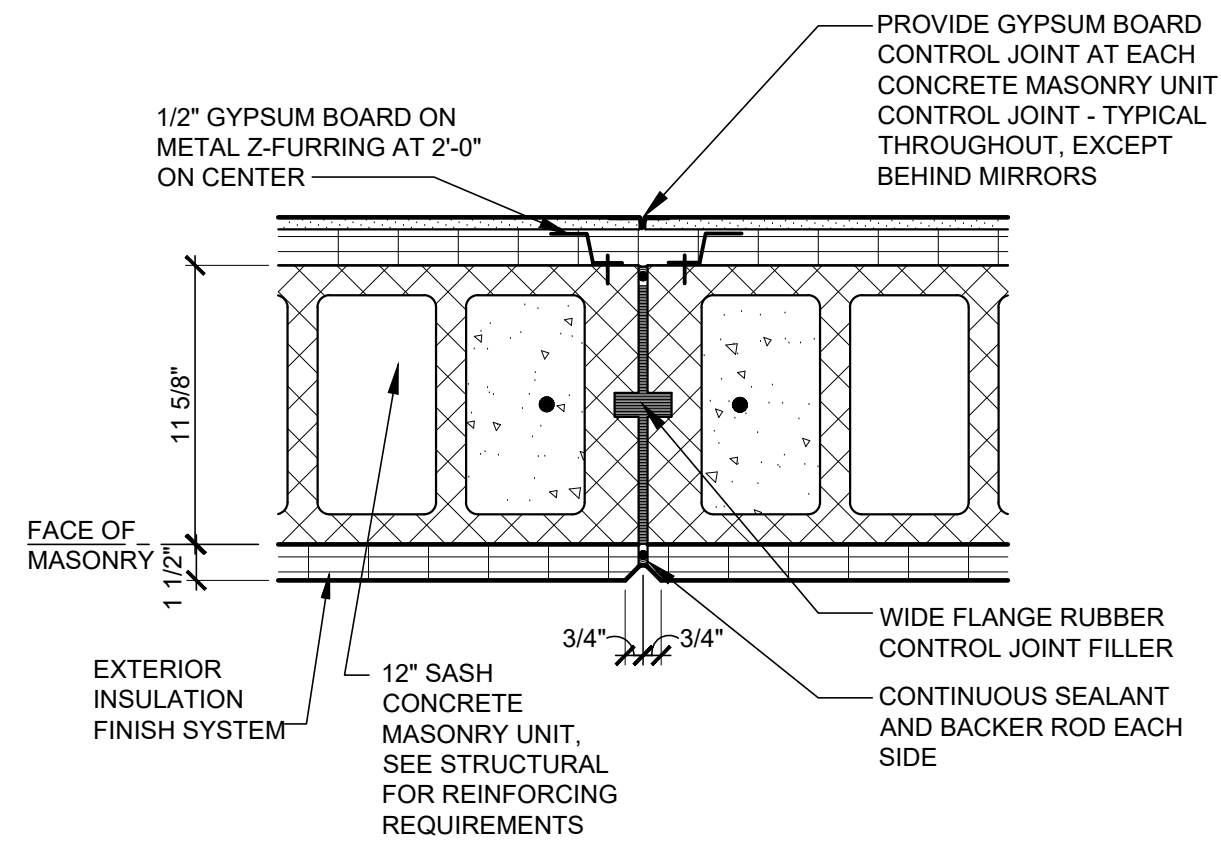

2
A5.6 CONTROL JOINT DETAIL
SCALE: 1 1/2" = 1'-0"

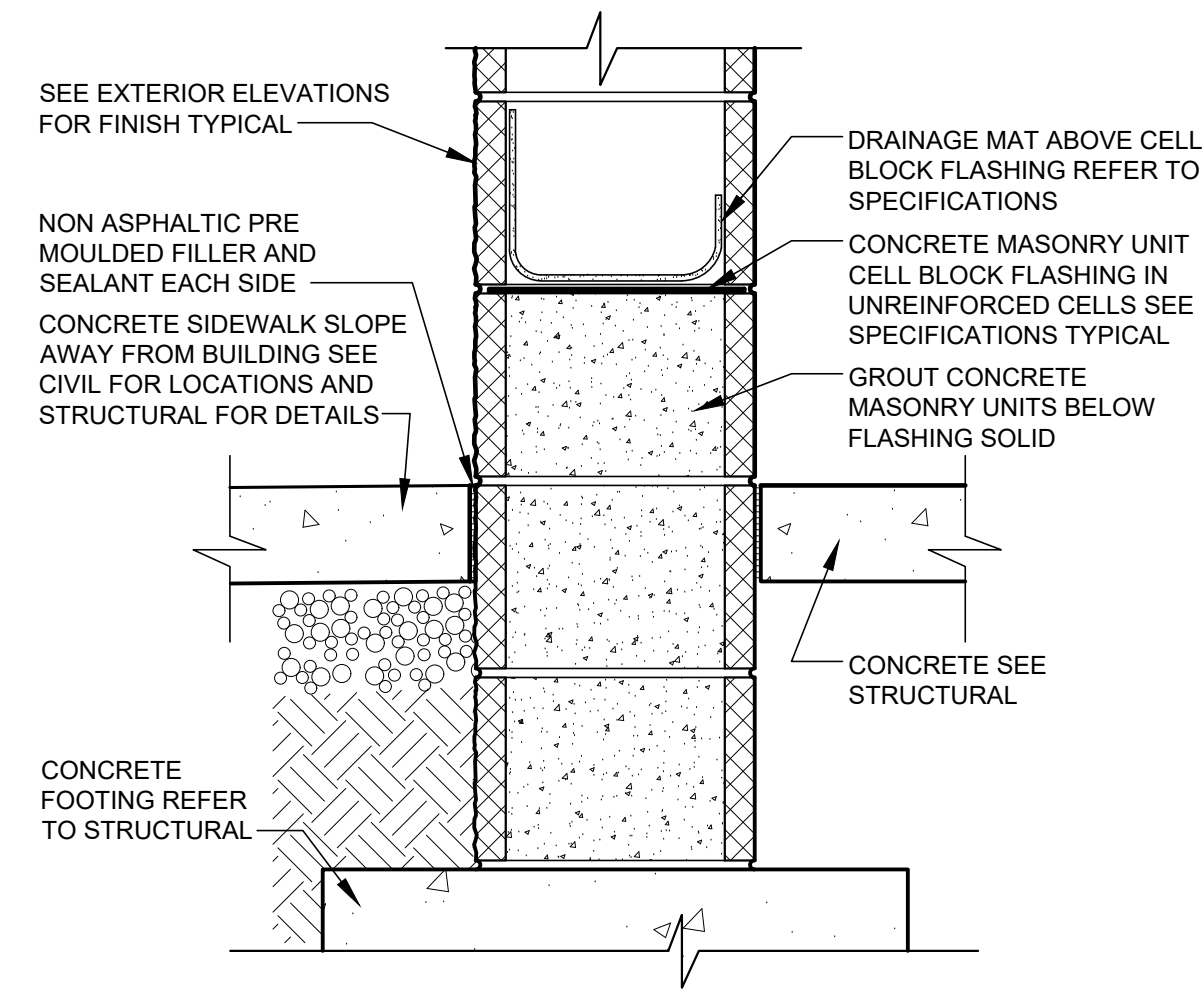

3
A5.6 PILASTER BASE FLASHING SECTION
SCALE: 1 1/2" = 1'-0"

4
A5.6 NOT USED
SCALE: 3/4" = 1'-0"

5
A5.6 NOT USED
SCALE: 1 1/2" = 1'-0"


6
A5.6 NOT USED
SCALE: 1" = 1'-0"

7
A5.6 NOT USED
SCALE:

8
A5.6 NOT USED
SCALE:

9
A5.6 NOT USED
SCALE:

10
A5.6 NOT USED
SCALE:

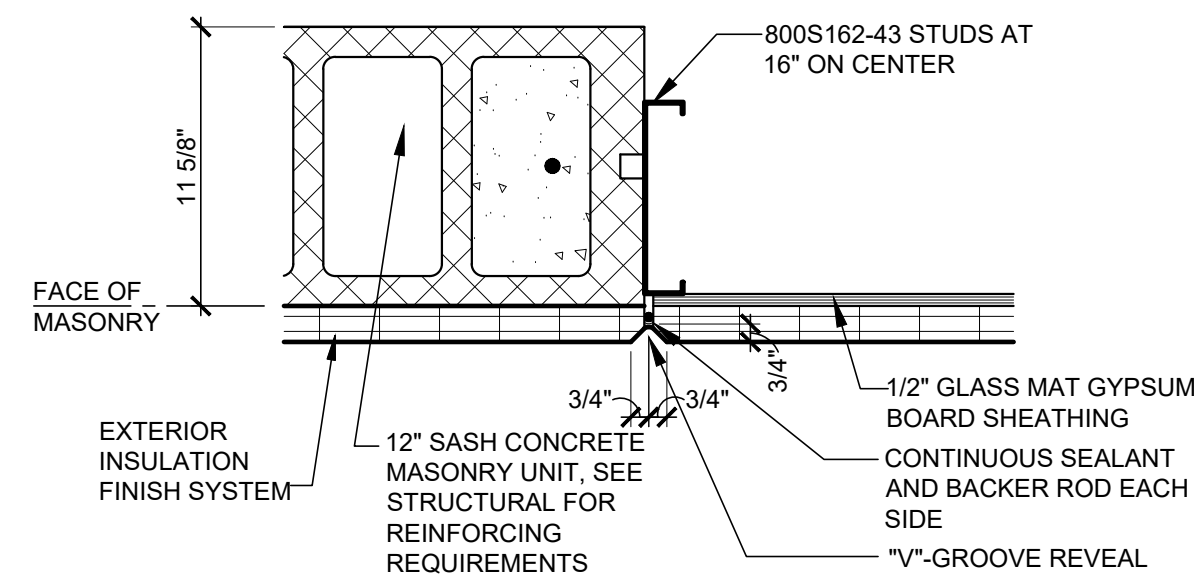

13
A5.6 "V"-GROOVE REVEAL DETAIL
SCALE: 1 1/2" = 1'-0"

11
A5.6 NOT USED
SCALE: 1 1/2" = 1'-0"


12
A5.6 NOT USED
SCALE: 1 1/2" = 1'-0"

STORE EXPANSION AND REMODEL

ROOMS TO GO

18722 SOUTH DIXIE HIGHWAY,
CUTLER BAY, FL 33157

CONSTR. DOC. & REVISIONS	
No.	Description
1	ADDENDUM 2

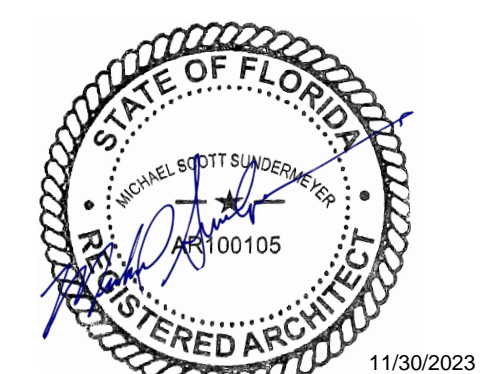


PROFESSIONAL OF RECORD
MICHAEL SCOTT SUNDERMEYER
License No.: AR000105
Expiration Date: 02/28/25


Drawn By/Checked By: dir/MSB
Project Number: 2101445
Bid Date: 11/09/23
Permit: 03/28/23
Owner Date: 07/06/22

MISCELLANEOUS
DETAILS


A5.6

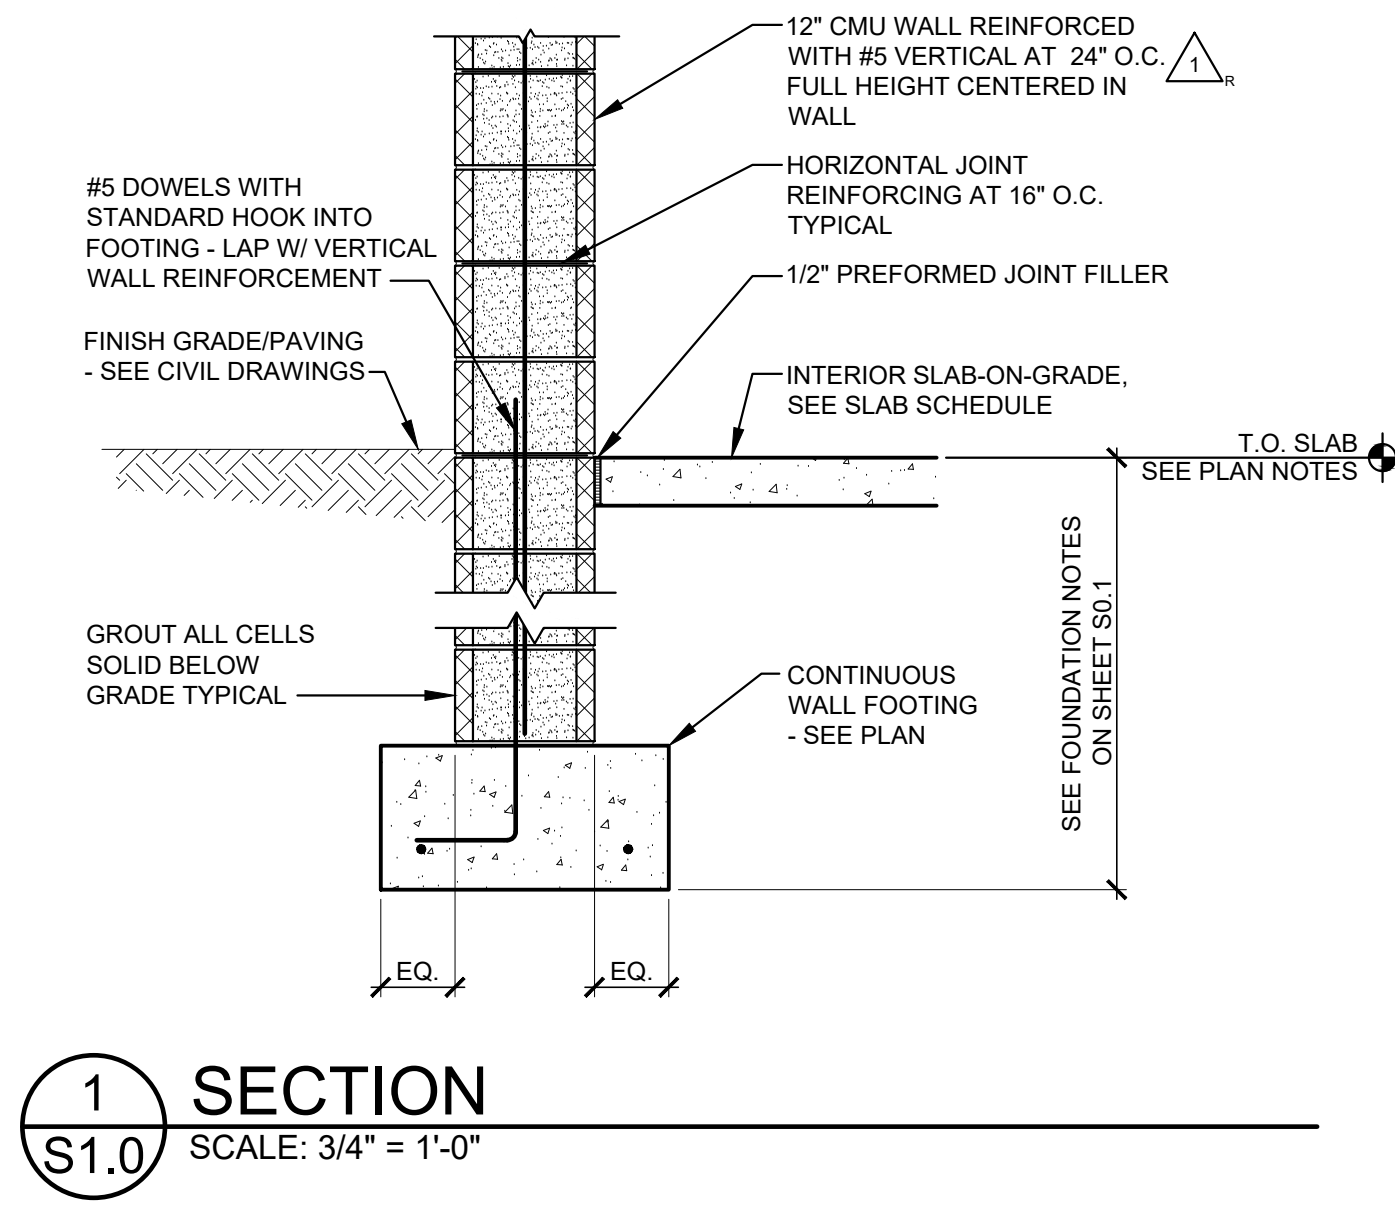


1 SECTION
SCALE: 3/4" = 1'-0"

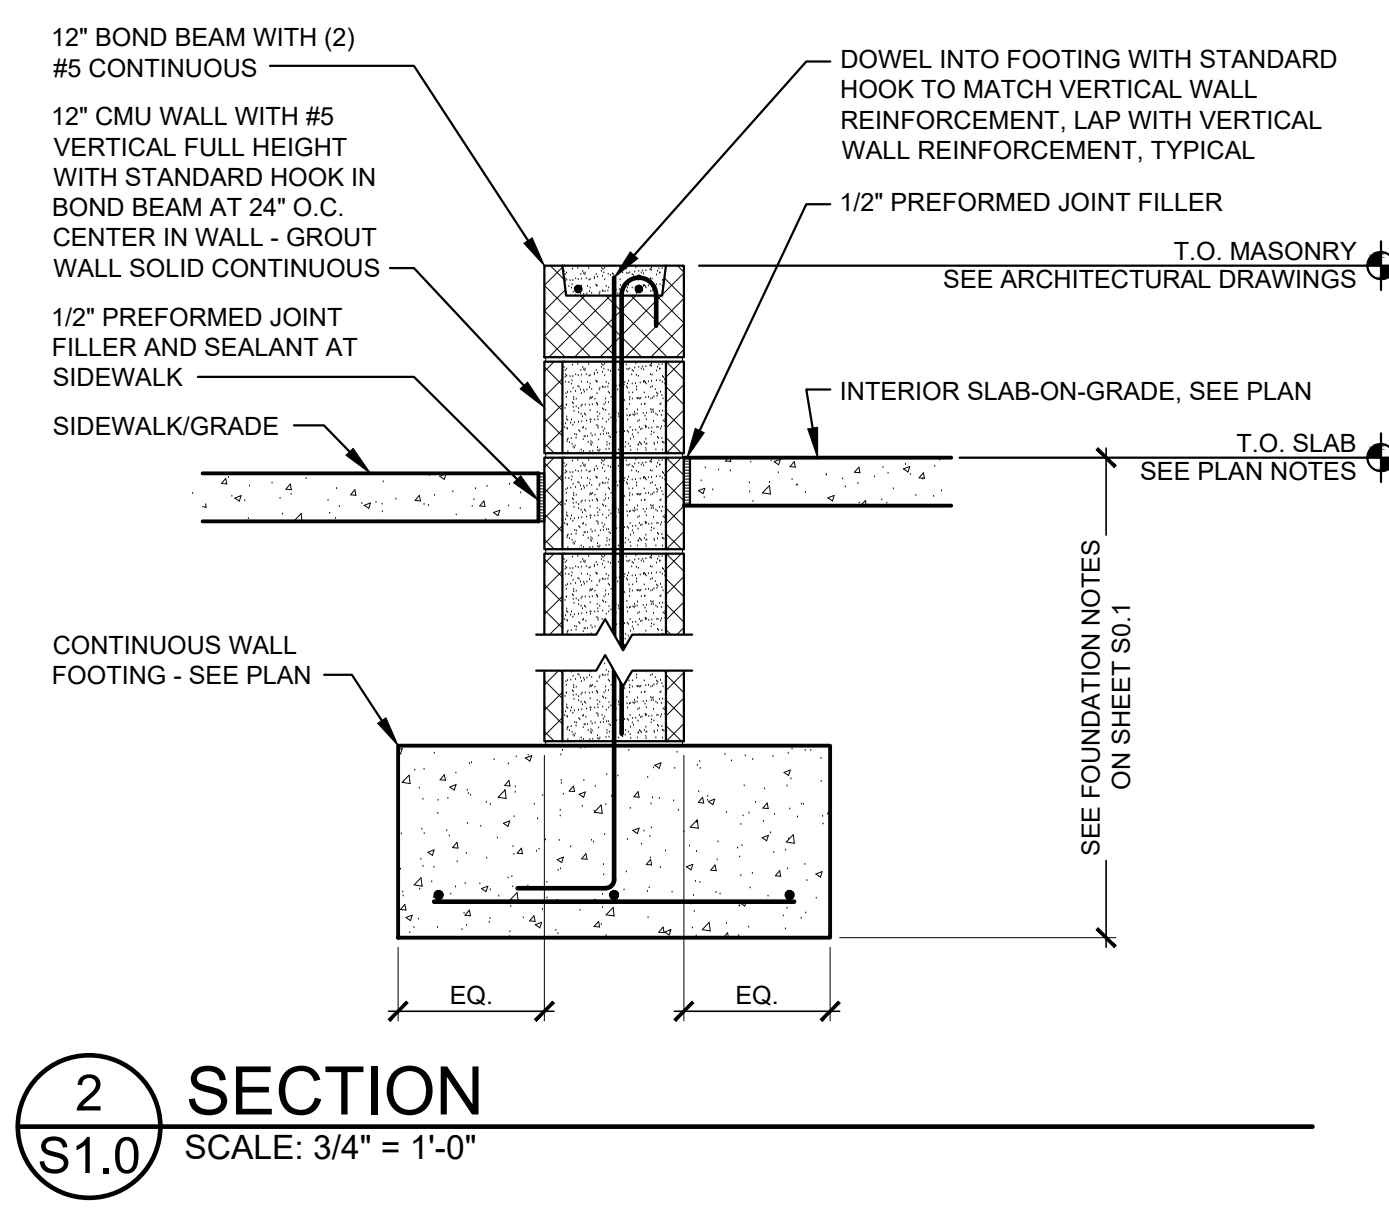


2 SECTION
SCALE: 3/4" = 1'-0"

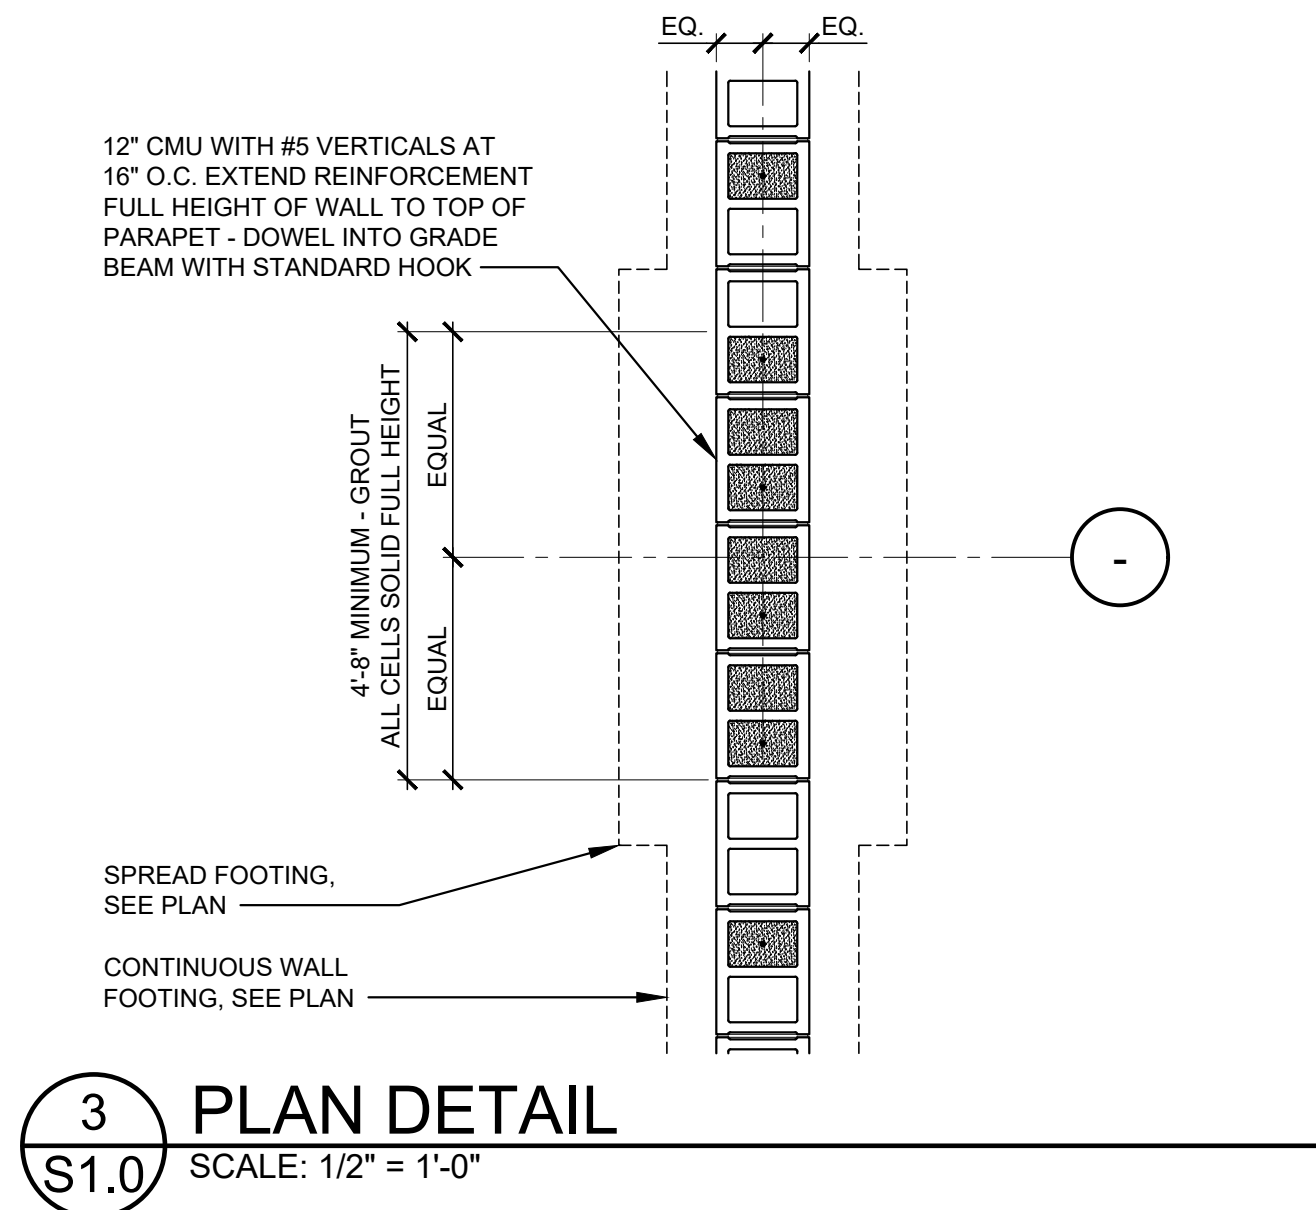


3 PLAN DETAIL
SCALE: 1/2" = 1'-0"

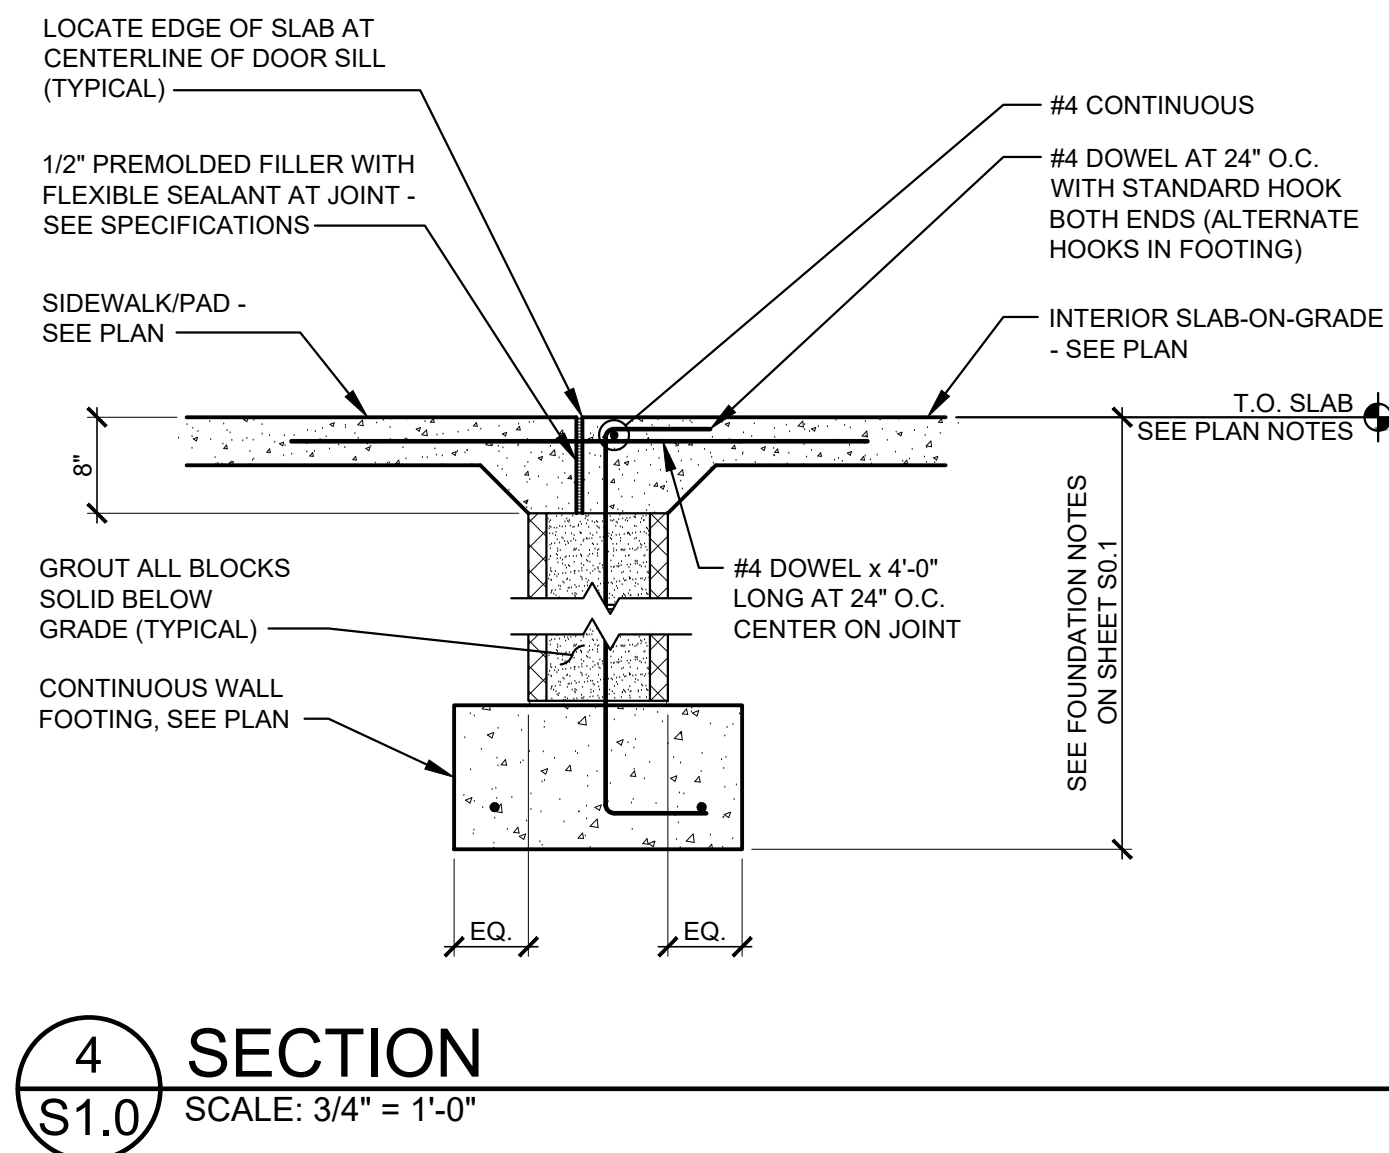


4 SECTION
SCALE: 3/4" = 1'-0"

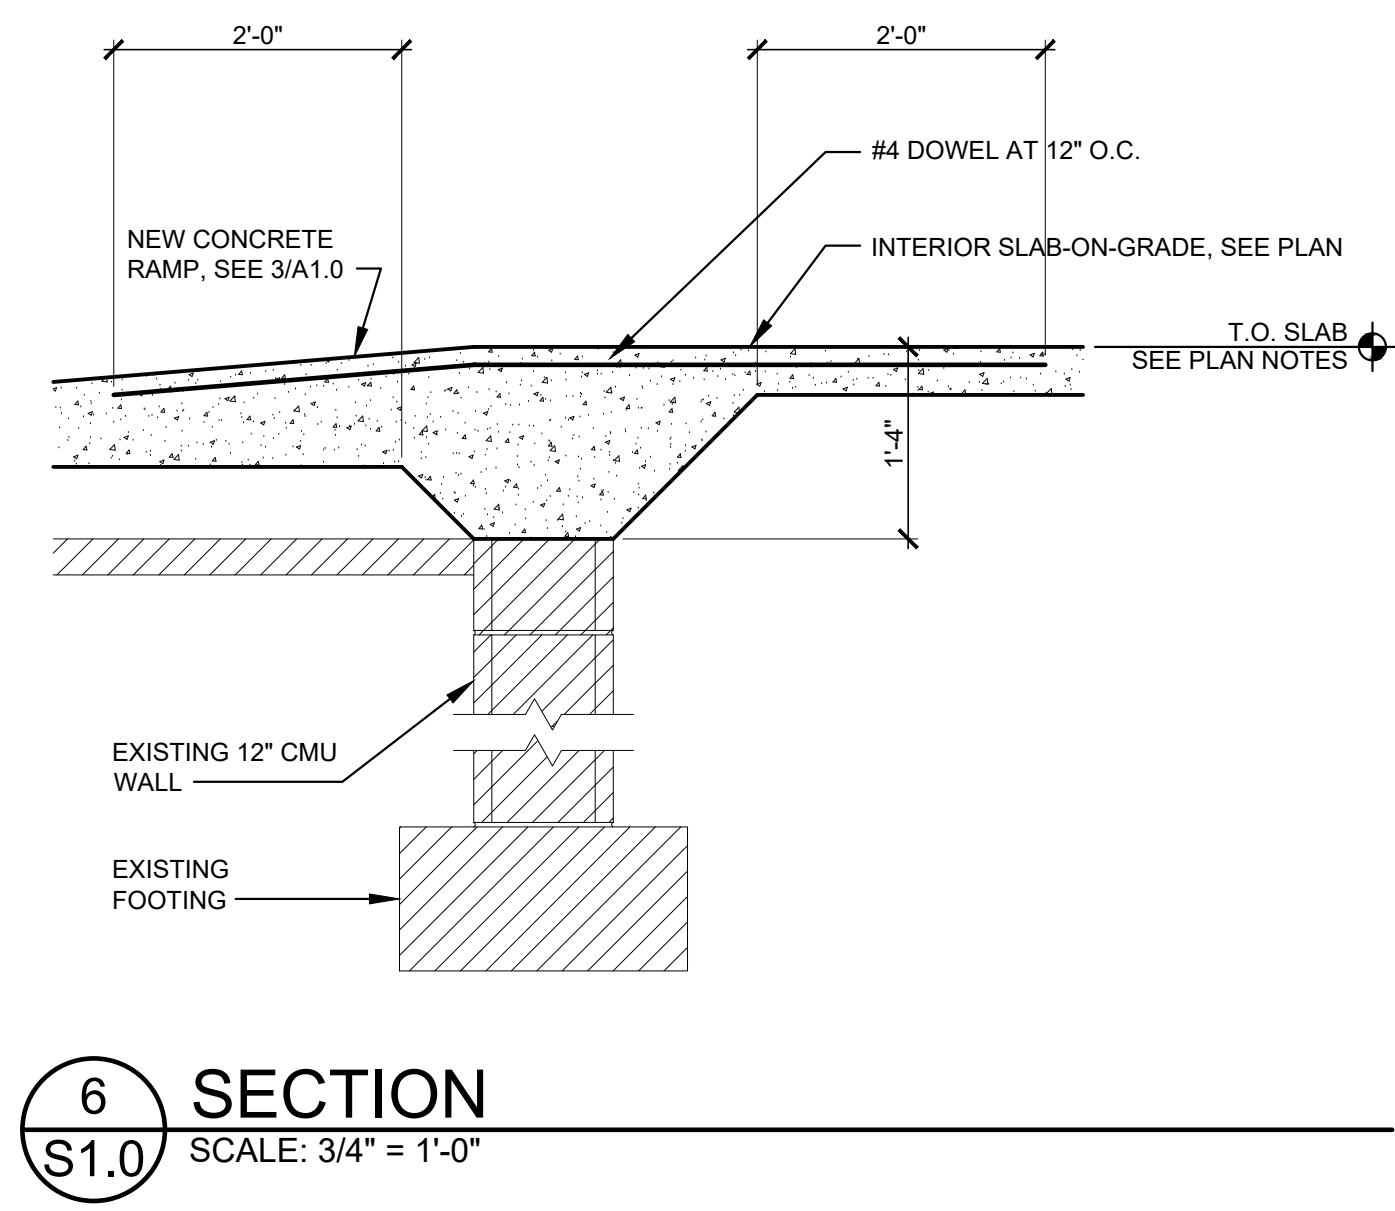


6 SECTION
SCALE: 3/4" = 1'-0"

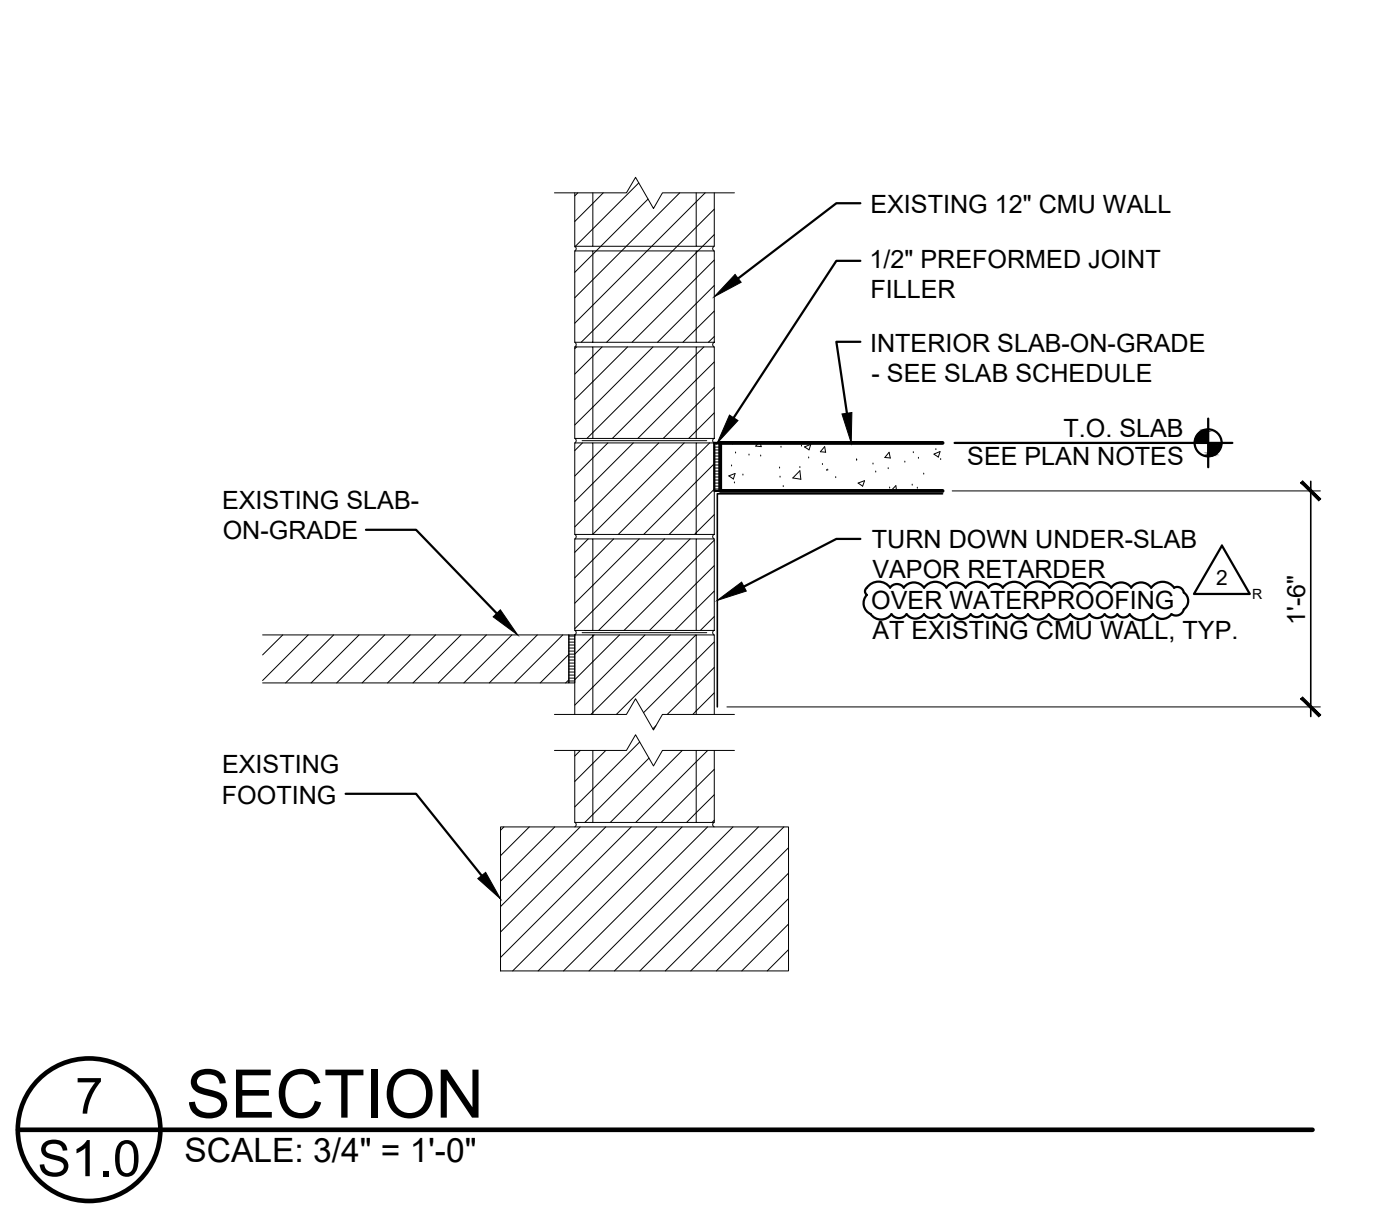


7 SECTION
SCALE: 3/4" = 1'-0"

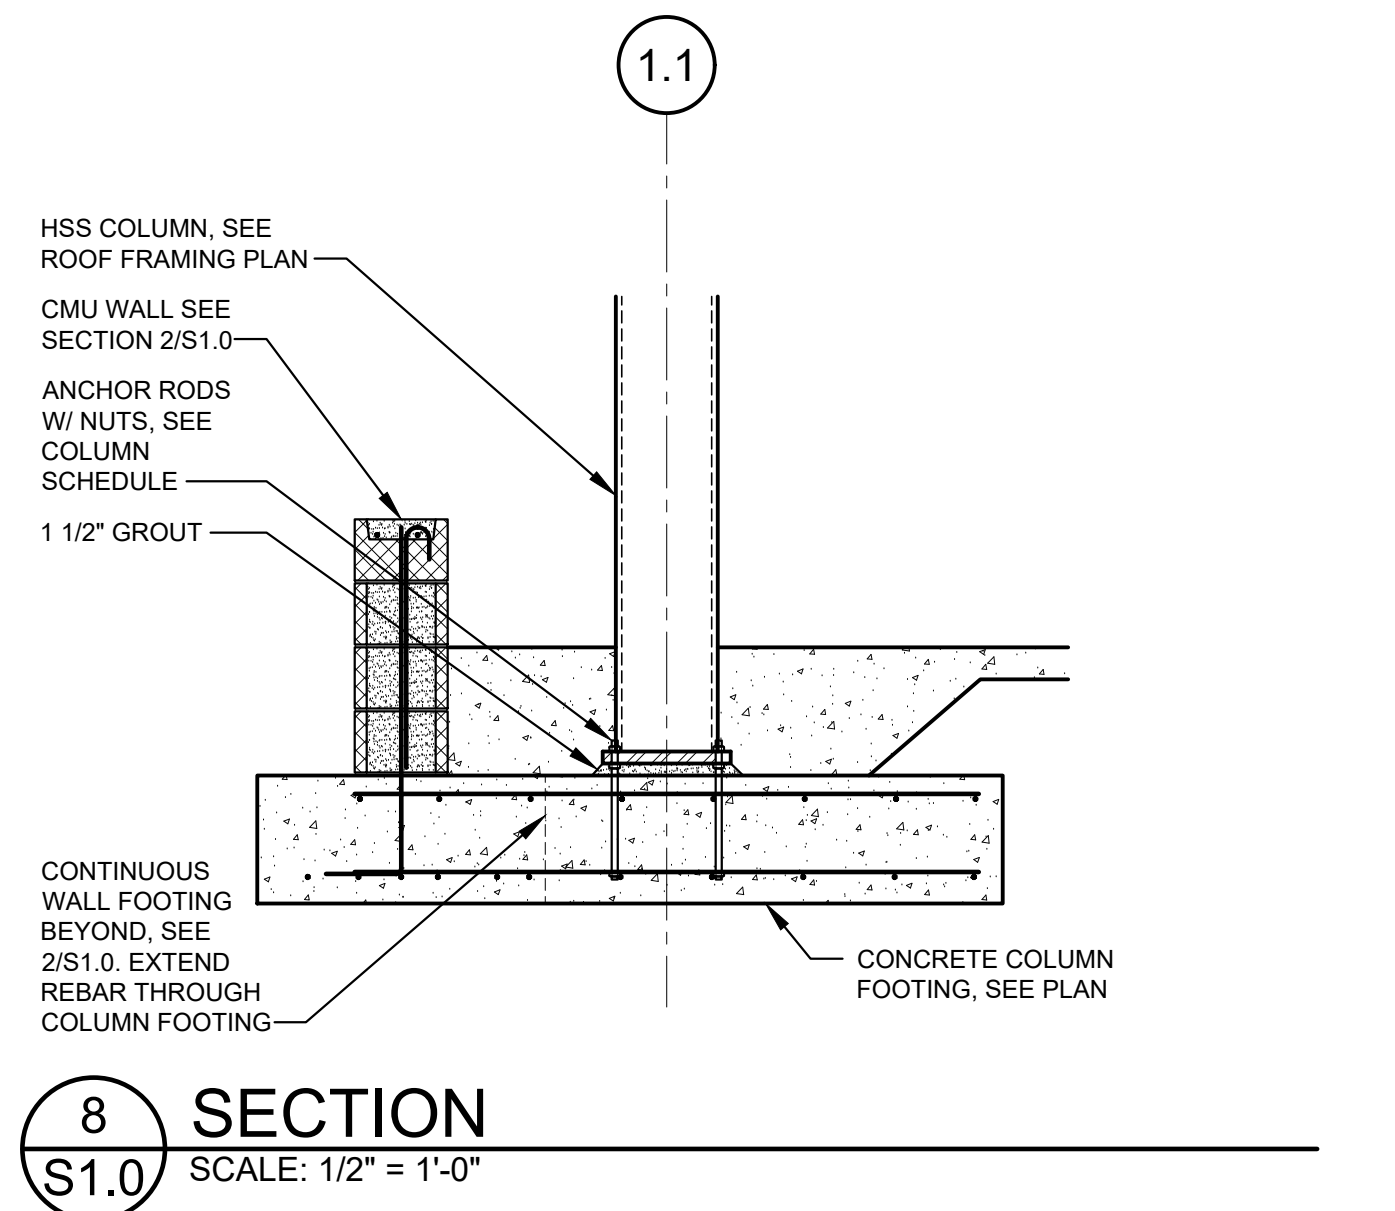

8 SECTION
SCALE: 1/2" = 1'-0"

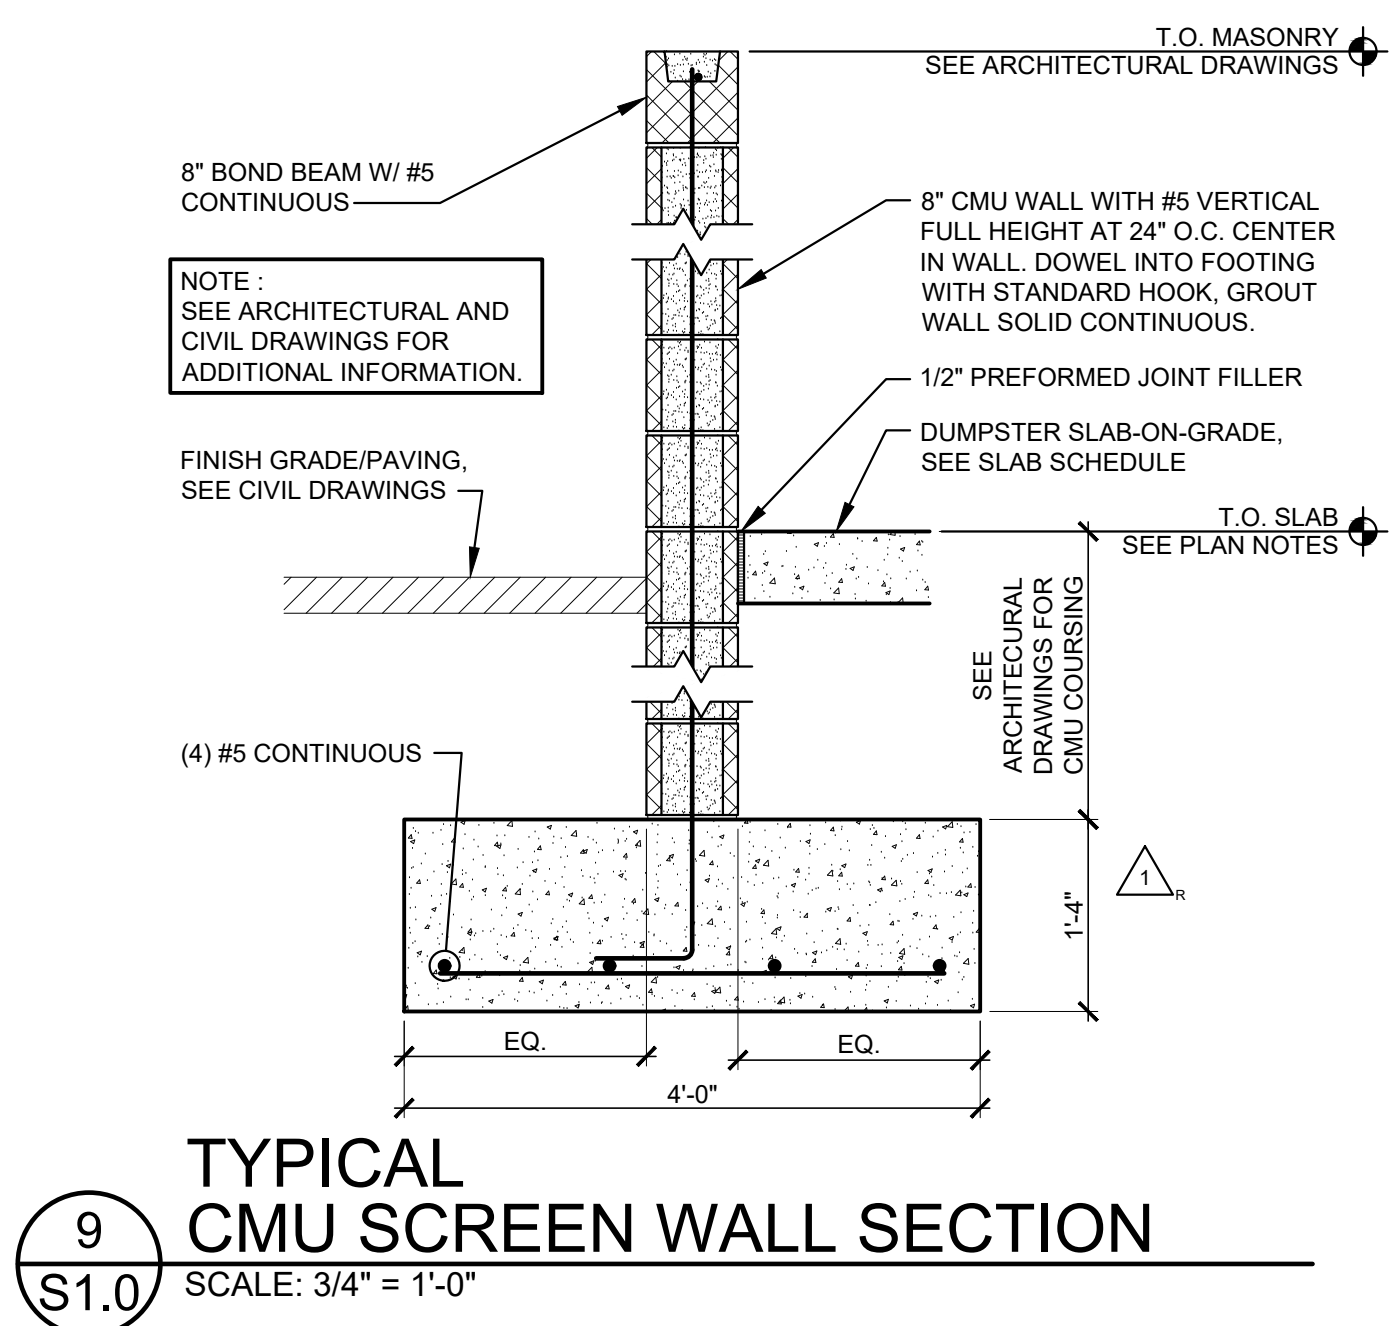

9 TYPICAL CMU SCREEN WALL SECTION
SCALE: 3/4" = 1'-0"

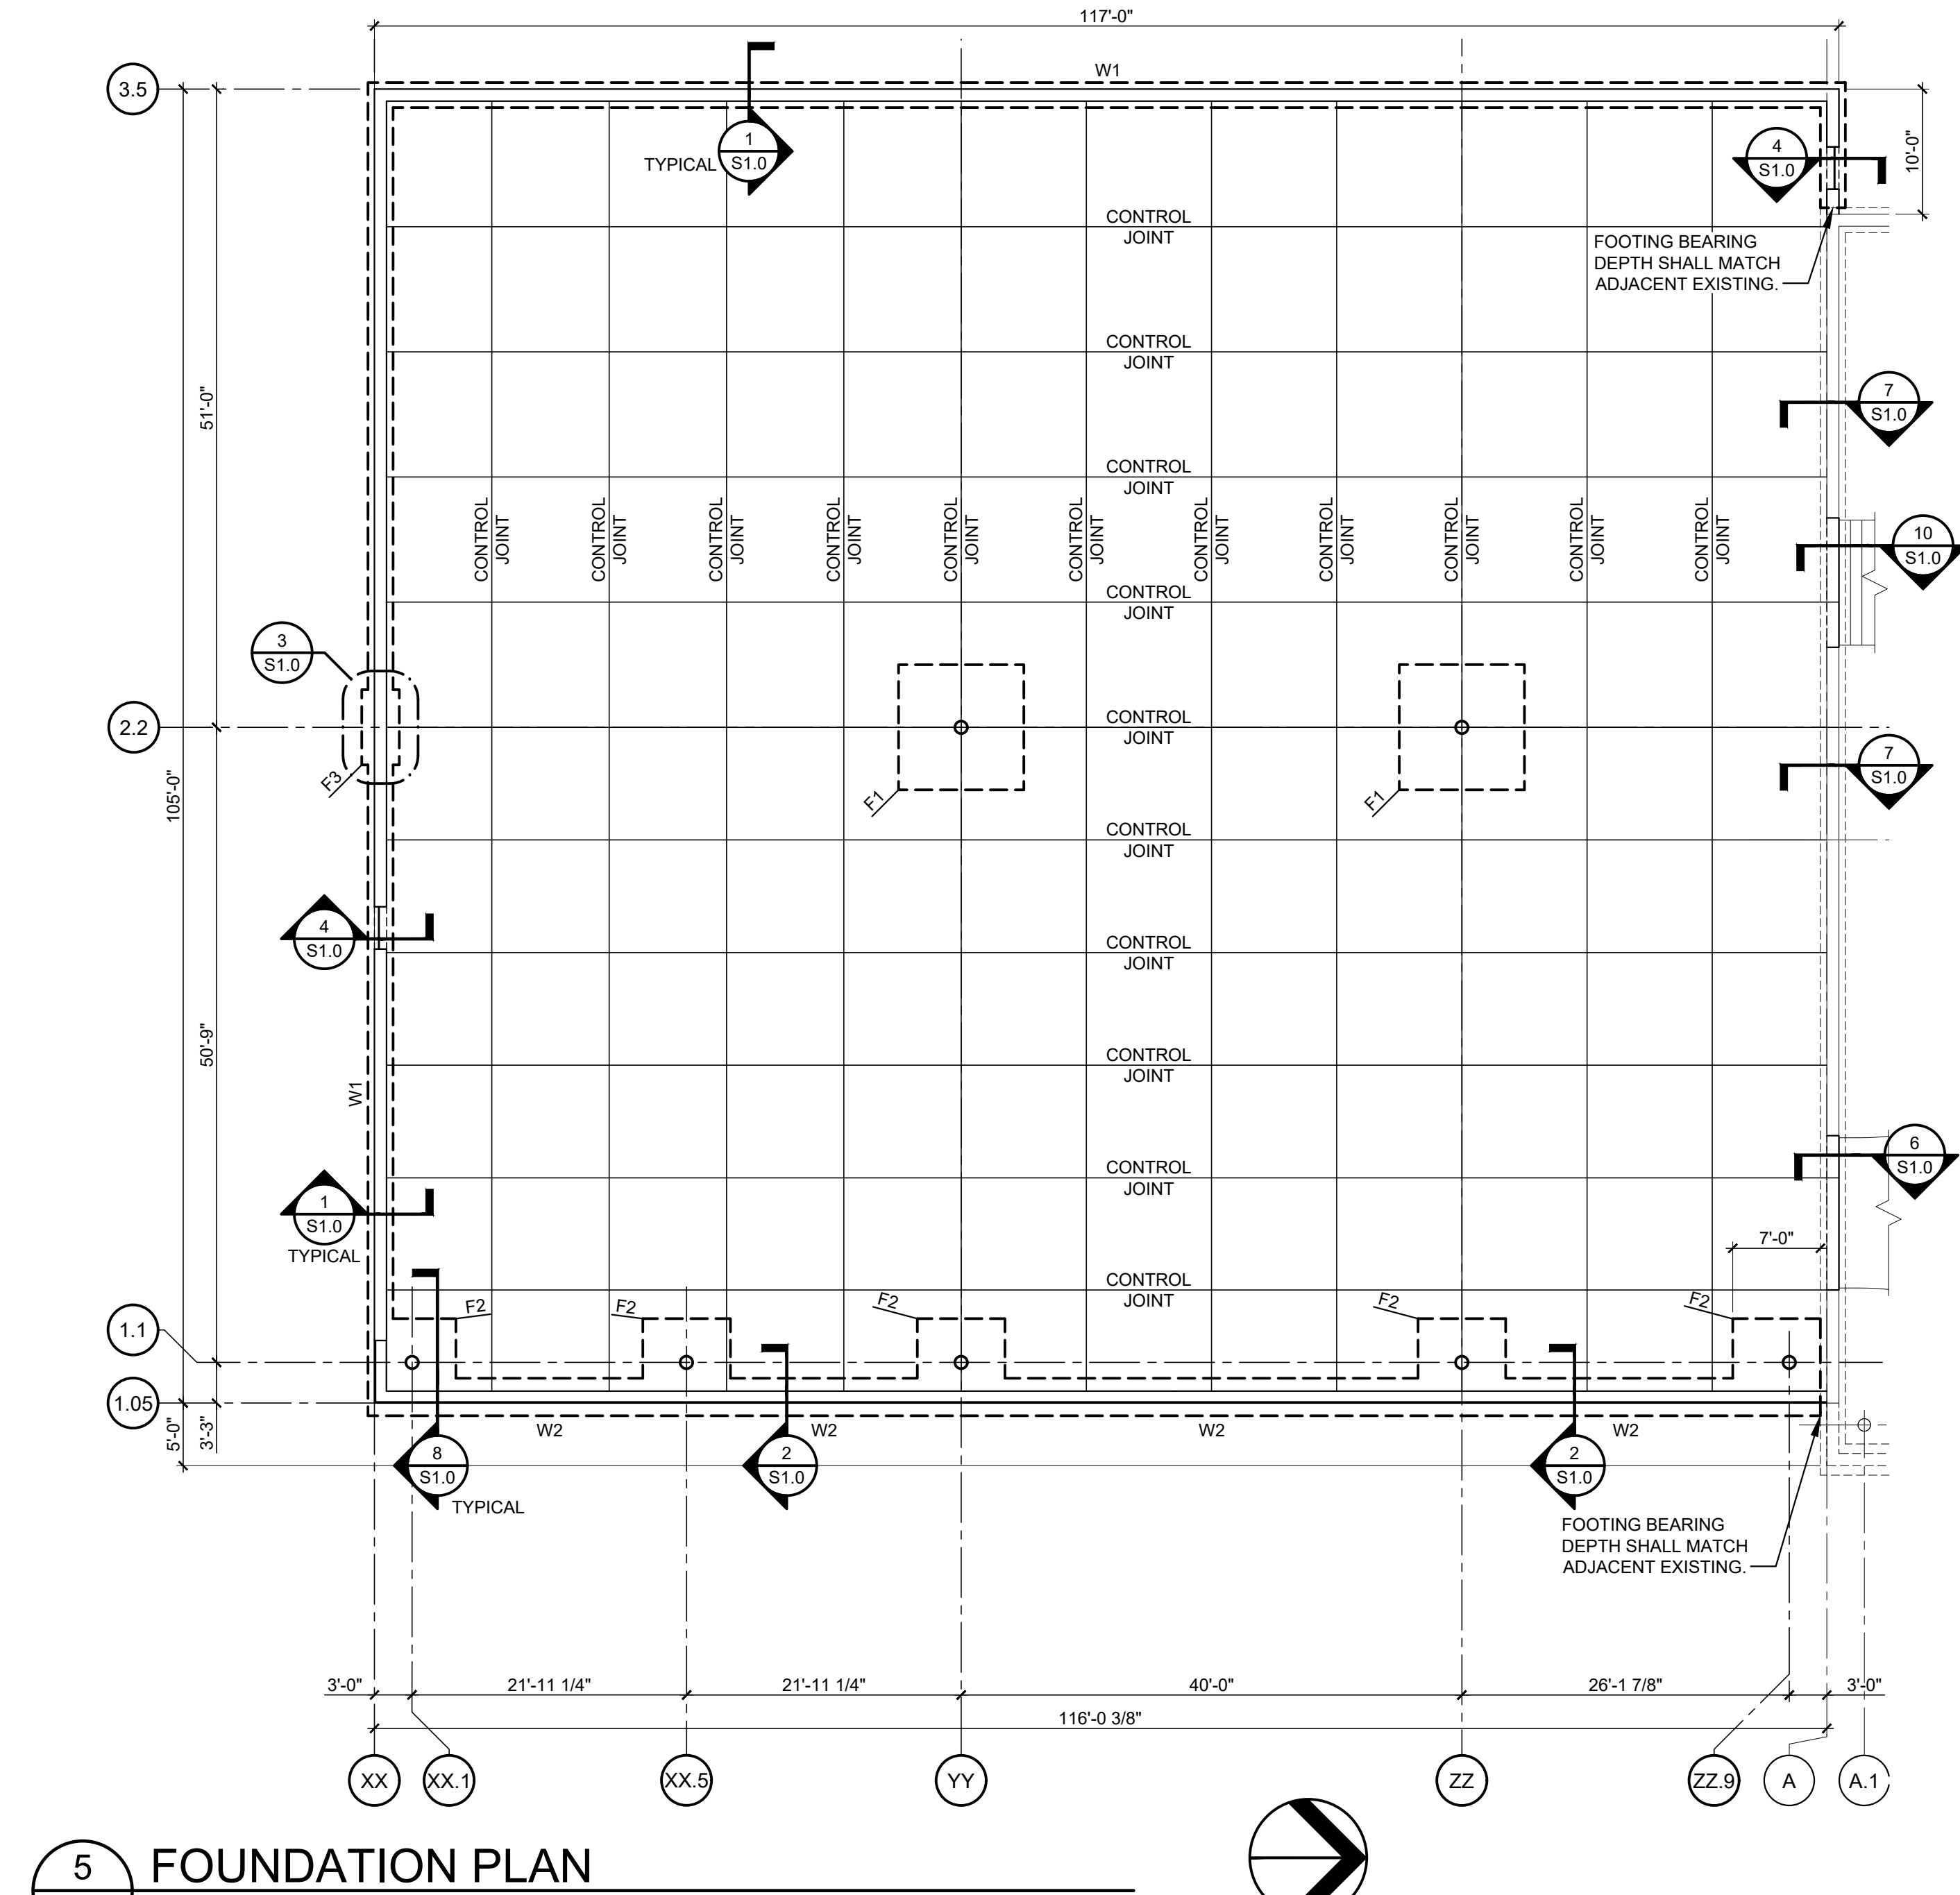

5 FOUNDATION PLAN
SCALE: 3/32" = 1'-0"

FOUNDATION PLAN NOTES

- SEE SHEETS S0.1 AND S0.2 FOR GENERAL NOTES AND TYPICAL DETAILS.
- ALL ELEVATIONS BASED ON EXISTING FINISH FLOOR ELEVATION = 100'-0" AND NEW FINISH FLOOR ELEVATION = 101'-4" FOR REFERENCE ONLY. SEE SITE PLAN FOR ACTUAL FINISH FLOOR ELEVATIONS.
- TOP OF INTERIOR FOOTING (TF) = 100'-8" UNLESS NOTED OTHERWISE ON PLAN. SEE GENERAL STRUCTURAL NOTES FOR TOP OF EXTERIOR FOOTING ELEVATIONS. THE GENERAL CONTRACTOR SHALL COORDINATE ALL TOP OF FOOTING ELEVATIONS WITH THE CIVIL ENGINEERING DRAWINGS AND SITE CONDITIONS. FOOTINGS SHALL BE STEPPED IN ACCORDANCE WITH THE TYPICAL STEPPED FOOTING DETAIL.
- CENTER ALL FOOTINGS ON COLUMN AND WALL CENTERLINES, UNLESS NOTED OTHERWISE.
- CONTINUOUS WALL FOOTING REINFORCING SHALL BE PLACED CONTINUOUS THROUGH ISOLATED COLUMN FOOTINGS.
- SEE ARCHITECTURAL PLANS AND DETAILS FOR TYPICAL INTERIOR WALL PARTITION SUPPORTS THAT PENETRATE SLAB.


FOOTING SCHEDULE

MARK	SIZE	REINFORCING
W1	2'-0" x 1'-0" x CONTINUOUS	(2) #5 CONTINUOUS - BOTTOM
W2	3'-0" x 1'-4" x CONTINUOUS	(3) #5 CONTINUOUS - BOTTOM
F1	10'-8" x 10'-8" x 2'-0"	(11) #6 EACH WAY - TOP & BOTTOM
F2	7'-6" x 7'-6" x 1'-4"	(8) #5 EACH WAY - TOP & BOTTOM
F3	6'-0" x 3'-0" x 1'-0"	(4) #5 LONG WAY - BOTTOM

SLAB SCHEDULE

LOCATION	THICKNESS & REINFORCING	REMARKS
INTERIOR SLAB ON GRADE	4" CONCRETE SLAB ON GRADE REINFORCED WITH MINIMUM 1.0 LBS./YARD POLYPROPYLENE FIBRILLATED FIBERS - SEE PROJECT SPECIFICATIONS	VAPOR RETARDER PER SPECIFICATION OVER COMPACTED SUB-GRADE PER PROJECT GEOTECHNICAL REPORT
SIDEWALK	4" CONCRETE SLAB ON GRADE REINFORCED WITH MINIMUM 1.0 LBS./YARD POLYPROPYLENE FIBRILLATED FIBERS - SEE PROJECT SPECIFICATIONS	COMPACTED SUBBASE PER PROJECT GEOTECHNICAL REPORT. SEE ARCHITECTURAL DRAWINGS FOR SLAB JOINTS AND PLAN LAYOUT
DUMPSTER SLAB	6" CONCRETE SLAB ON GRADE REINFORCED WITH #4 BARS AT 18" O.C. EACH WAY - CENTER	COMPACTED SUBBASE PER PROJECT GEOTECHNICAL REPORT

* THICKNESS OF SLABS AS SPECIFIED IN SCHEDULE ARE MINIMUMS. THERE SHALL BE NO TOLERANCE FOR SLABS THINNER THAN THOSE SPECIFIED IN SCHEDULE.

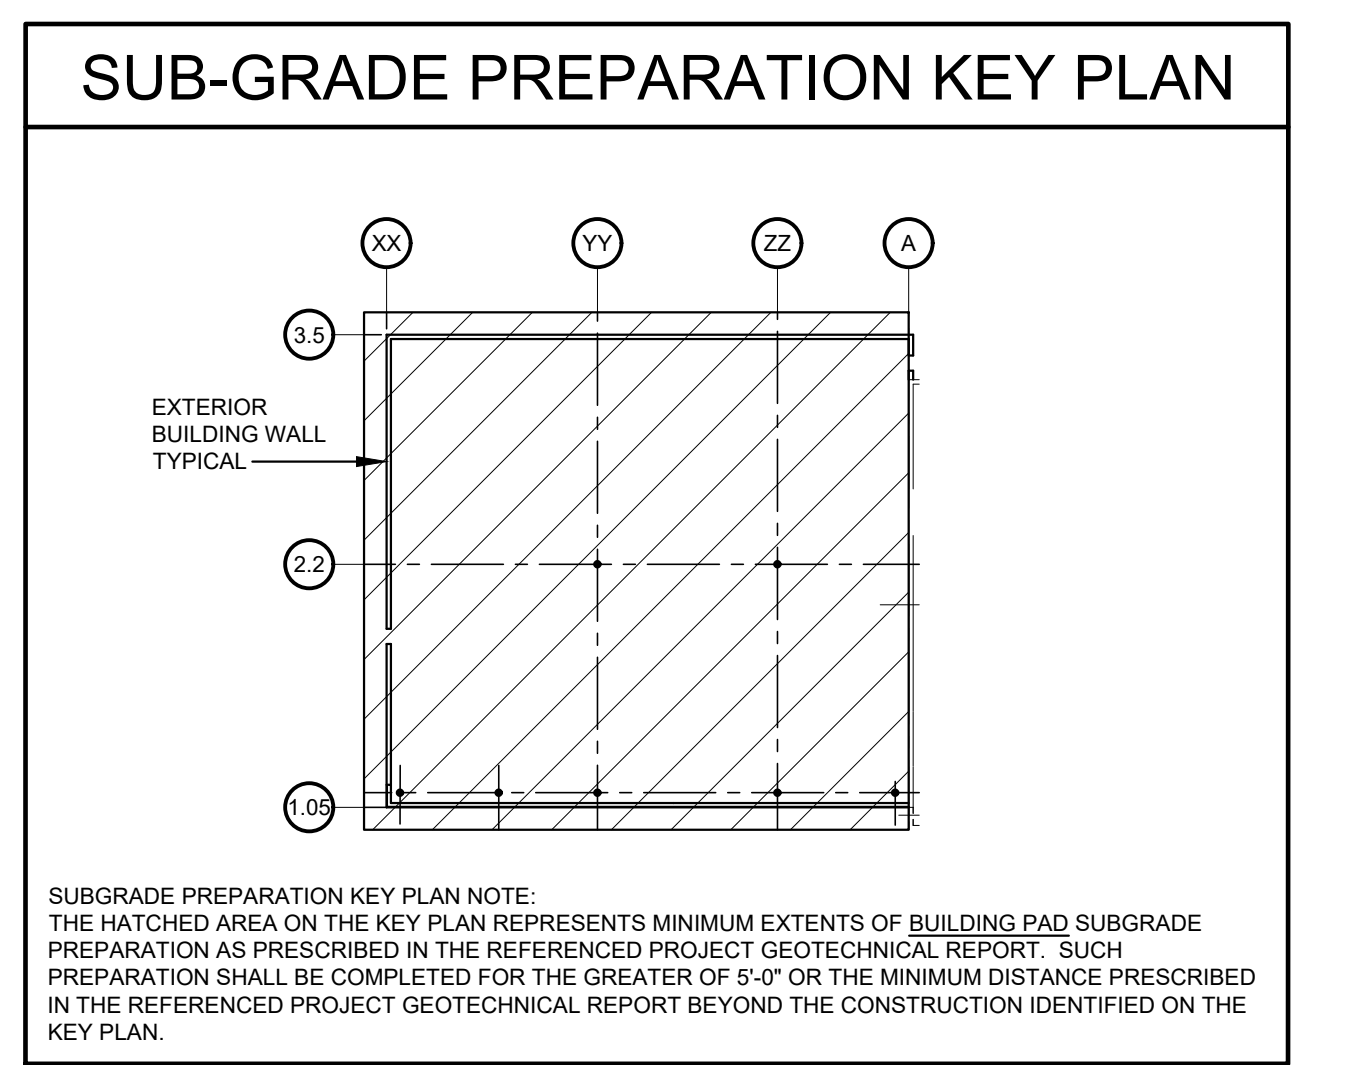


10 SECTION
SCALE: 3/4" = 1'-0"

ROOMS TO GO STORE EXPANSION AND REMODEL
18722 SOUTH DIXIE HIGHWAY, CUTLER BAY, FL 33157

CONSTR. DOC. & REVISIONS


No.	Description	Date
1 <td>CODE RESPONSE</td> <td>08/21/23</td>	CODE RESPONSE	08/21/23
2 <td>ADDENDUM #2</td> <td>11/29/23</td>	ADDENDUM #2	11/29/23

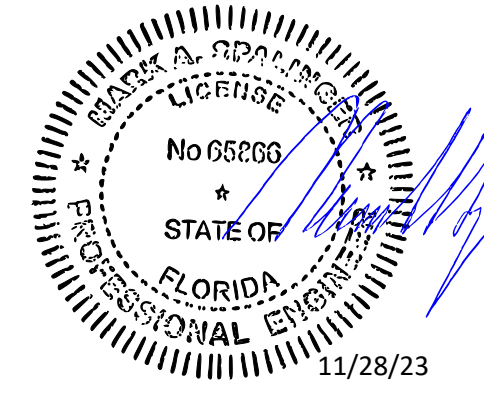


PROFESSIONAL OF RECORD
MARK A. SPALINGER
LICENSE NUMBER 68800
EXPIRATION DATE 02/28/25

Drawn By/Checked By: MPD/MPD
Project Number: 2101445
Bid Date: 11/09/23
Permit: 03/28/23
Owner Date: 07/06/22


FOUNDATION PLAN
S1.0

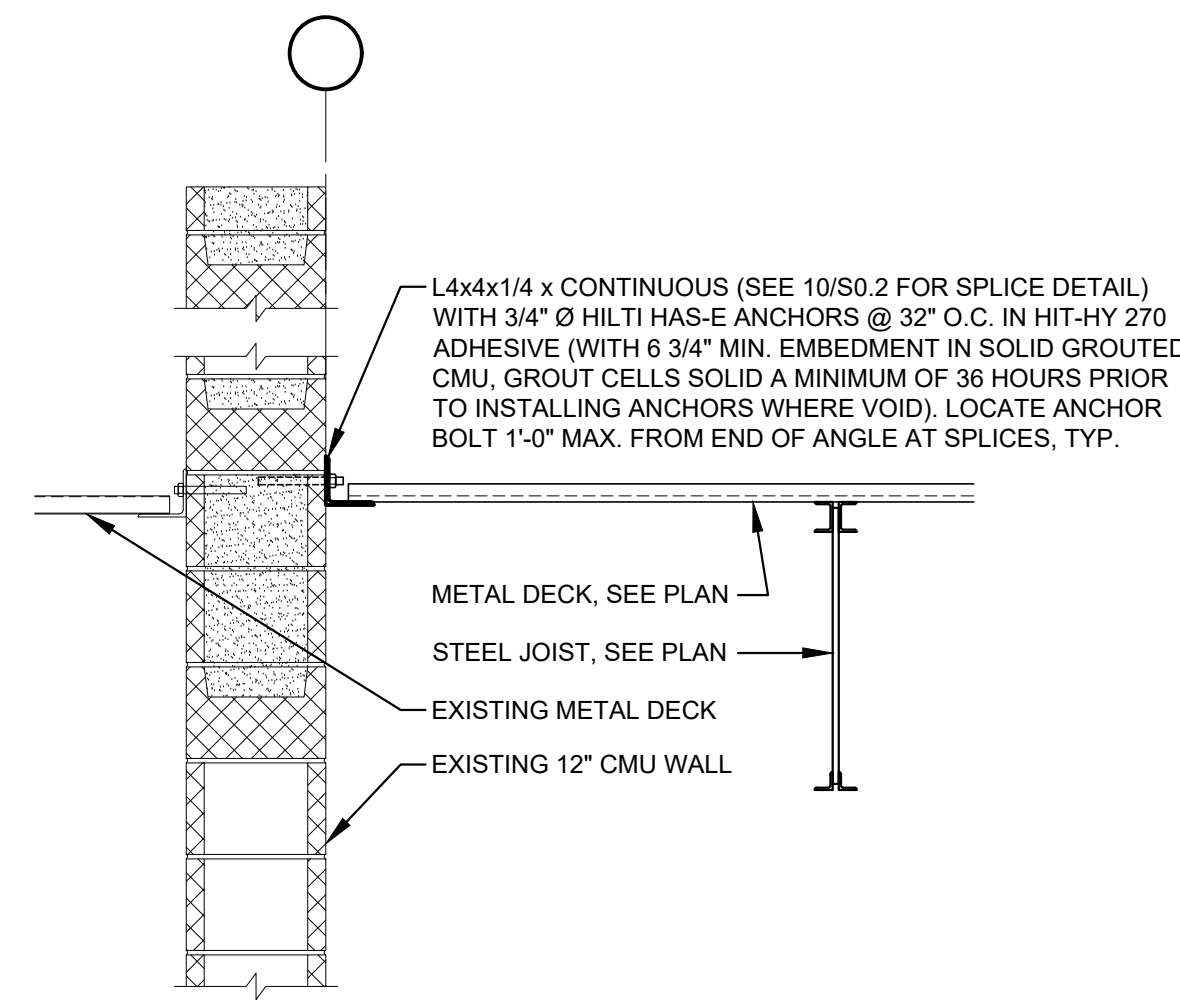


1 SECTION
SCALE: 3/4" = 1'-0"

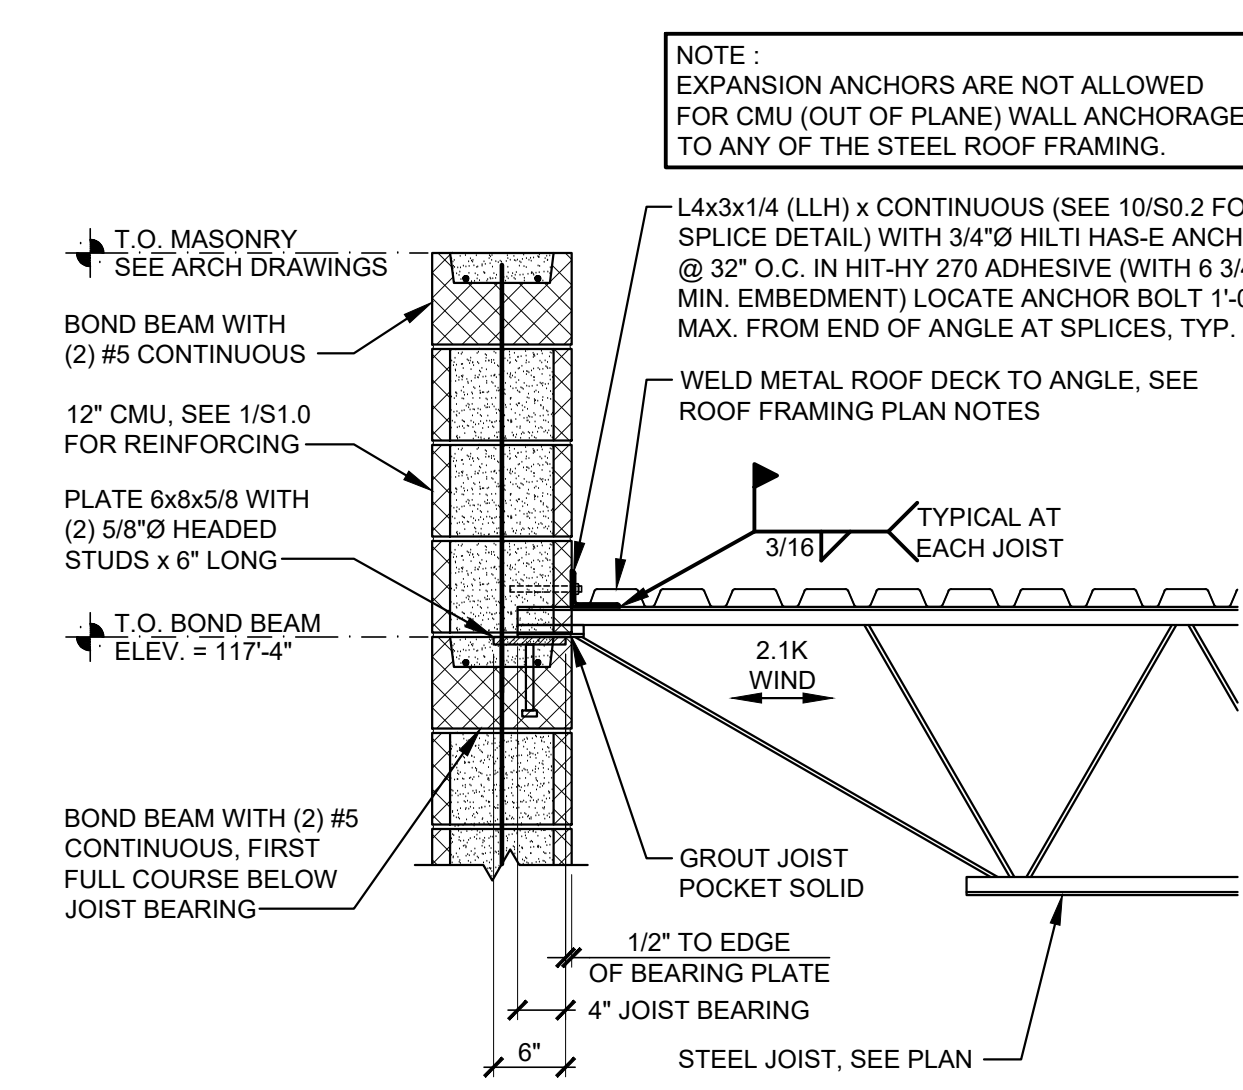


2 SECTION
SCALE: 3/4" = 1'-0"

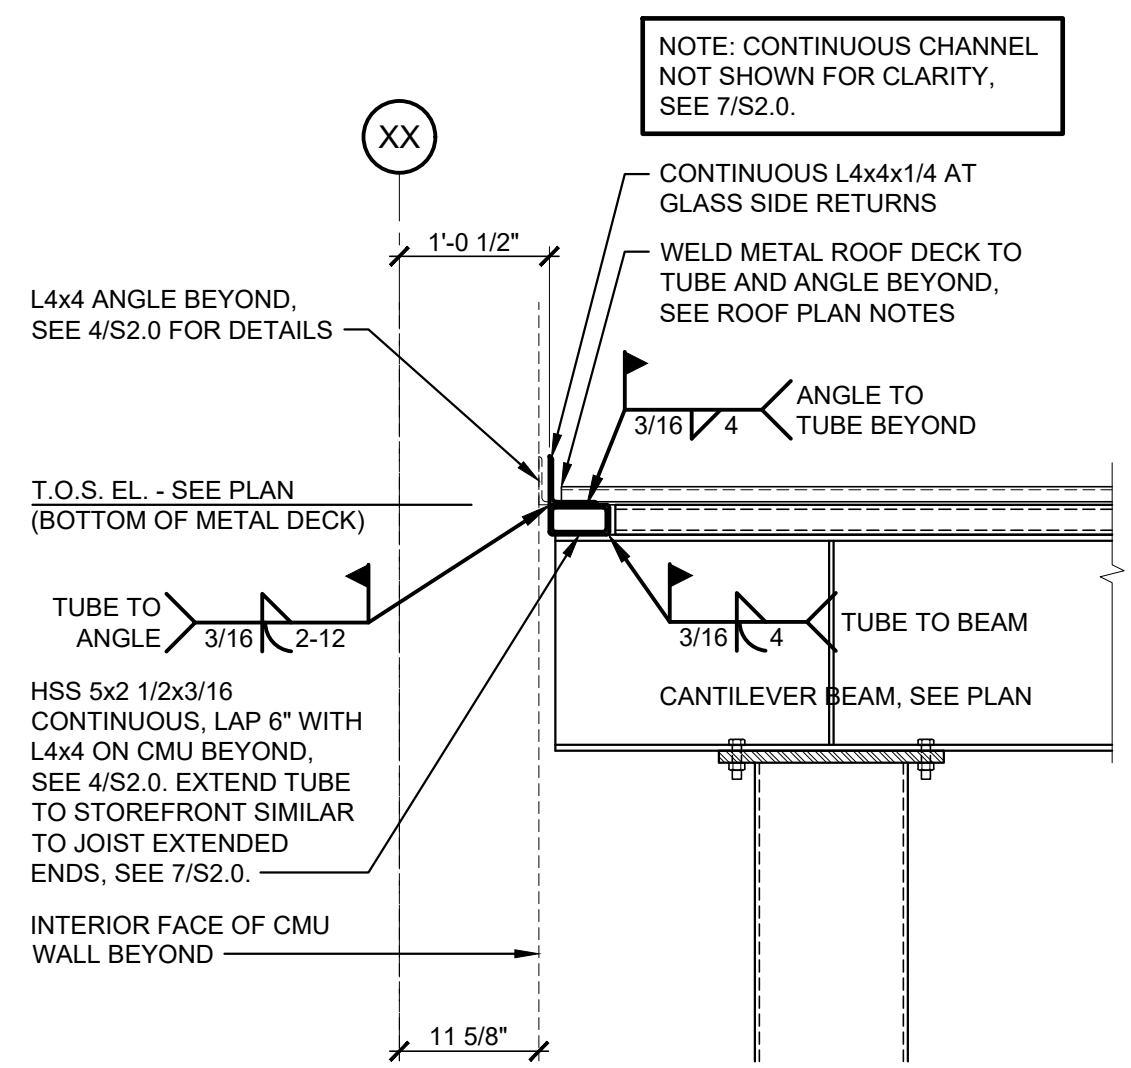


3 SECTION
SCALE: 3/4" = 1'-0"

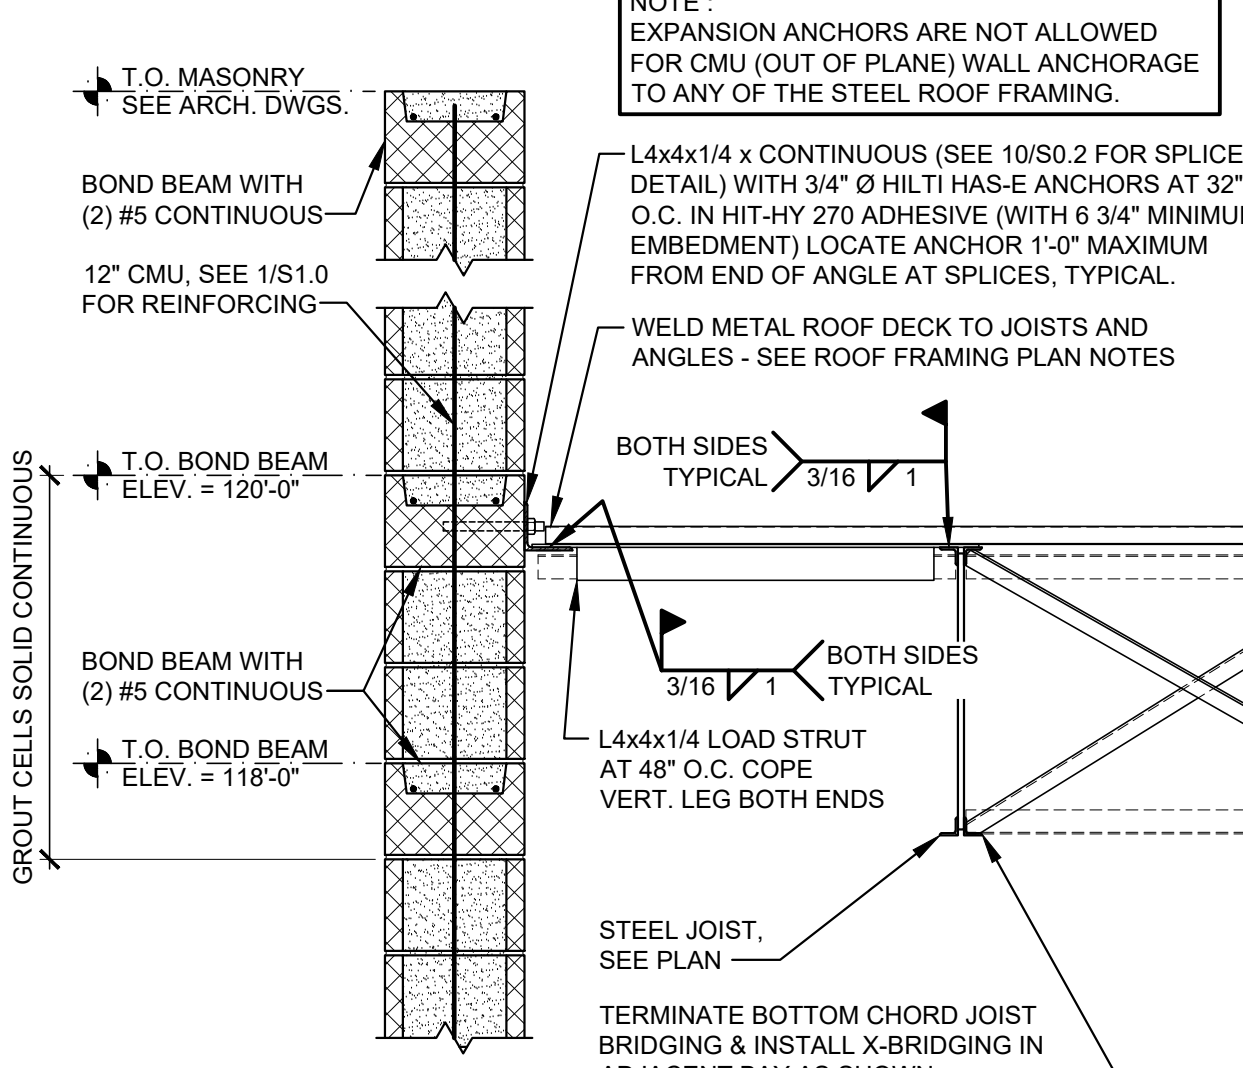


4 SECTION
SCALE: 3/4" = 1'-0"

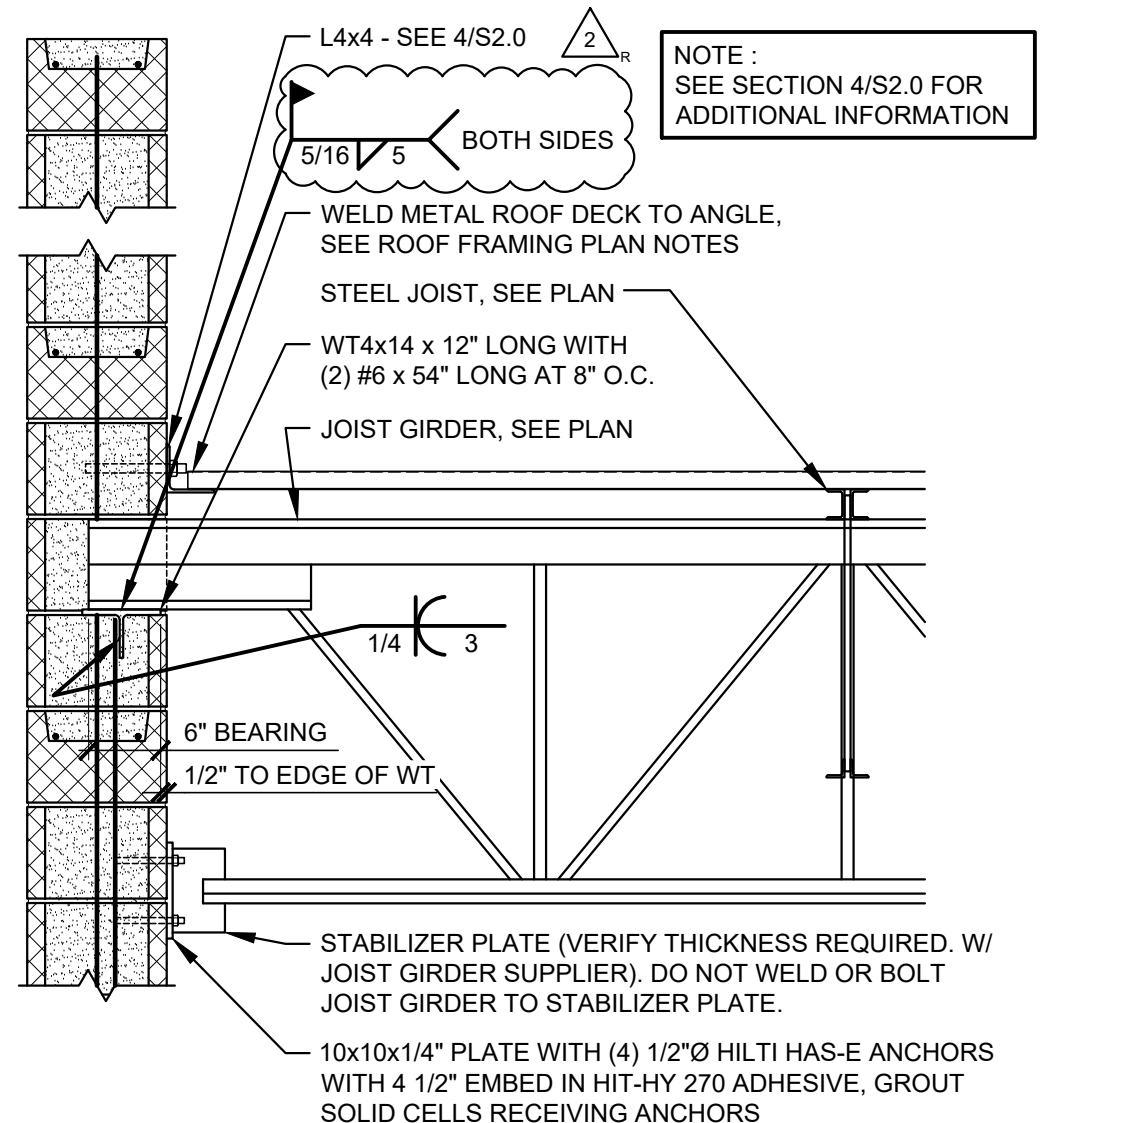


6 SECTION
SCALE: 3/4" = 1'-0"

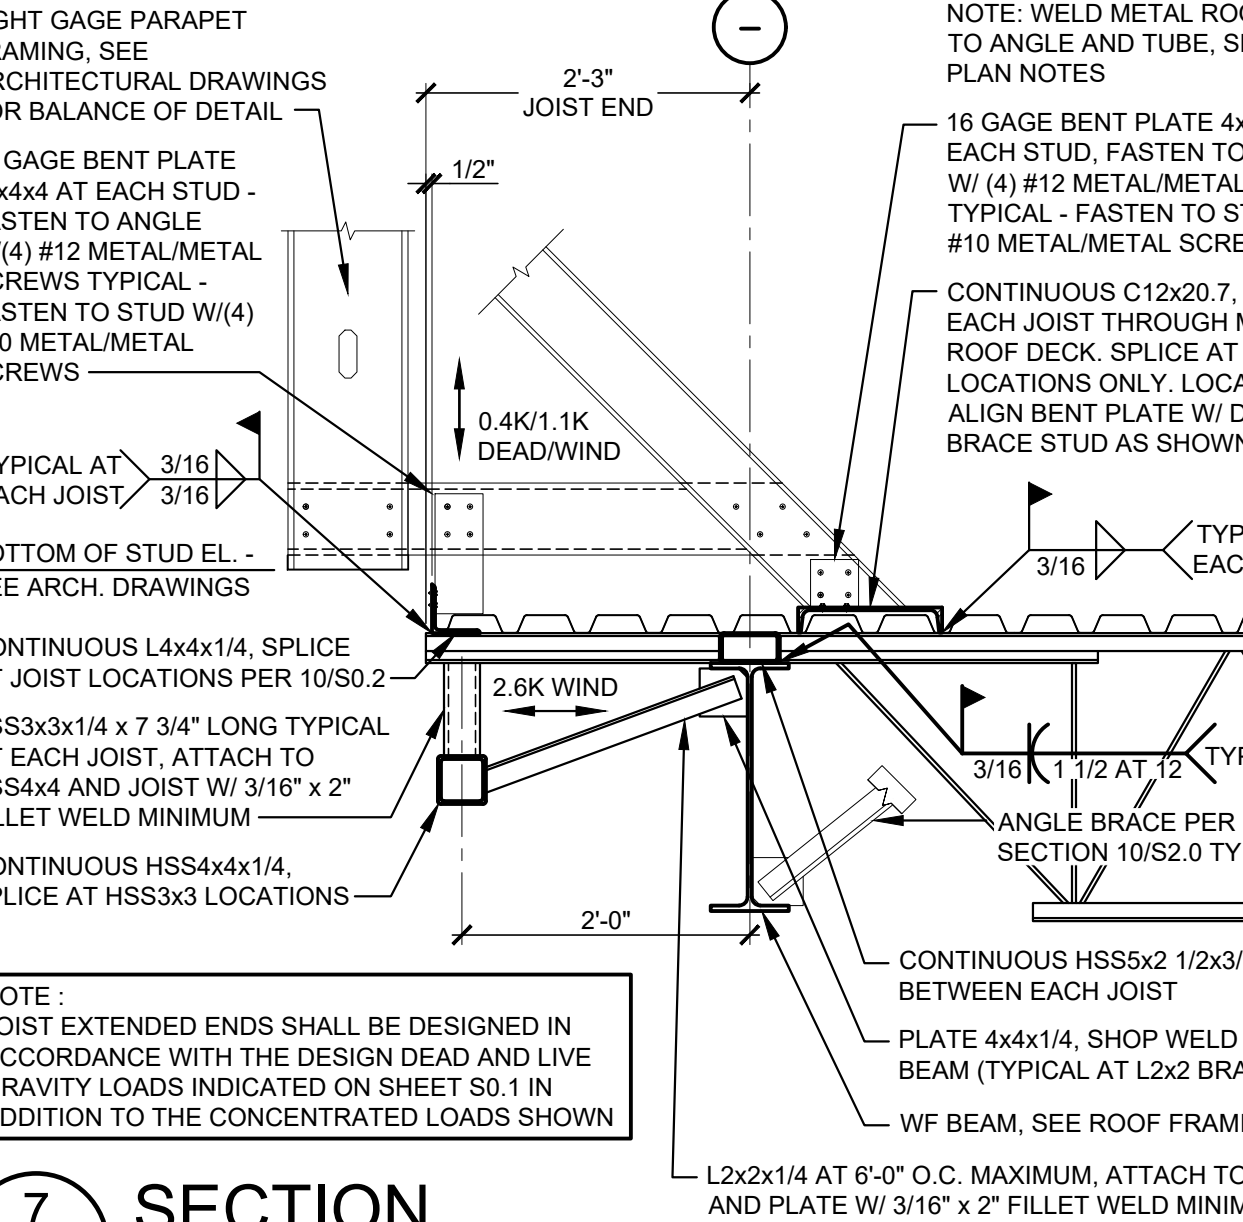


7 SECTION
SCALE: 3/4" = 1'-0"

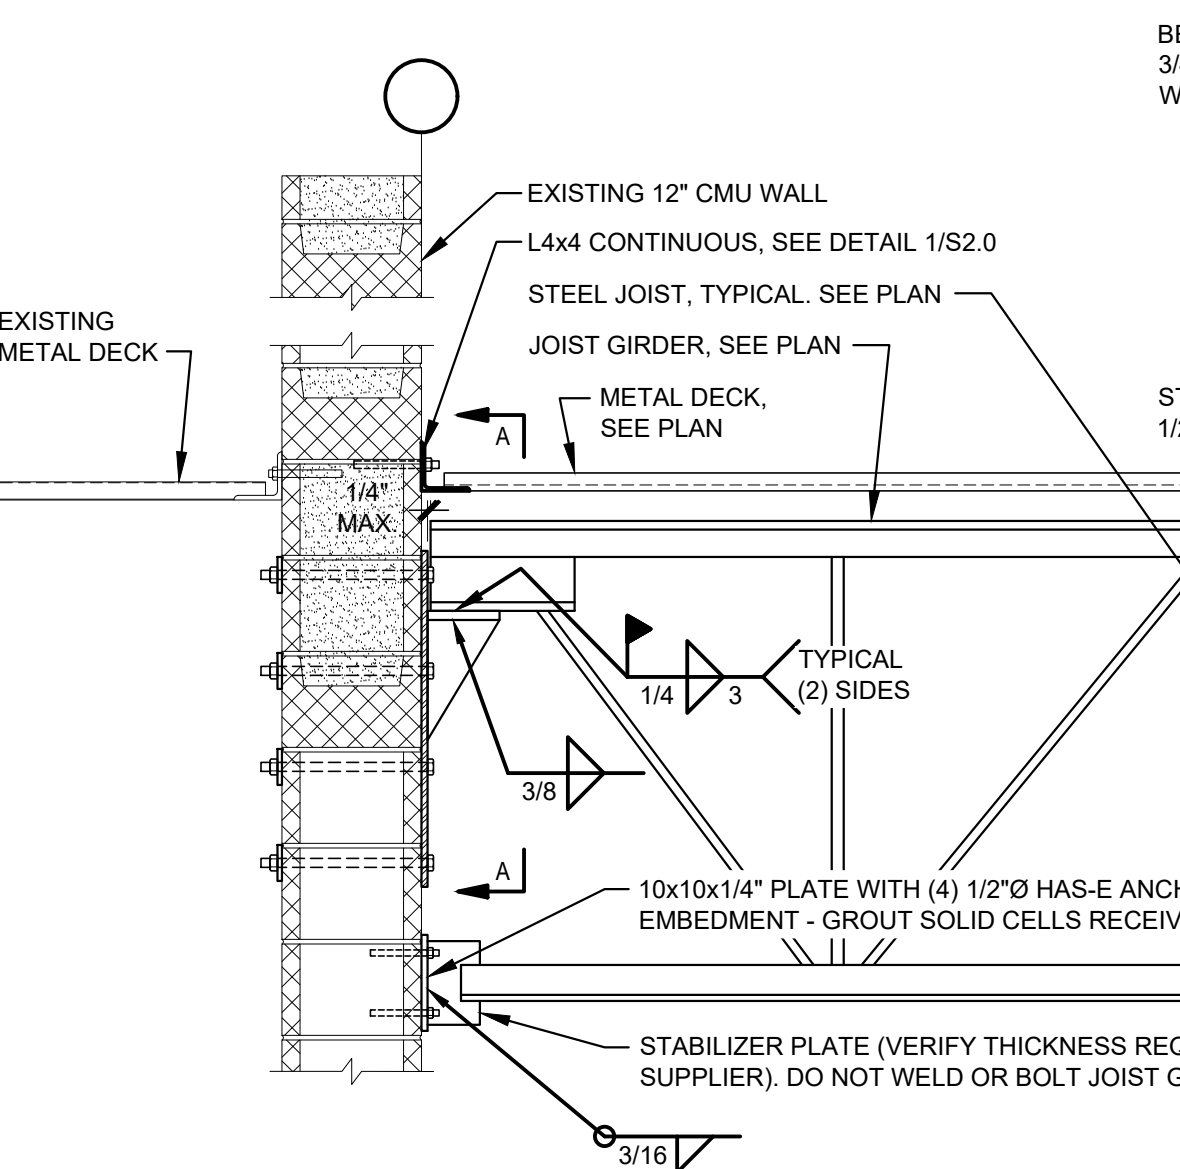

8 SECTION
SCALE: 3/4" = 1'-0"

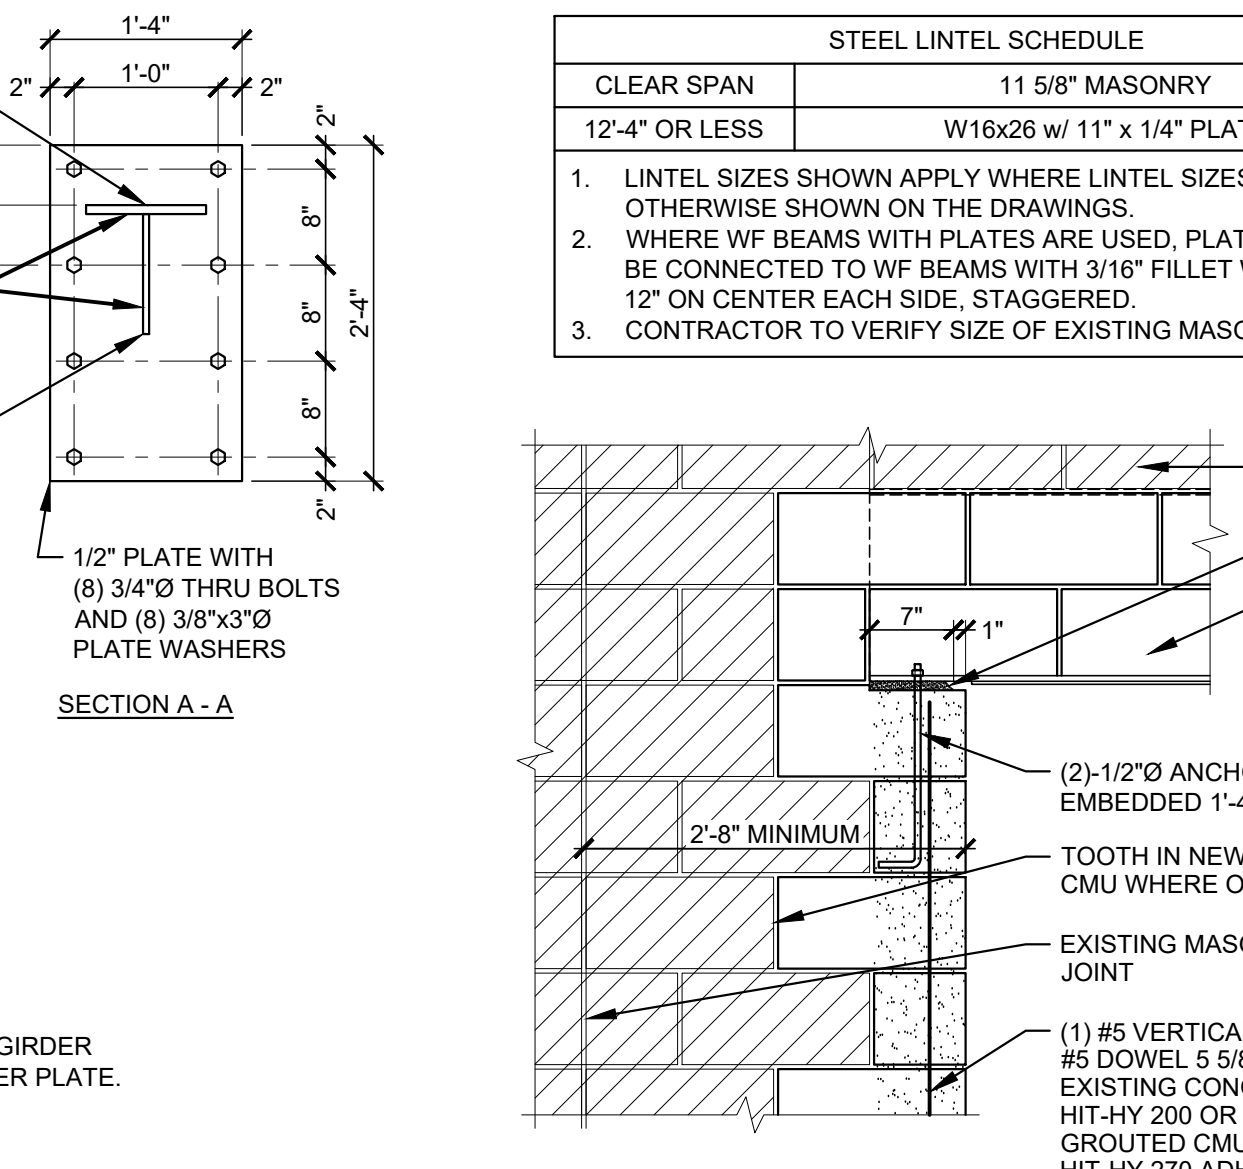

9 DETAIL
SCALE: 3/4" = 1'-0"

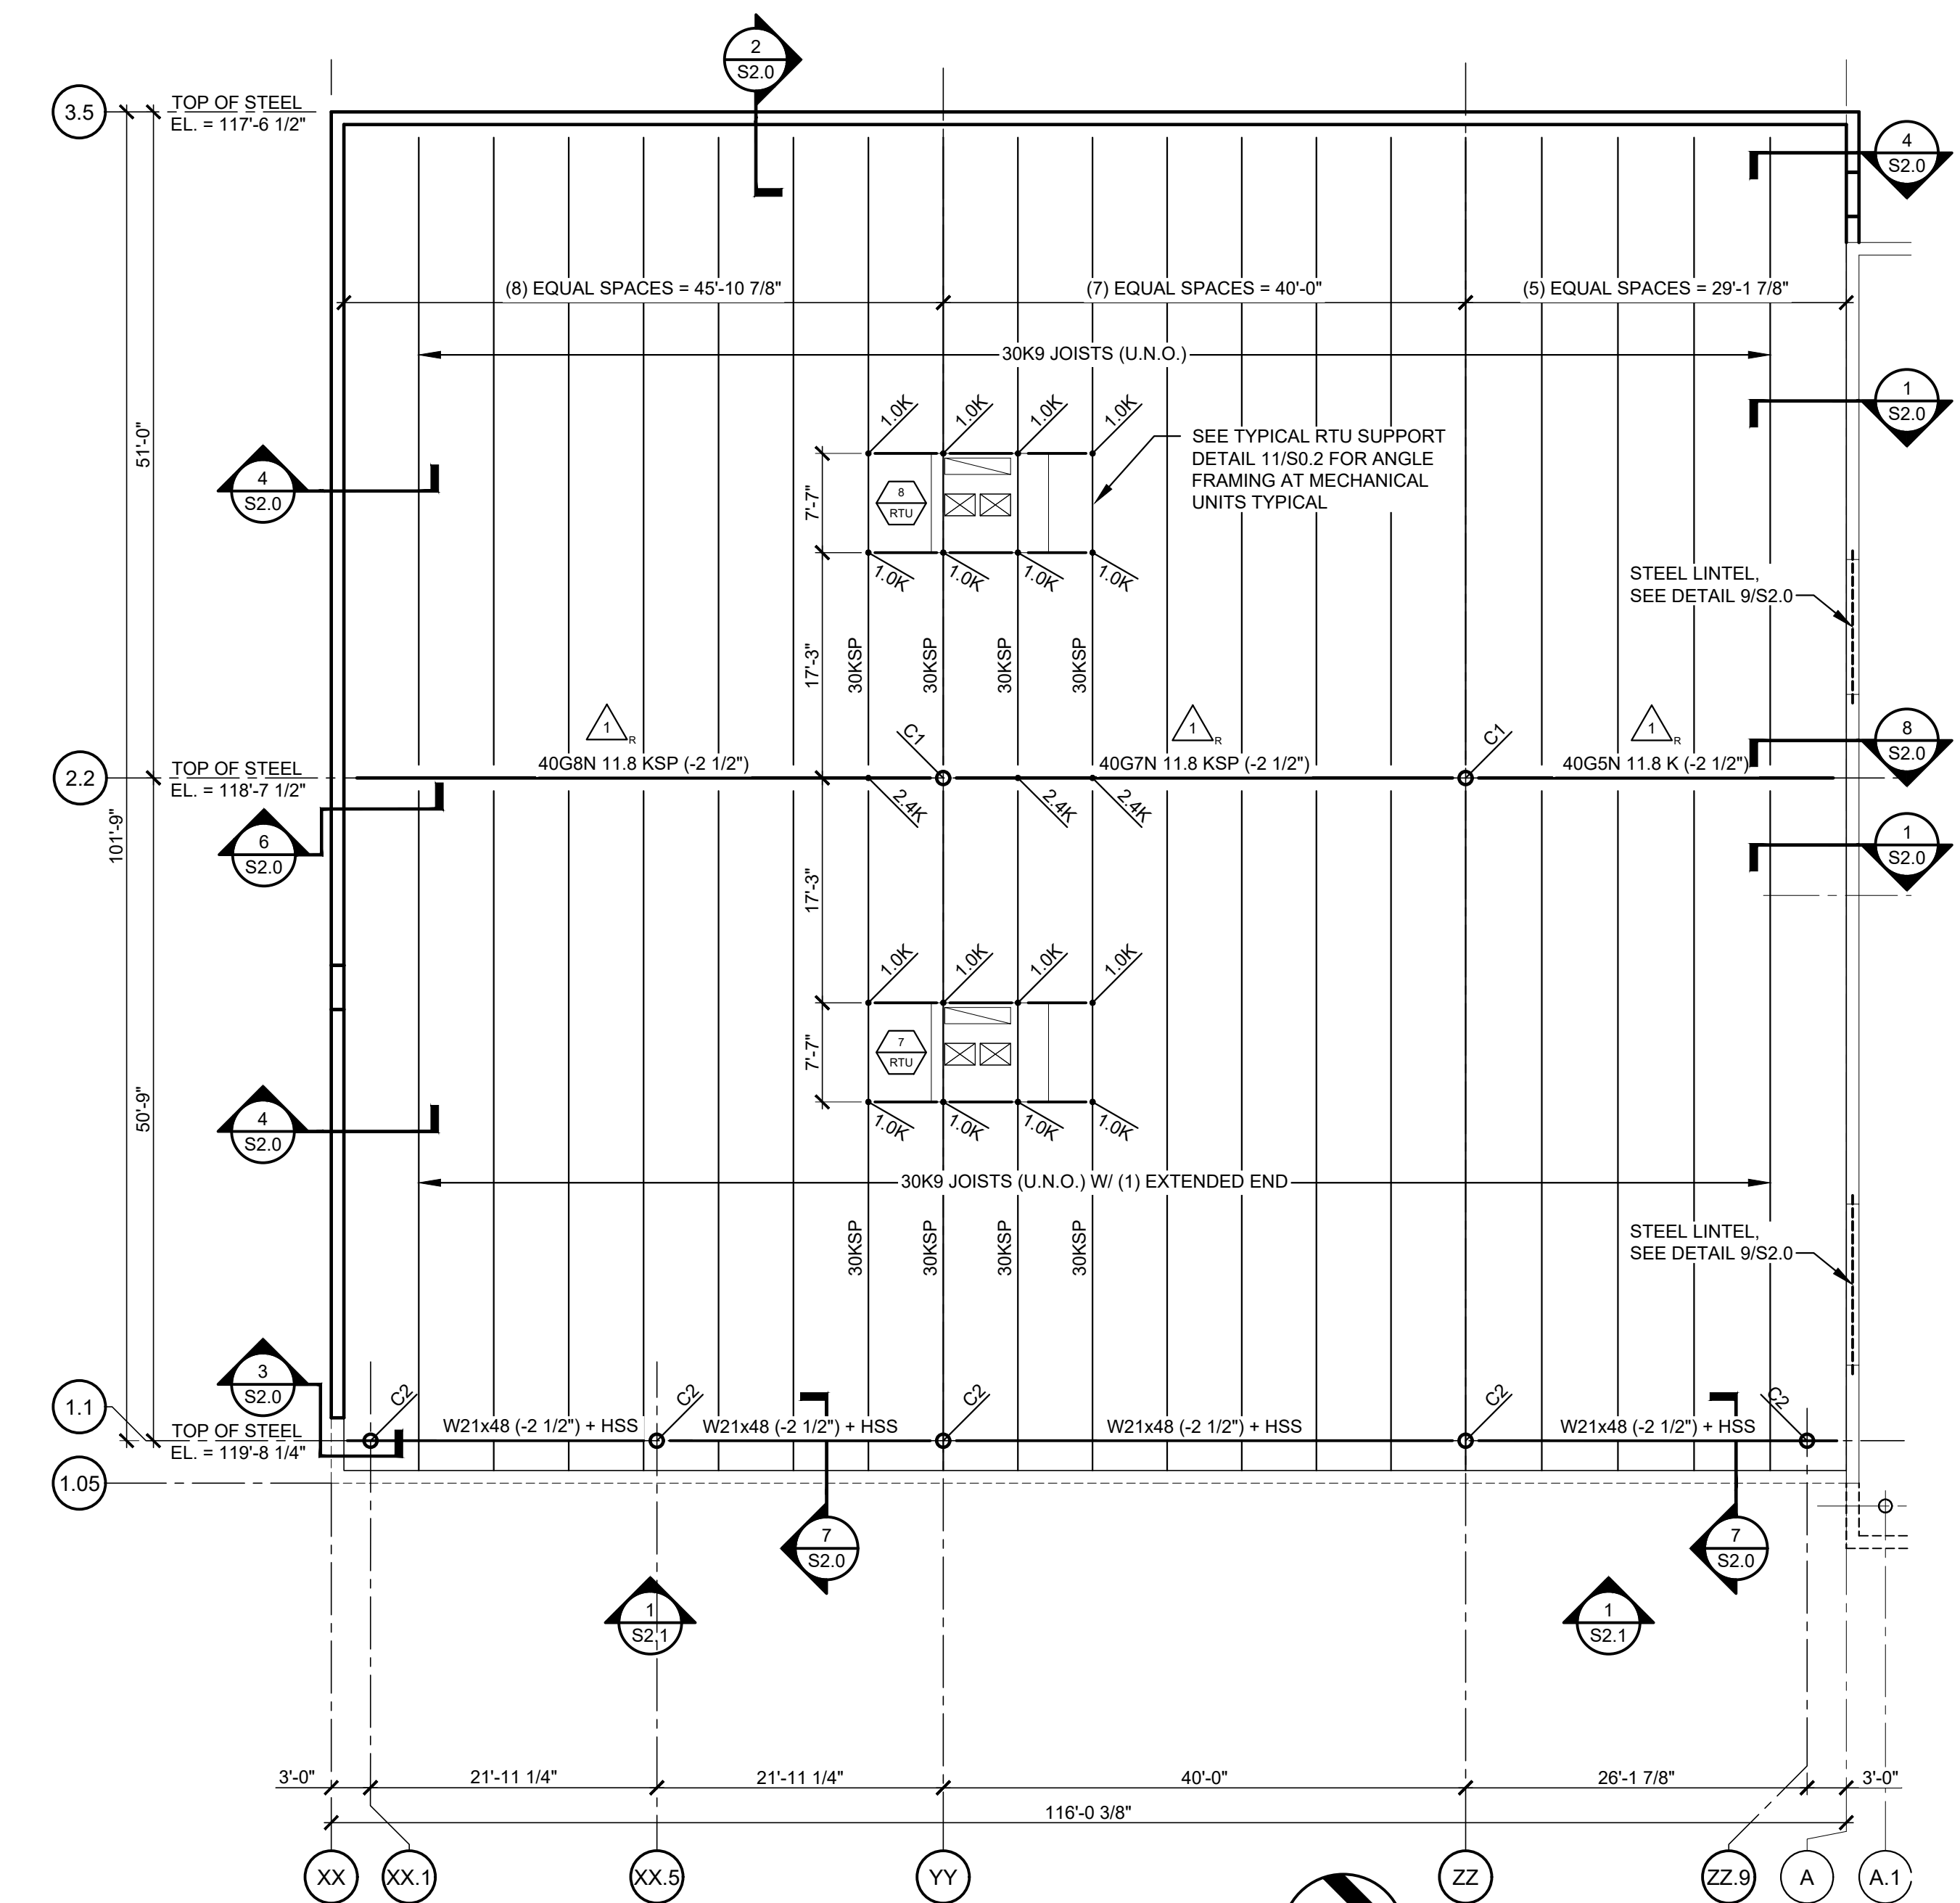


5 ROOF FRAMING PLAN
SCALE: 3/32" = 1'-0"

STEEL LINTEL SCHEDULE	
CLEAR SPAN	12" CMU
7'-4" OR LESS	(2) P58-8" (L2)

LINTEL NOTES:

- USE "POWERS" STEEL LINTEL MANUFACTURED BY "POWERS STEEL AND WIRE". INSTALL LINTEL PER MANUFACTURER'S WRITTEN RECOMMENDATIONS.
- LINTELS SHALL BE SHORED DURING CONSTRUCTION UNTIL THE MASONRY HAS ATTAINED SUFFICIENT STRENGTH TO CARRY ITS OWN WEIGHT.
- LINTEL SIZES SHOWN APPLY WHERE LINTEL SIZES ARE NOT OTHERWISE SHOWN ON THE DRAWINGS.
- SEE "TYPICAL LINTEL BEARING" DETAIL ON SHEET S0.2 FOR TYPICAL END BEARING.


COLUMN SCHEDULE			
MARK	COLUMN	BASE PLATE	ANCHOR RODS
C1	HSS 8.625x0.188 (A500 GRADE B)	15" x 15" x 1"	(4) 1" WITH 2" EDGE DISTANCE (16" EMBEDMENT)
C2	HSS 12.750x0.250 (A500 GRADE B)	18" x 18" x 3/4"	(4) 3/4" @ 12" EMBEDMENT

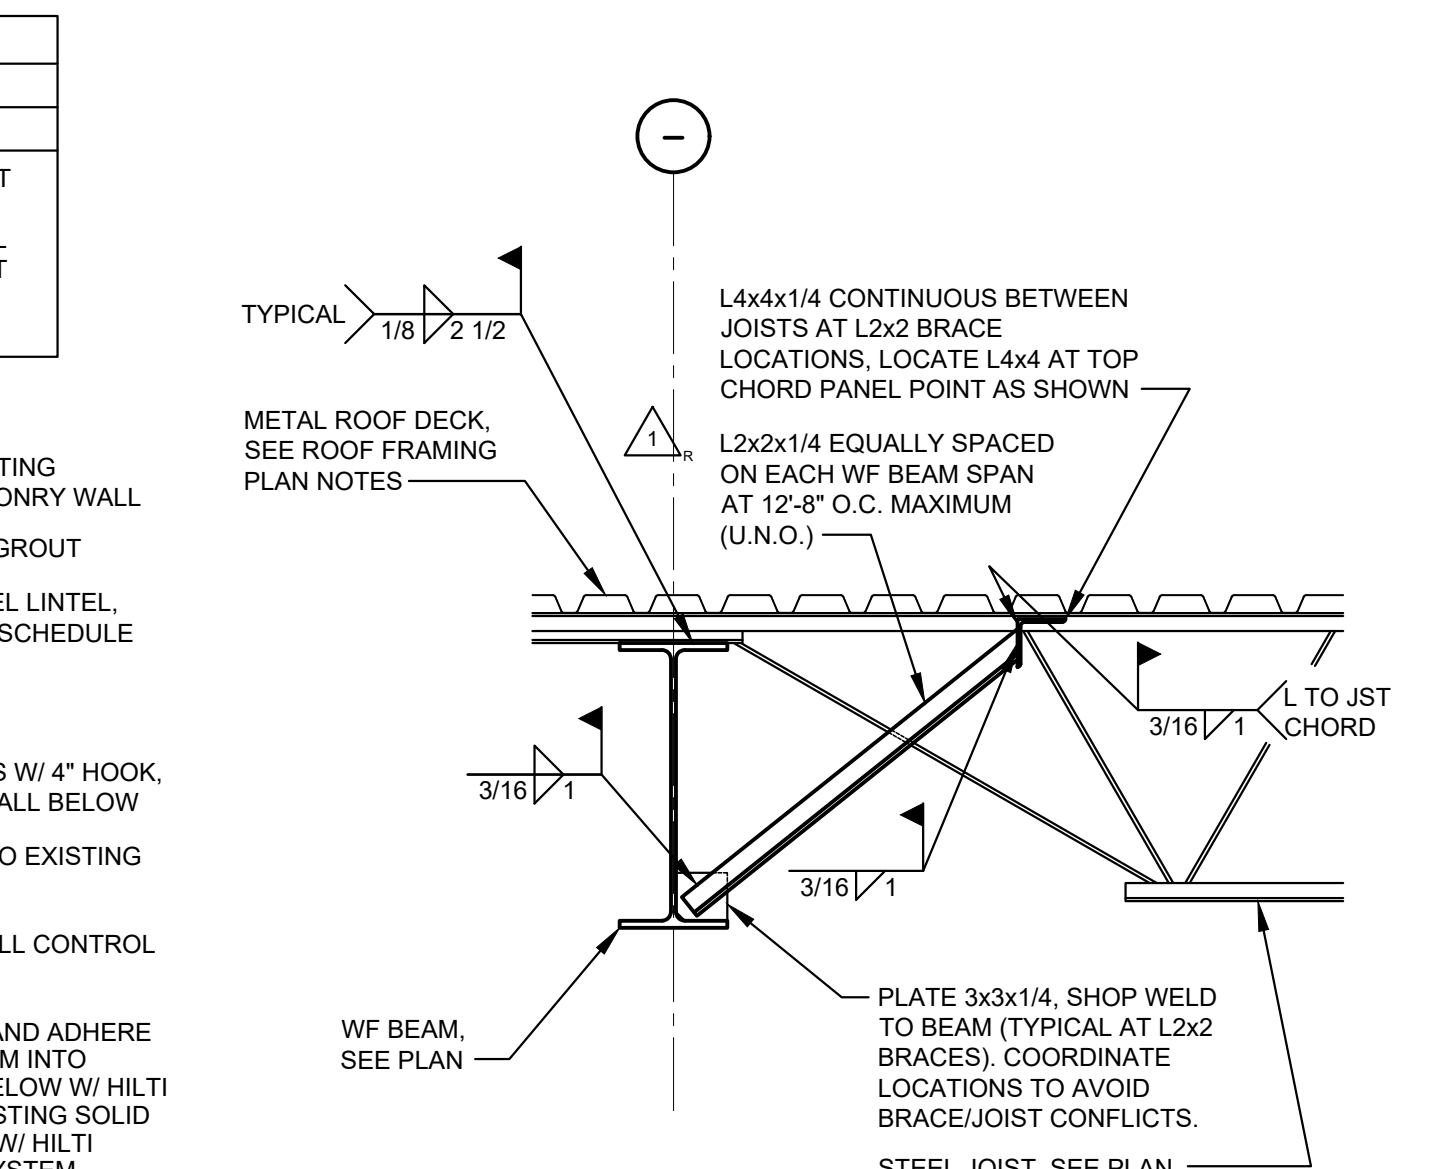




10 SECTION
SCALE: 3/4" = 1'-0"

ROOF FRAMING PLAN NOTES	
1.	SEE SHEET S0.1 FOR DESIGN ROOF LOADS AND GENERAL NOTES.
2.	TOP OF STEEL (T.O. STEEL) EQUALS TOP OF STEEL JOIST/UNDERSIDE OF METAL DECK. BEAMS AND JOIST GIRDERS REFERENCED ± FROM TOP OF STEEL.
3.	METAL ROOF DECK SHALL BE 22 GAGE, 36" WIDE, 1 1/2" DEEP, TYPE "B" WIDE RIB ROOF DECK AND SHALL BE CONNECTED TO FRAMING MEMBERS AS FOLLOWS (SEE SPECIFICATION FOR FINISH): A. TO ALL TRANSVERSE SUPPORTS, 5/8" PUDDLE WELDS, (7) PER SHEET. B. TO ALL SUPPORTS PARALLEL TO FLUTES, 5/8" PUDDLE WELDS AT 6" O.C. C. SIDE SEAMS, #10 BUILDUP SCREWS, (8) PER SPAN.
4.	STEEL JOISTS IDENTIFIED ON PLAN AS "SP" SHALL BE DESIGNED FOR THE TRIBUTARY UNIFORM LOAD AS SHOWN ON THE DRAWINGS IN ADDITION TO THE CONCENTRATED LOADS SHOWN ON PLAN IN ACCORDANCE WITH PARAGRAPH 5.5 OF THE RECOMMENDED CODE OF STANDARD PRACTICE FOR JOISTS AND JOIST GIRDERS. REFER TO THE SECTIONS/DETAILS CUT ON PLAN FOR ADDITIONAL JOIST DESIGN LOADS. JOIST GIRDERS IDENTIFIED ON PLAN AS "SG" SHALL BE DESIGNED FOR THE LOAD IMPOSED BY ALL TRIBUTARY CONCENTRATED LOADS AND TOP CHORD AXIAL LOADS SHOWN ON PLAN IN ADDITION TO THE INDICATED PANEL POINT LOADS.
5.	ALL ITEMS SUCH AS MECHANICAL EQUIPMENT, DUCT WORK, PIPES, CEILINGS, FIXTURES, ETC. THAT ARE TO BE SUPPORTED OR HUNG FROM THE STEEL JOISTS SHALL BE FRAMED WITH AUXILIARY FRAMING TO THE PANEL POINTS OF THE JOIST (SEE TYPICAL JOIST LOAD STRUT DETAIL SHEET S0.2). METHODS OF FRAMING THAT INDUCE BENDING TO THE JOIST CHORD OR WEB MEMBERS WILL NOT BE PERMITTED. COORDINATE BRIDGING LOCATION SO AS NOT TO INTERFERE WITH ANY MECHANICAL EQUIPMENT.
6.	STEEL JOIST AND JOIST GIRDER CAMBER SHALL BE PROVIDED IN ACCORDANCE WITH THE SJ SPECIFICATIONS.
7.	APPROXIMATE CORNER WEIGHTS OF ROOF TOP EQUIPMENT ARE SHOWN ON PLAN. VERIFY ALL LOADS, LOCATIONS, CURB SIZES AND OPENING SIZES WITH MECHANICAL CONTRACTOR PRIOR TO FABRICATION. SEE TYPICAL RTU SUPPORT DETAIL ON SHEET S1 FOR FRAMING.
8.	SEE ARCHITECTURAL PLANS FOR INTERIOR DECORATIVE TRUSS SUPPORTS.


Date	CONSTR. DOC. & REVISIONS
08/21/23	
11/29/23	

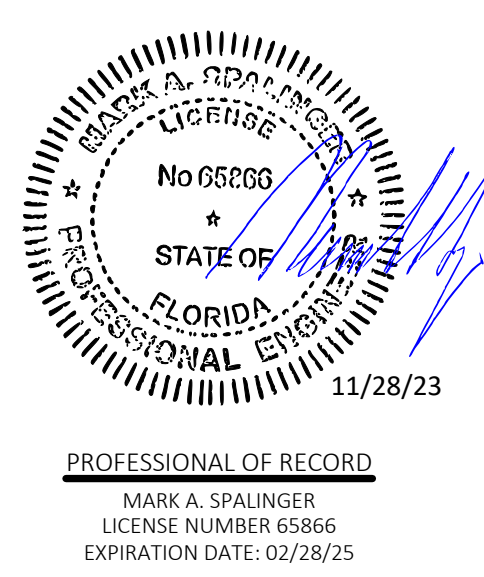


Drawn By/Checked By:	MPD/MPD
Project Number	2101445
Bid Date	11/09/23
Permit	03/28/23
Owner Date	07/06/22

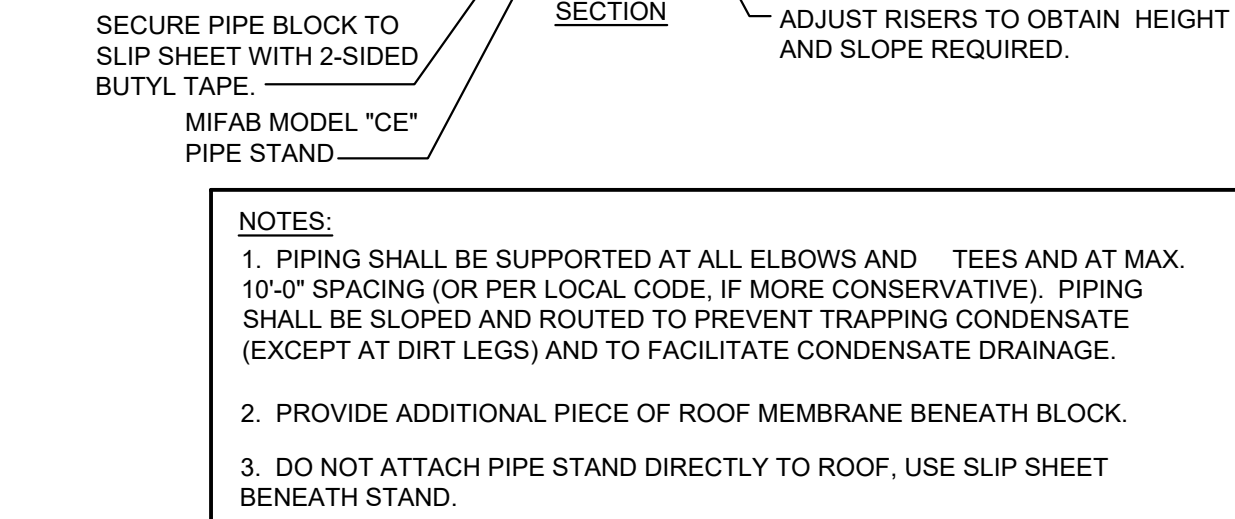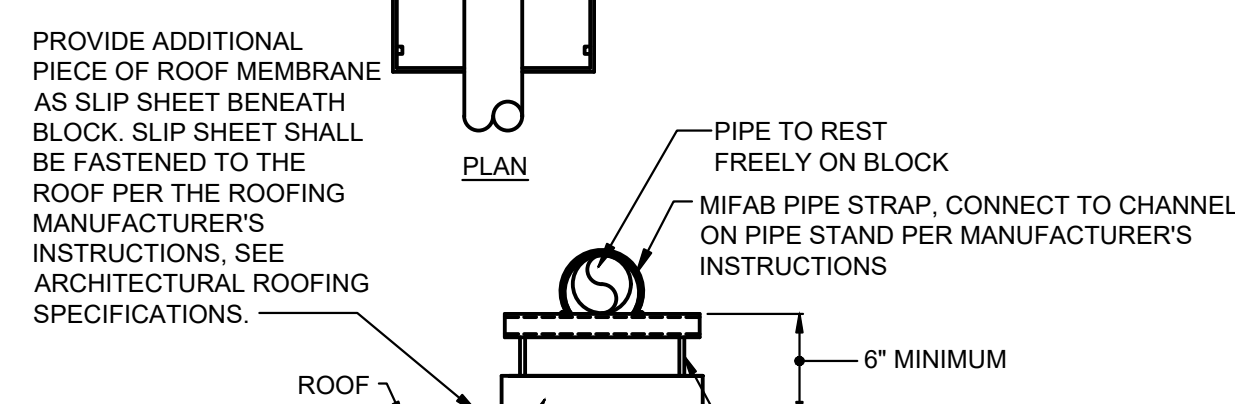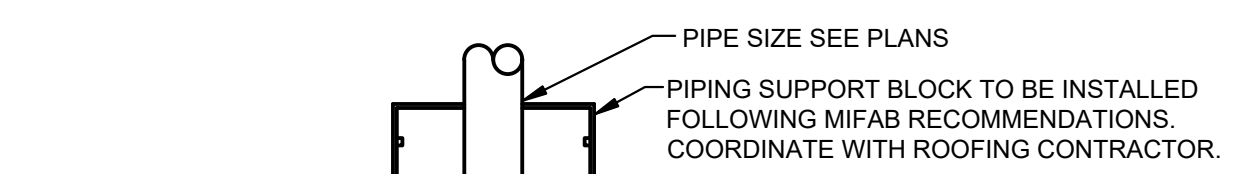

5 ROOF PIPING SUPPORT DETAIL
SCALE: NOT TO SCALE

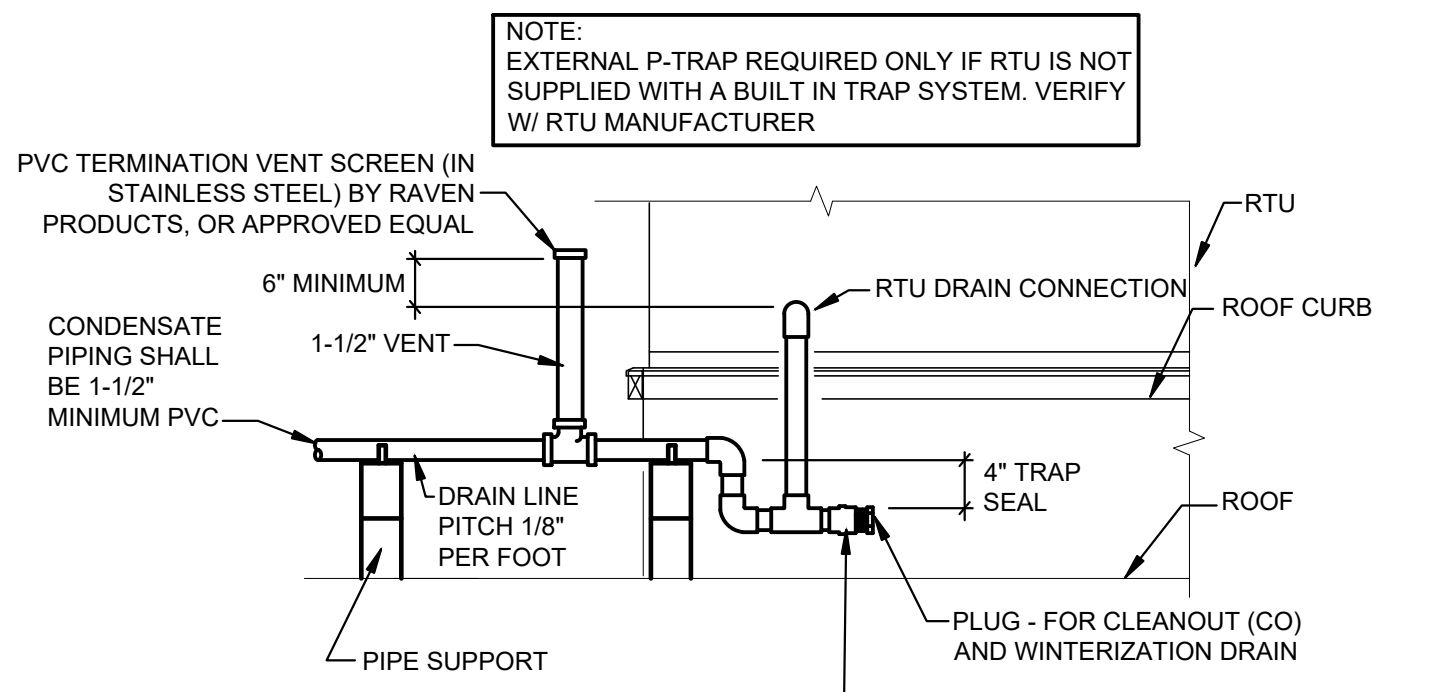

6 CONDENSATE DRAIN PIPING DETAIL
SCALE: NOT TO SCALE

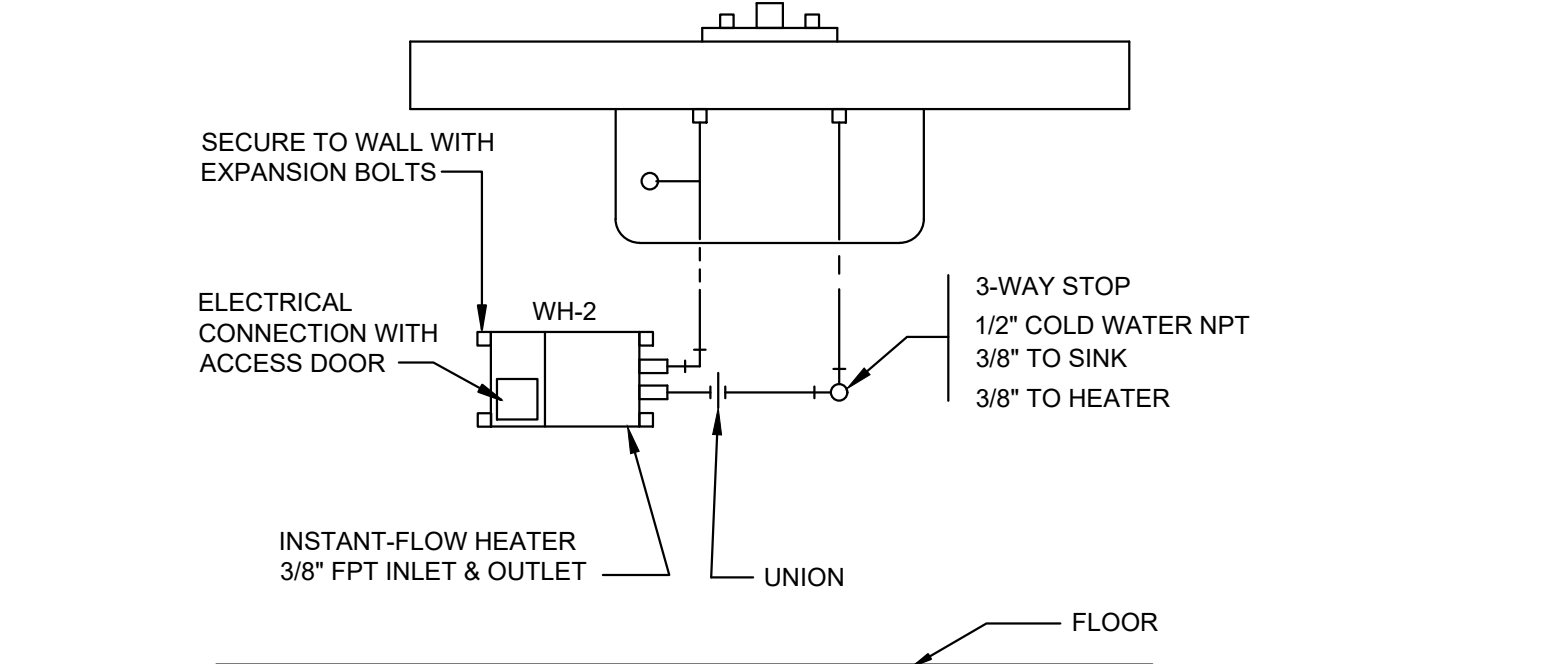


7 INSTANT FLOW WH-2 BELOW SINK DETAIL
SCALE: NOT TO SCALE


MARK	SPECIFICATIONS
LAV-1	LAVATORY: (ADA) KOHLER #K-2214 (LADENA) 21"x14" VITREOUS CHINA, UNDER-COUNTER MOUNTED, FAUCET: AMERICAN STANDARD 'TIMES SQUARE' #7184.101.002, 1.2GPM PRESSURE, CONTRACTOR TO PROVIDE, CHROME PLATED BRASS P-TRAP, ANGLE STOPS, AND FLEX SUPPLIES. INSULATE ALL EXPOSED PIPING BELOW LAVATORY WITH TRUEBRO #102 INSULATION KIT. SINK IS SUPPLIED WITH UNDER-COUNTER MOUNTING KIT (119849), USE OF EPOXY IS NOT ALLOWED. INST. SINK PER MANUFACTURER'S RECOMMENDATIONS AND INSTALLATION MANUAL.
LAV-2	LAVATORY: (ADA) AMERICAN STANDARD #0134001EC 21"x20" WALL HUNG, FAUCET: AMERICAN STANDARD 'TIMES SQUARE' #7184.101.002, 1.2GPM PRESSURE, AND J.R. SMITH #0801 FLOOR MOUNT WALL CARRIER WITH CONCEALED ARMS. PROVIDE CHROME PLATED ANGLE STOP, ESCUTCHEON, 1/2" FLEX SUPPLIES & P-TRAP. INSULATE ALL EXPOSED PIPING BELOW LAVATORY WITH TRUEBRO #102 INSULATION KIT.
WC-1	WATERCLOSET (ADA): AMERICAN STANDARD #3351.101, WALL HUNG, VITREOUS CHINA, ELONGATED SIPHON JET, FLUSH VALVE: SLOAN #111-1.28 (LOW CONSUMPTION 1.28 GALLON PER FLUSH - 'WATERSENSE' LISTED) SEAT: CHURCH & DWIGHT #225SSC50 WITH OPEN FRONT, CARRIER: J.R. SMITH #0542F (FLOOR MOUNTED) CARRIER MUST BE COMPACT TYPE.
EW-1	ELECTRIC WATER COOLER: (ADA) OASIS # PBACSL, 115/60V1 STANDARD FINISH, SPLIT LEVEL WITH SINGLE WASTE AND ELECTRICAL CONNECTION. PROVIDE APRON ACCESSORY FOR UPPER UNIT J.R. SMITH #0800 FLOOR MOUNT WALL CARRIER WITH CONCEALED ARMS.
WH-2	ELECTRIC INSTANT WATER HEATER - EEMAX SPEX3208: POINT OF USE WATER HEATER MOUNTS IN ANY ORIENTATION, 208V, 3 KW, 41" TEMPERATURE RISE AT 0.5GPM, SET HEATER TO 110°F MAXIMUM TEMPERATURE. INSTALL PER MANUFACTURER'S INSTRUCTIONS WITH 0.5GPM AERATOR.
SINK-1	SINGLE COMPARTMENT SINK: ELKAY LRA1918, 19"x 18"x 1/2" DEEP, 18 GAUGE TYPE 302 SELF RIMMING SINK WITH LK2445BH FAUCET AND LK99 DRAIN, 18 GAUGE P-TRAP, STOPS AND SUPPLIES. IN-SINK-ERATOR BADGER 5 MODEL 1/2 HP, 120 VOLTS AND 1725 RPM. PROVIDE FOOD WASTE DISPOSER WITH DISHWASHER DRAIN CONNECTION.
P-1	LIBERTY PUMPS MODEL #405A DRAIN PUMP WITH ALARM. UNIT SHALL PRODUCE 27 GPM AT 21 FEET OF TOTAL DYNAMIC HEAD, 1/2 HP, 115V, 7.3 FLA. PUMP SHALL BE CONTROLLED WITH ON/OFF FACTORY INSTALLED FLOAT SWITCH. INSTALL PER MANUFACTURER'S INSTRUCTIONS. PROVIDE RUBBER MAT UNDER THE UNIT TO REDUCE NOISE.

PLUMBING FIXTURES DESIGNATED AS 'ADA' ARE TO BE FULLY ACCESSIBLE IN ACCORDANCE WITH THE 'AMERICAN DISABILITIES ACT OF 1990'. FIXTURES AND THEIR INSTALLATION SHALL ALSO COMPLY WITH 'AMERICAN NATIONAL STANDARDS INSTITUTE' (ANSI) PUBLICATION A117.1-PROVIDING ACCESSIBILITY AND USABILITY FOR PHYSICALLY HANDICAPPED PEOPLE' AND/OR GOVERNING CODES.

ALL PLUMBING FIXTURES, EQUIPMENT, TRIM AND FITTINGS SHALL COMPLY WITH LOCAL, STATE AND FEDERAL REGULATIONS AND/OR CODES, INCLUDING BUT NOT LIMITED TO, WATER AND ENERGY CONSERVATION CODES. THE SCHEDULED AND/OR SPECIFIED PLUMBING FIXTURES AND EQUIPMENT REPRESENT THE MINIMUM CRITERIA AND SHALL BE THE BASIS FOR THE CONTRACTOR'S BASE BID. IF THE SCHEDULED OR SPECIFIED FIXTURES AND/OR EQUIPMENT DO NOT COMPLY WITH GOVERNING CODES, THE CONTRACTOR SHALL PROVIDE AN ALTERNATE BID FOR COMPLYING EQUIPMENT. TRIM AND/OR FITTINGS. THE ABSENCE OF AN ALTERNATE BID SHALL BE CONSTRUED TO MEAN THE CONTRACTOR'S BID INCLUDES ALL COSTS NECESSARY TO MEET ALL REGULATIONS AND/OR CODES.

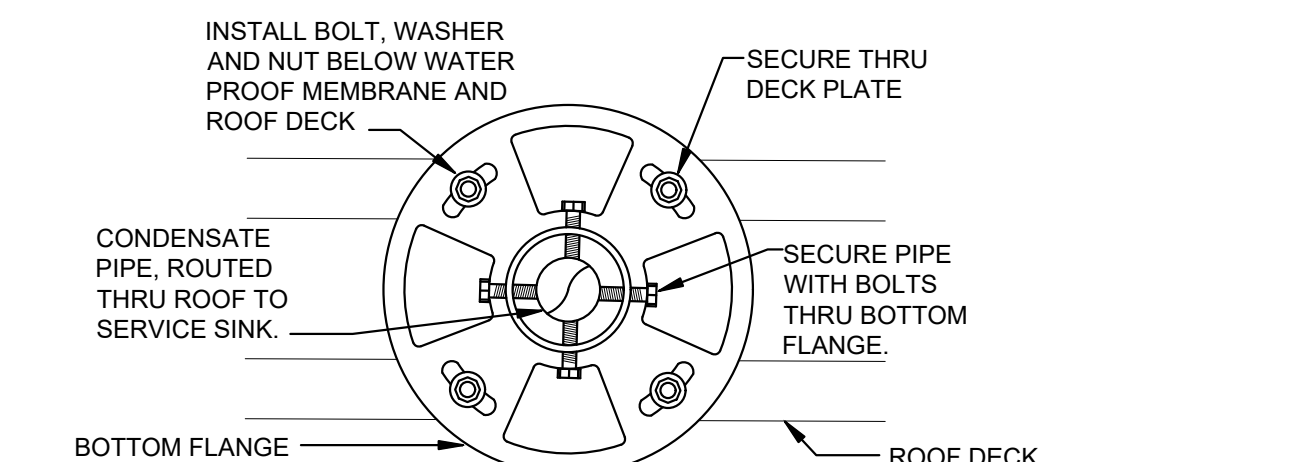


8 VERTICAL PIPE THRU ROOF SUPPORT DETAIL
SCALE: NOT TO SCALE

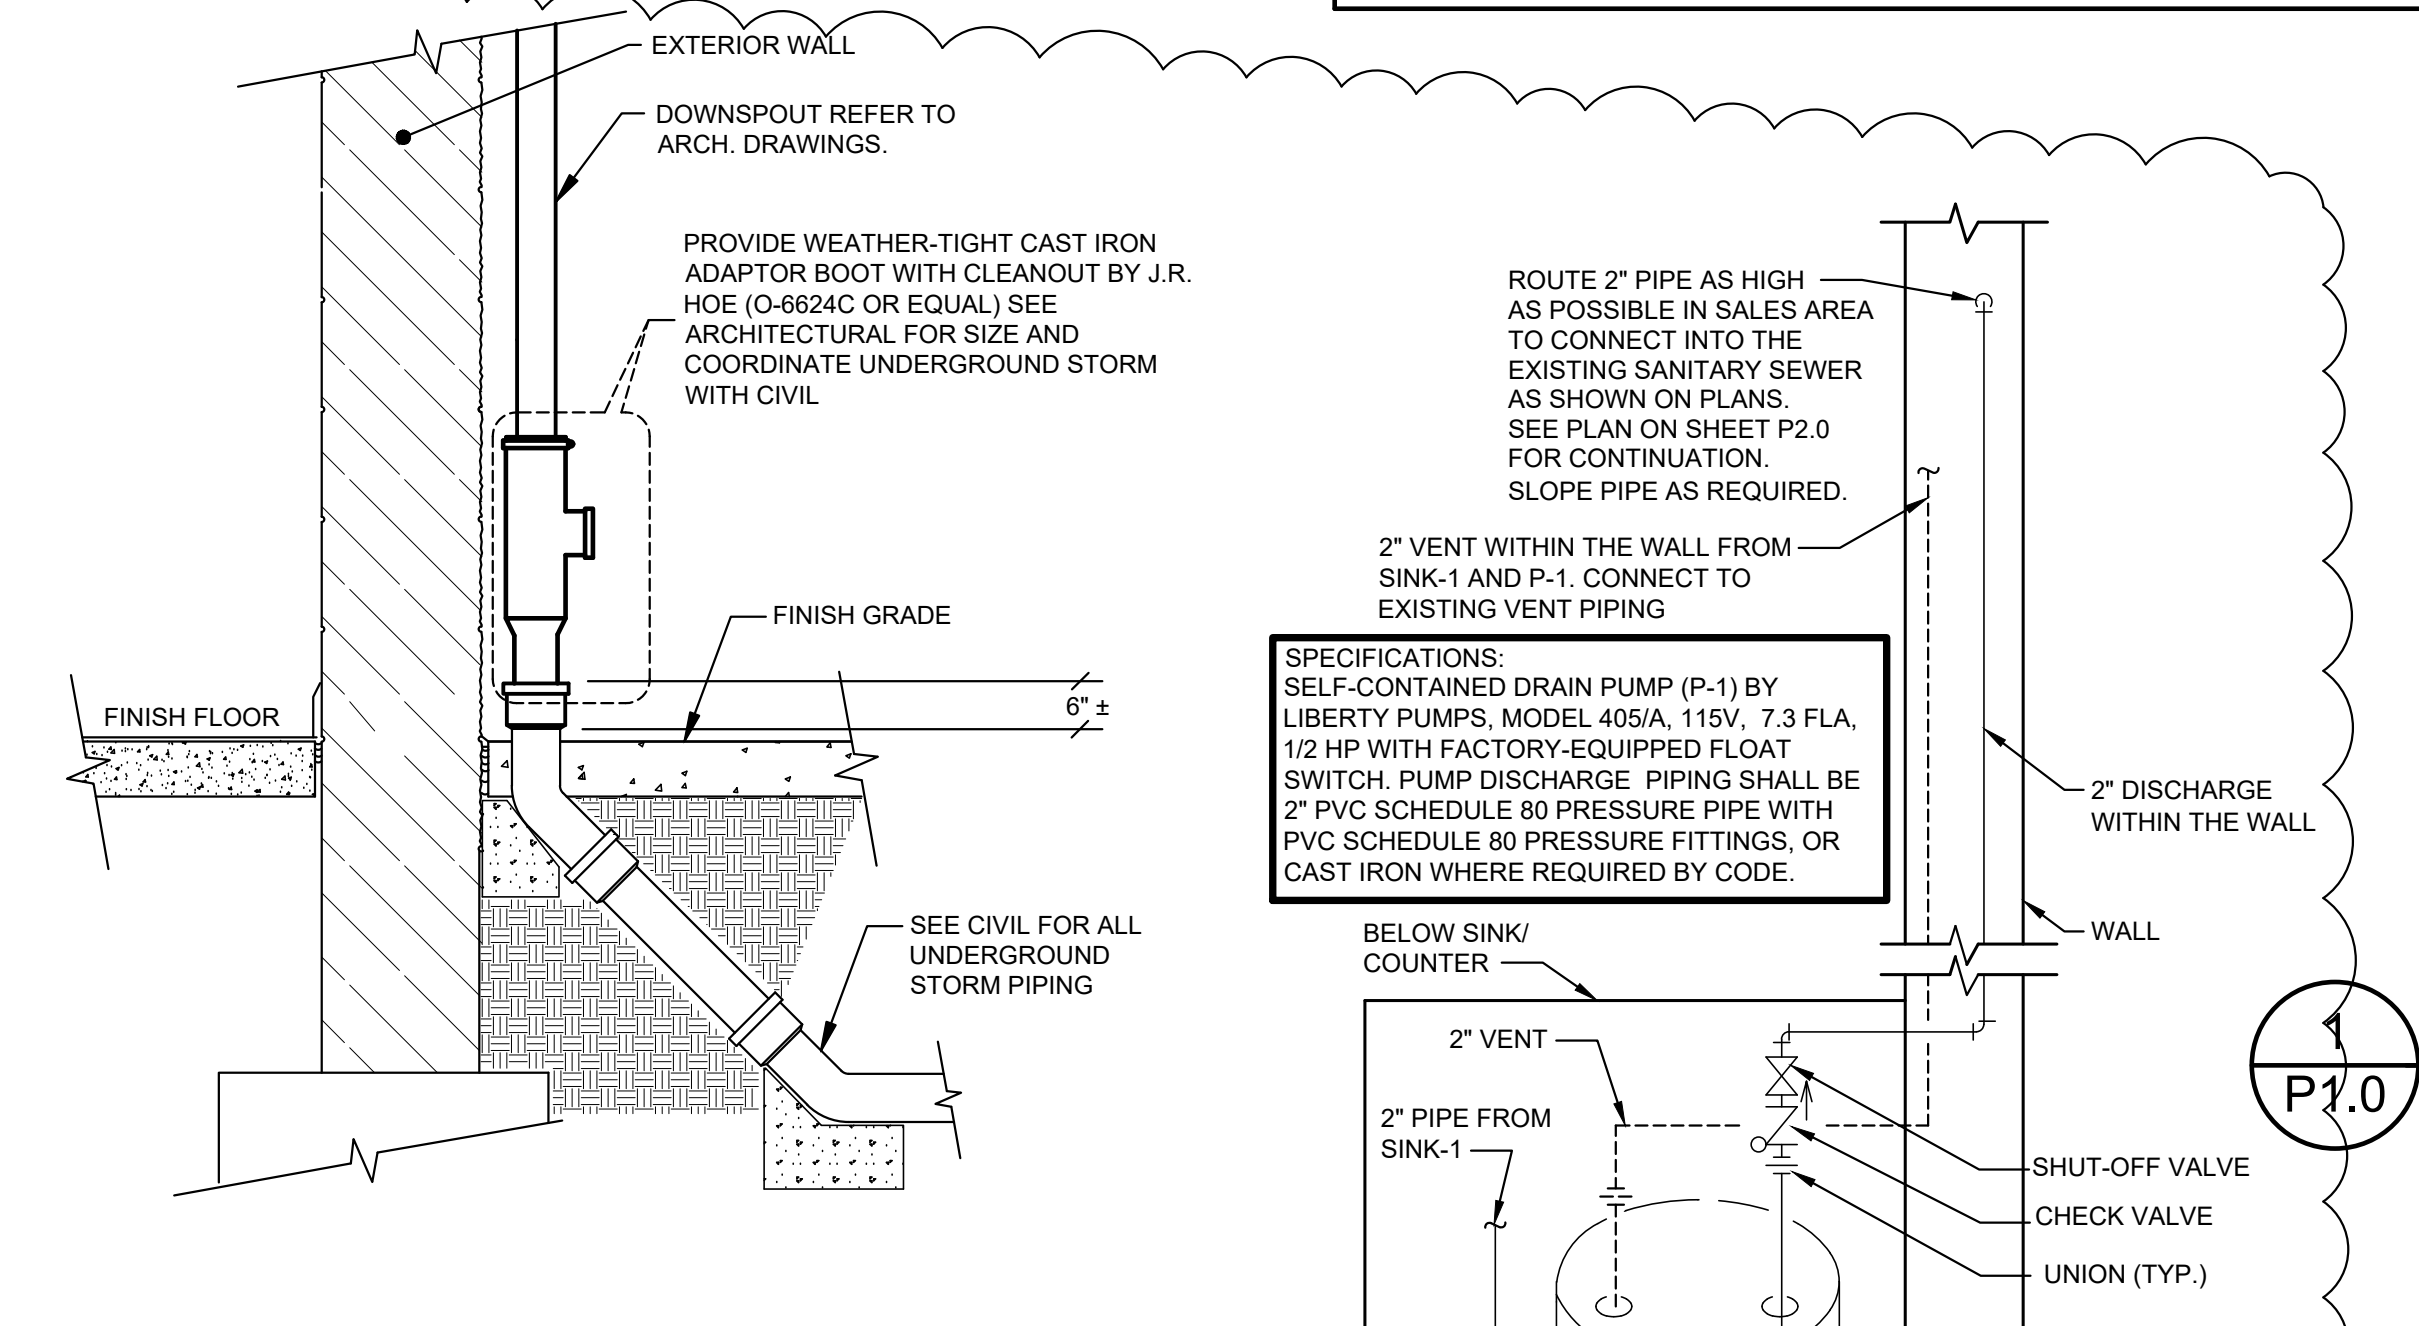


9 DOWNSPOUT DETAIL
SCALE: NOT TO SCALE

PLUMBING DEMOLITION KEYED NOTES


- DISCONNECT AND REMOVE EXISTING PLUMBING FIXTURES INDICATED BY HATCHING. FIELD VERIFY EXISTING LOCATIONS AND ELEVATIONS. PREPARE FOR RECONNECTION TO NEW PLUMBING FIXTURES. SEE ENLARGED PLANS ON THIS SHEET AND ARCHITECTURAL SHEET D1.0 FOR MORE INFORMATION.
- EXISTING PLUMBING FIXTURE TO REMAIN.
- TEMPORARILY REMOVE EXISTING WATER CLOSETS AND URINALS AS REQUIRED TO INSTALL NEW FLOOR AND WALL FINISHES. FIELD VERIFY EXISTING LOCATIONS AND ELEVATIONS. PREPARE FOR RECONNECTION TO EXISTING PLUMBING FIXTURES. SEE ENLARGED PLANS ON THIS SHEET AND ARCHITECTURAL SHEET D1.0 FOR MORE INFORMATION.

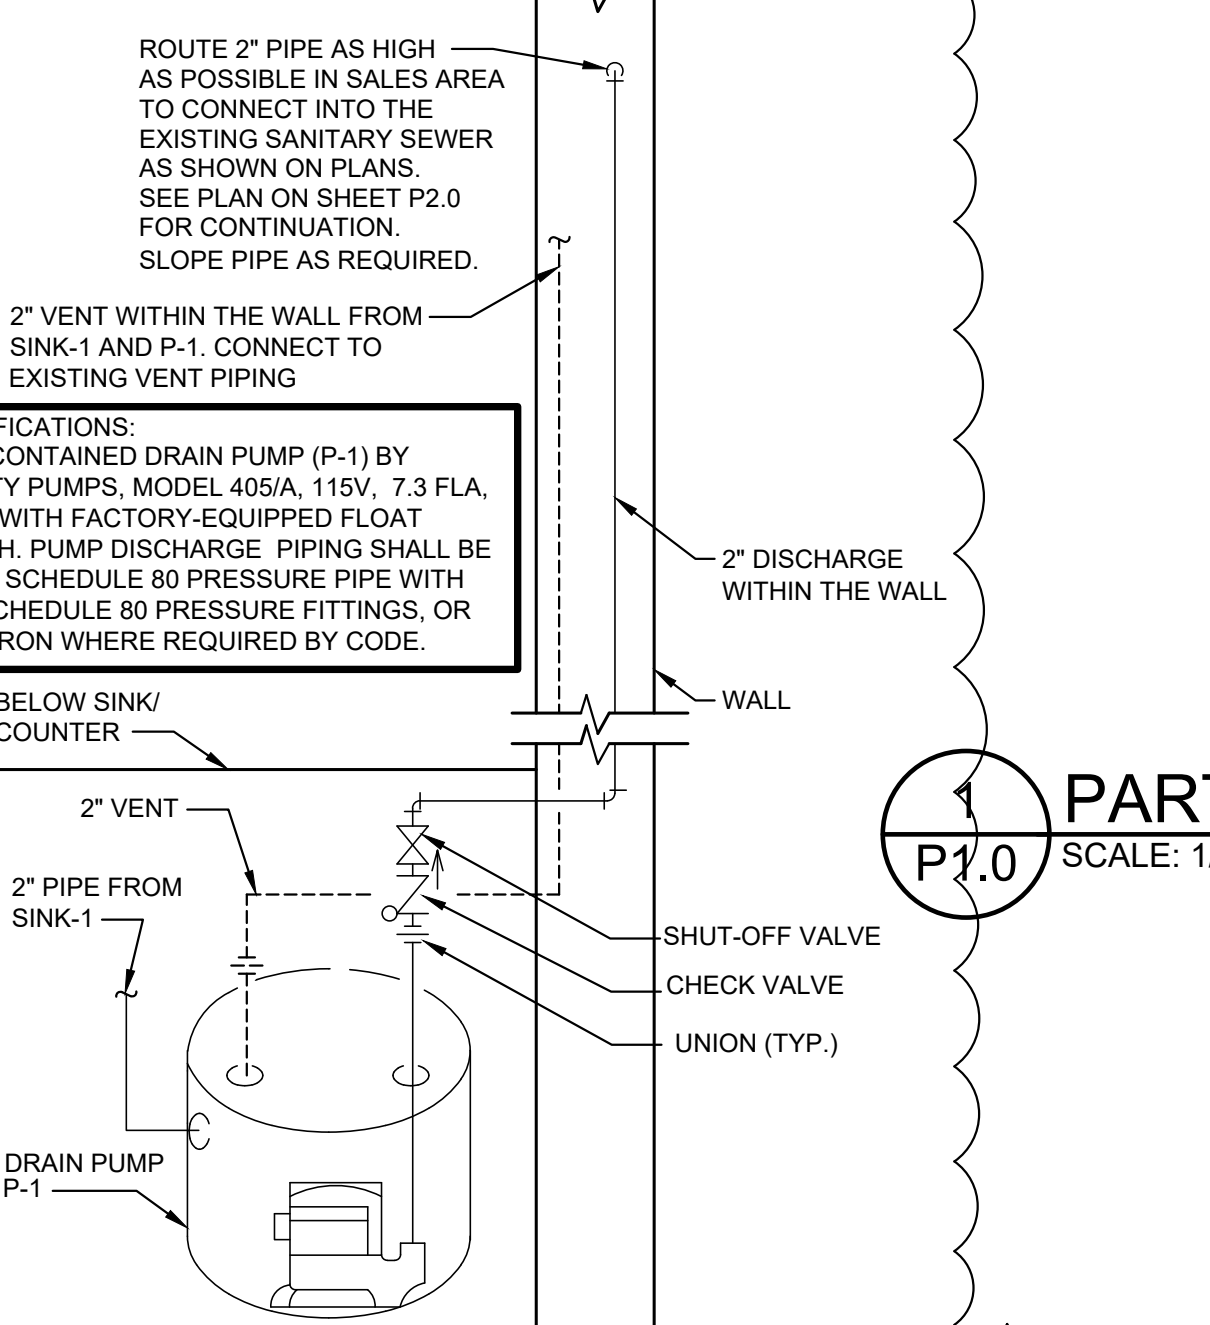


10 DRAIN PUMP (P-1) DETAIL
SCALE: NOT TO SCALE

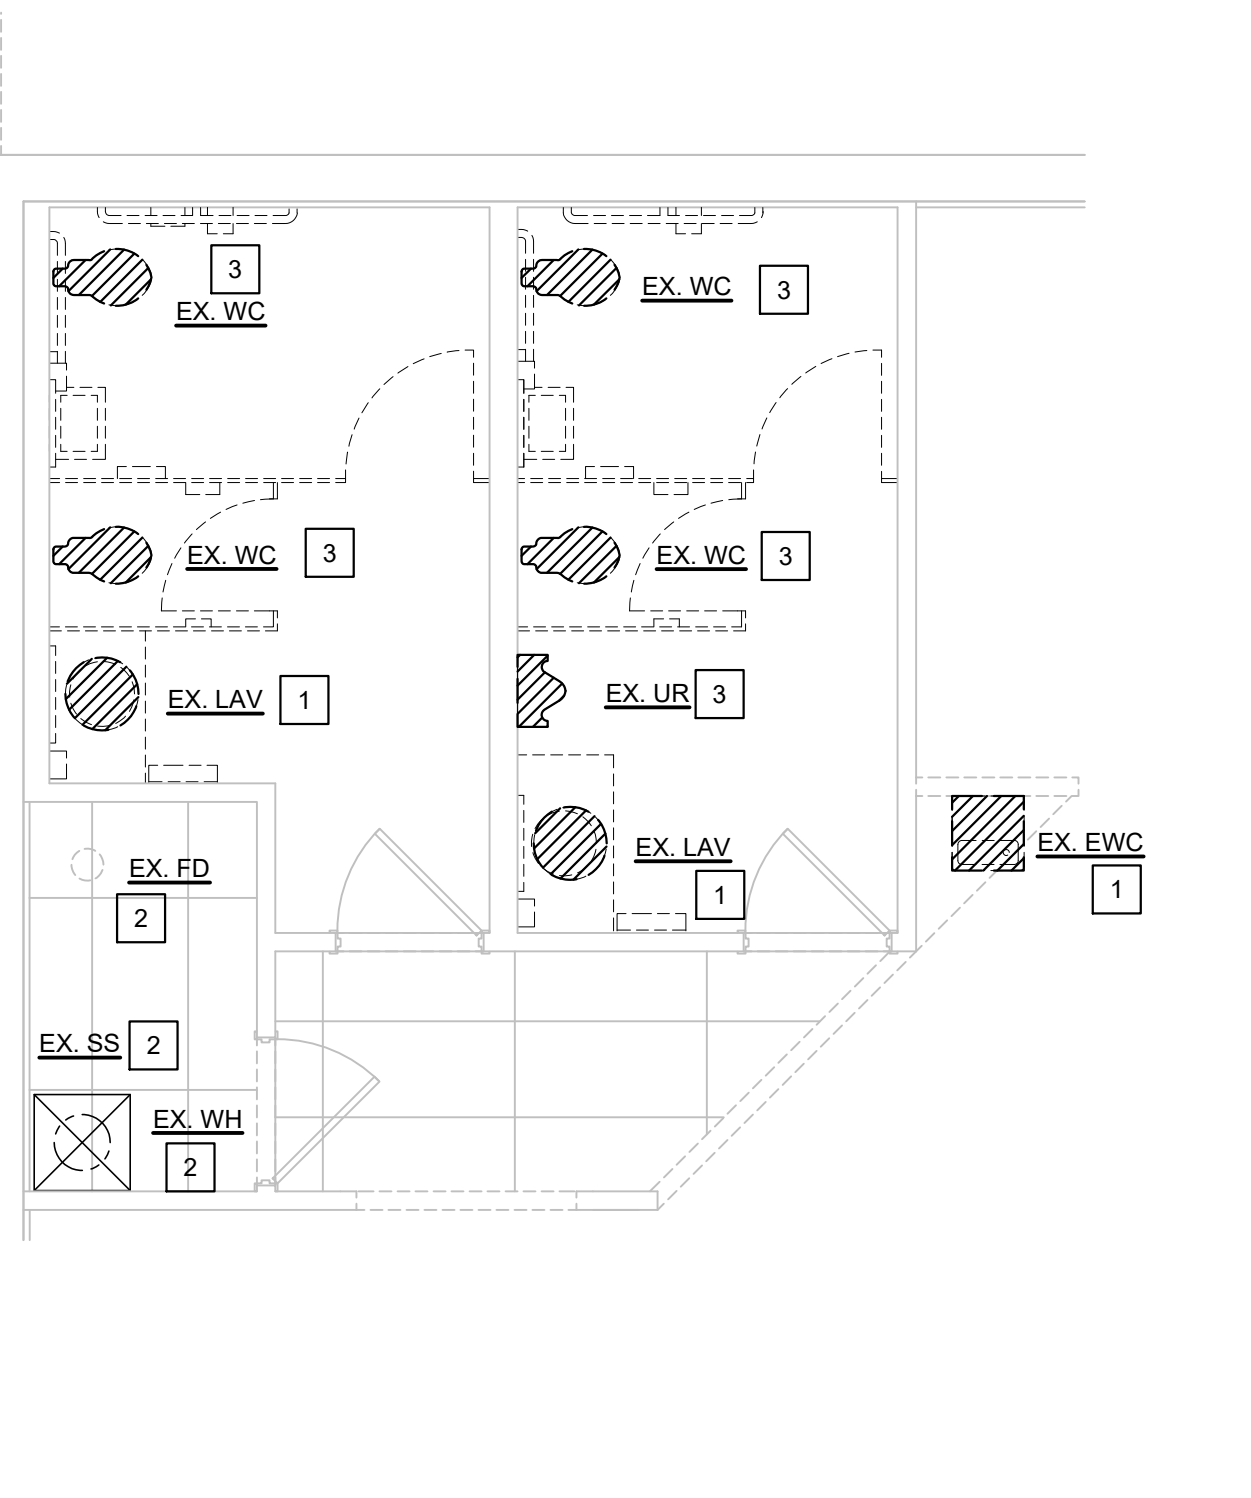


1 PARTIAL ENLARGED PLUMBING DEMO PLAN
SCALE: 1/4" = 1'-0"

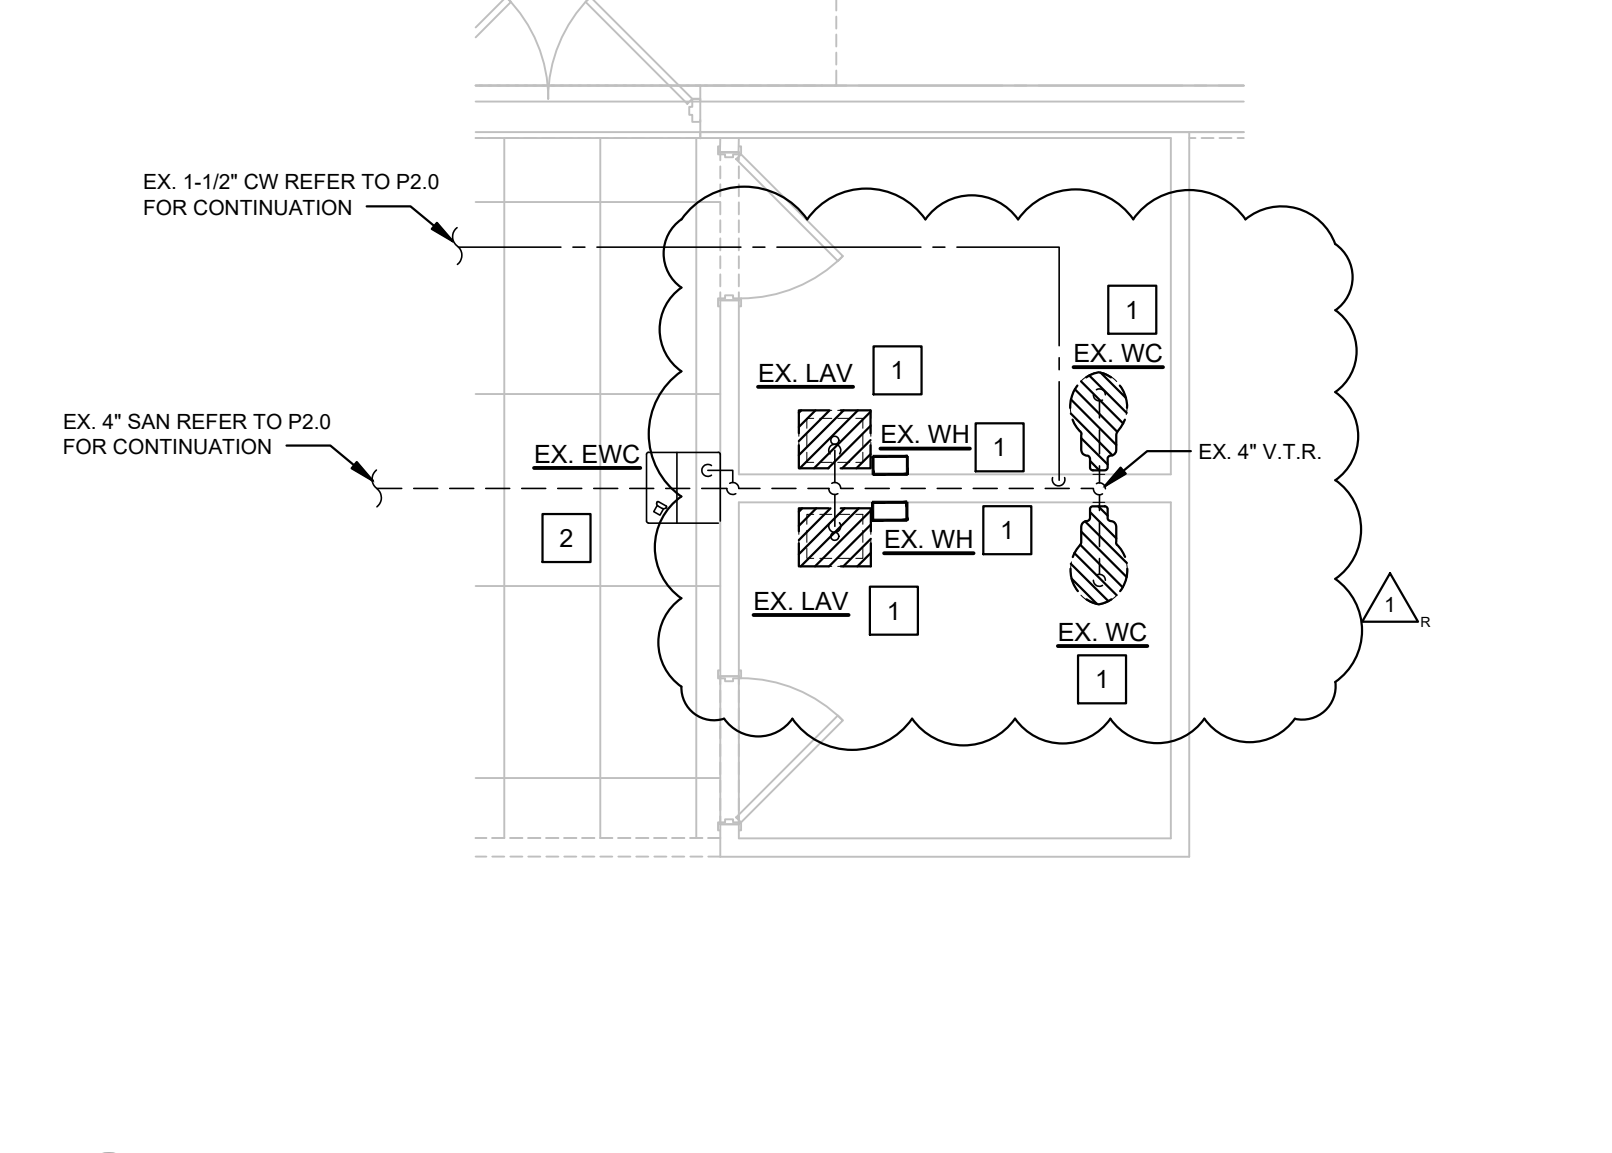

2 PARTIAL ENLARGED PLUMBING DEMO PLAN
SCALE: 1/4" = 1'-0"

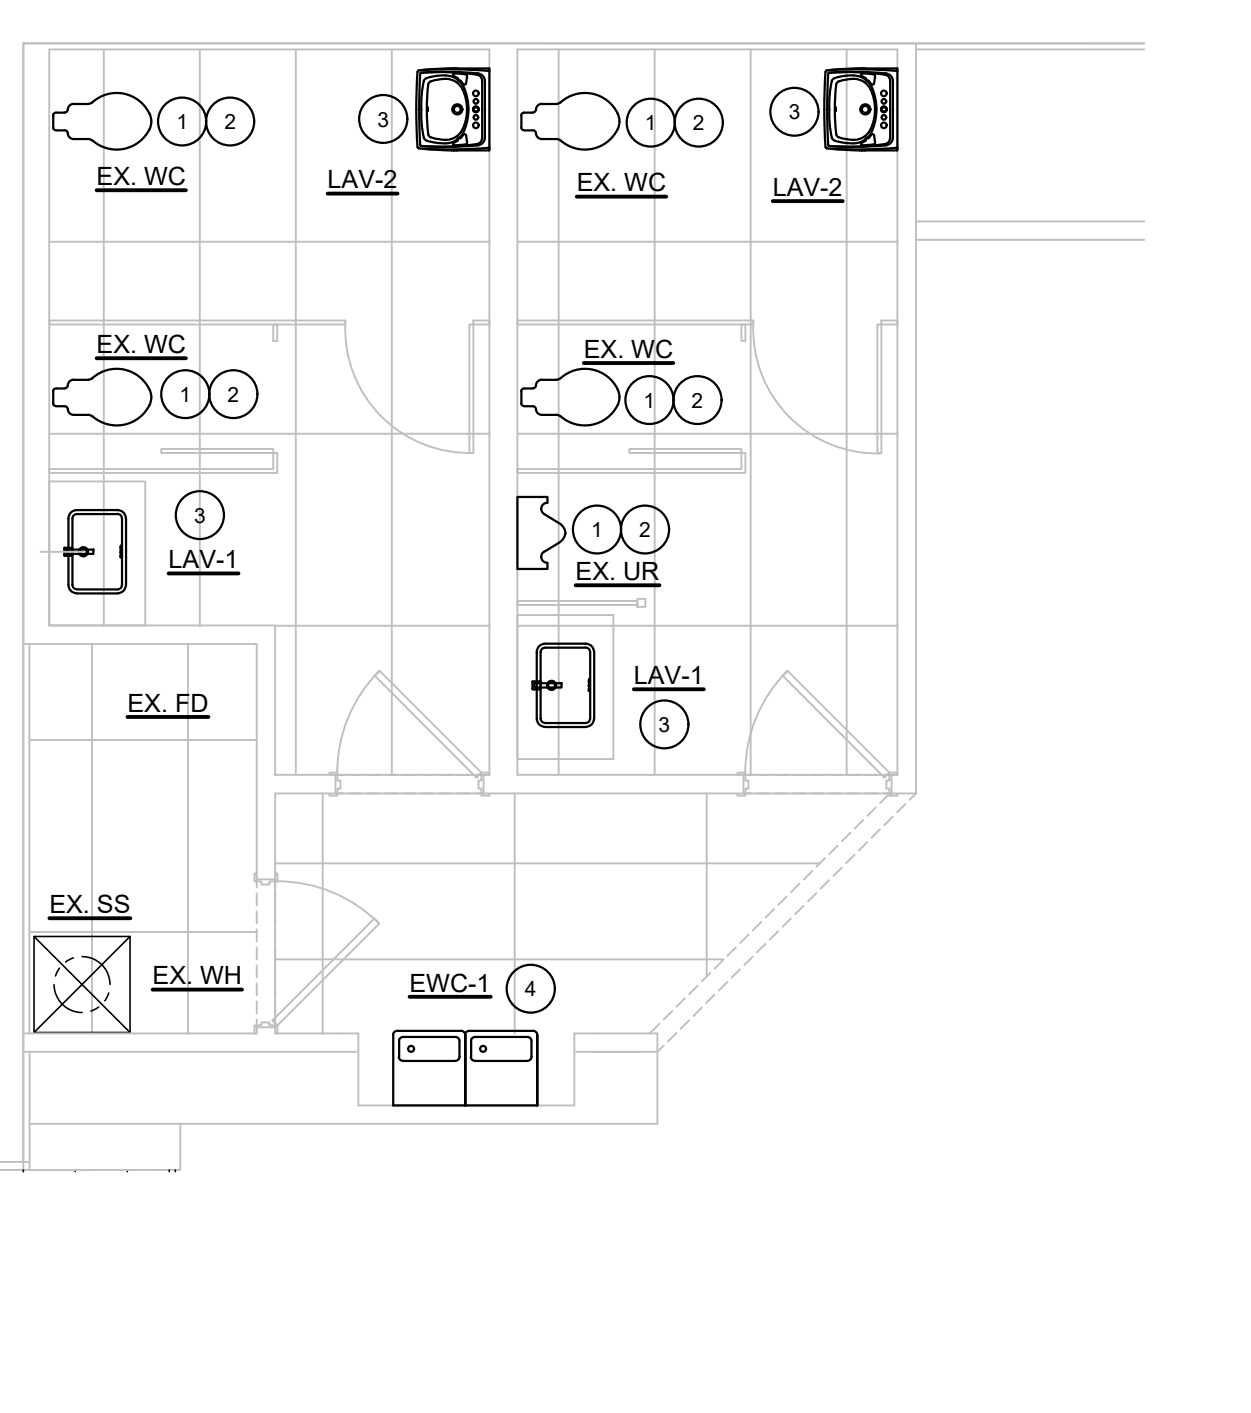

3 PARTIAL ENLARGED PLUMBING PLAN
SCALE: 1/4" = 1'-0"

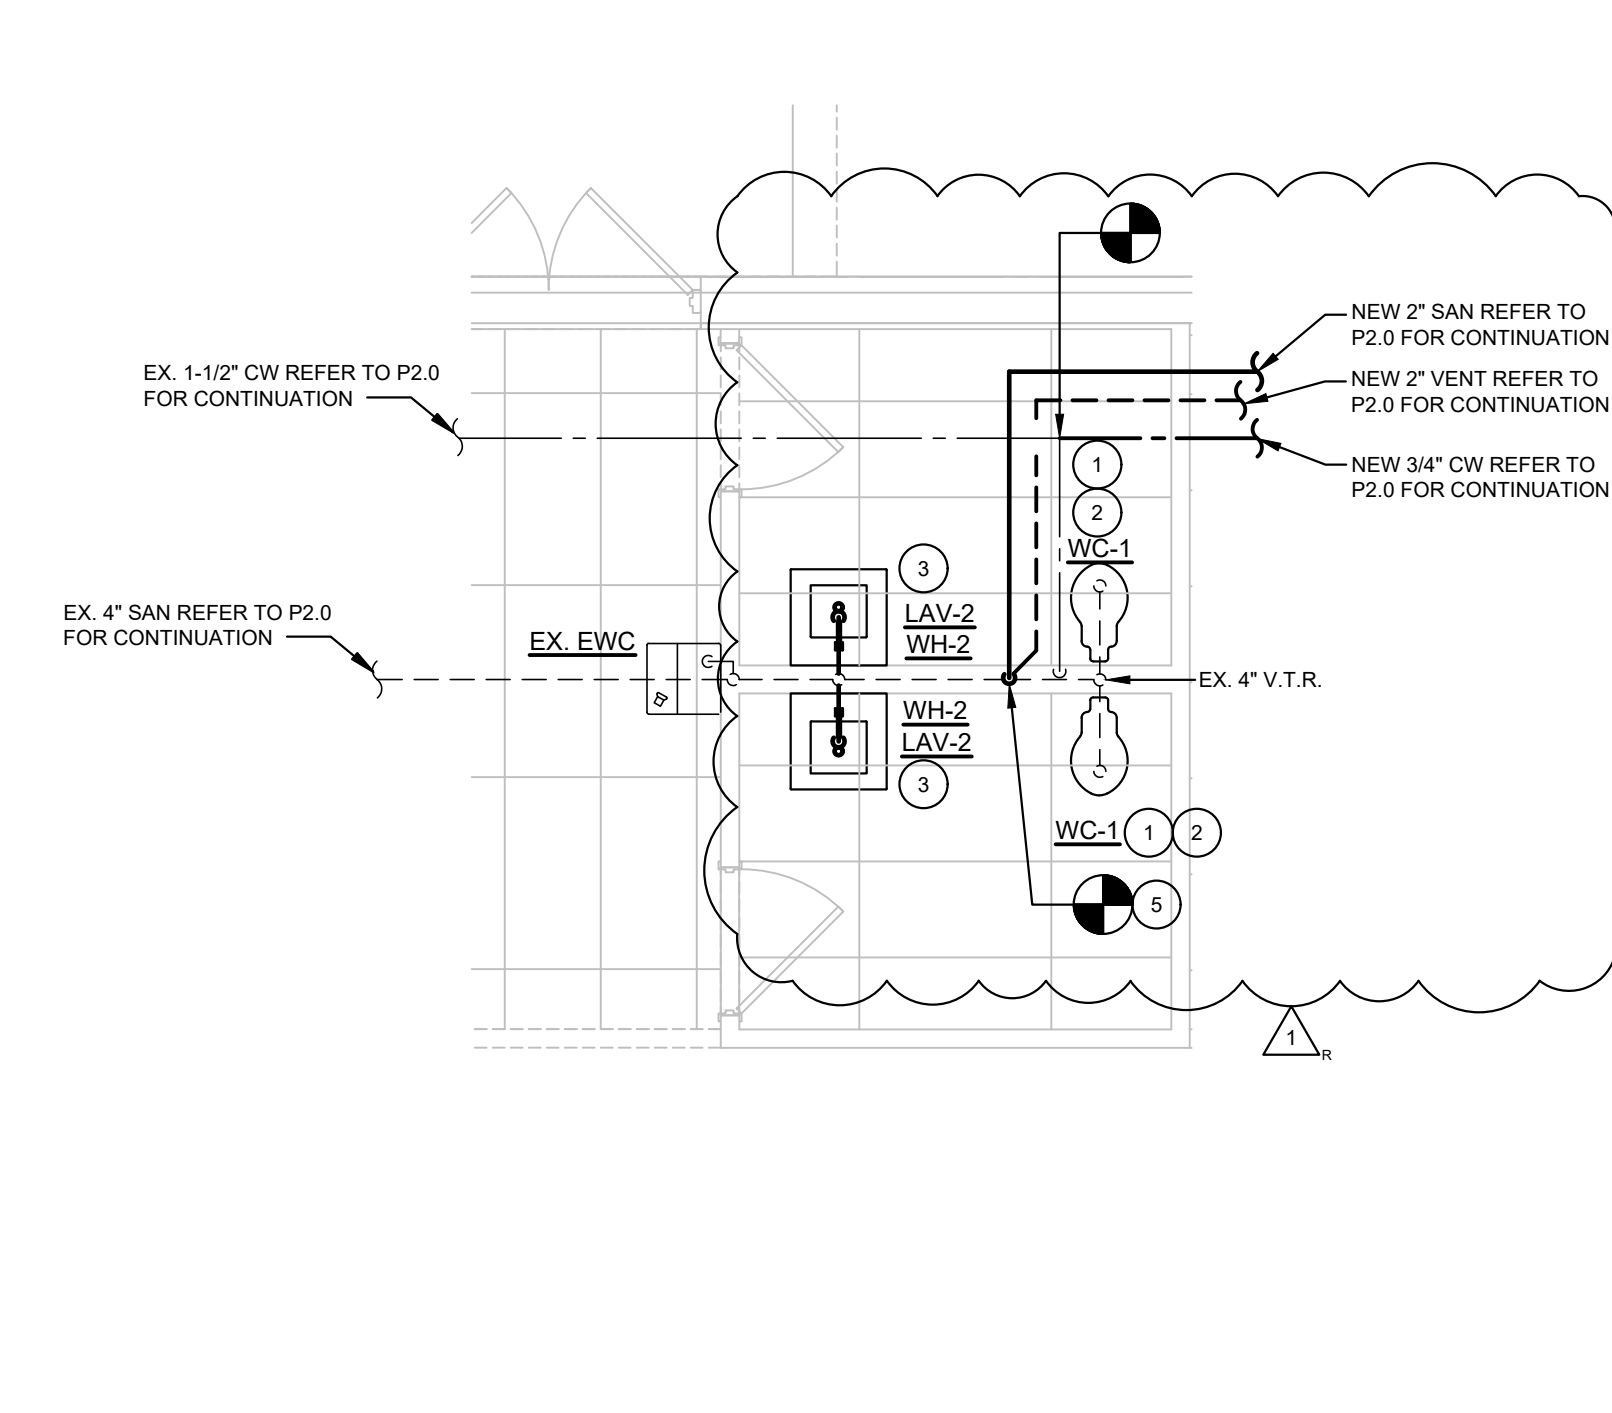

4 PARTIAL ENLARGED PLUMBING PLAN
SCALE: 1/4" = 1'-0"

PLUMBING GENERAL NOTES

- THE PLUMBING SUBCONTRACTOR'S SCOPE OF WORK INCLUDES ALL WORK WITHIN BUILDING UNLESS OTHERWISE NOTED.
- SANITARY PIPING TO BE PVC. SLOPE 1/4" PER FOOT. EXTERIOR PVC CONDENSATE PIPING SHALL BE PAINTED LIGHT GRAY. USE LONG RADIUS SWEEPS ON CONDENSATE PIPE.
- THE PLUMBING SUBCONTRACTOR SHALL COORDINATE LOCATIONS OF ALL PLUMBING PIPING TO CLEAR INTAKE LOUVERS. PROVIDE 10" CLEARANCE IN ALL DIRECTIONS FROM VENTS THROUGH ROOF TO OUTSIDE AIR INTAKES.
- THE PLUMBING SUBCONTRACTOR SHALL REFER TO THE FIXTURING PLAN FOR COORDINATION OF ALL PIPING, EQUIPMENT, DUCTS, VALVING, AND SERVICE RISERS WITH THE FIXTURING. ALL SYSTEMS SHALL BE ROUTED AND/OR LOCATED AS REQUIRED TO AVOID INTERFERENCE WITH THE FIXTURES. INSTALLATIONS MADE WITHOUT REGARD TO FIXTURING SHALL BE CORRECTED AT NO ADDITIONAL COST TO THE OWNER.
- THE PLUMBING SUBCONTRACTOR SHALL VERIFY AND MAKE CONNECTION TO UTILITIES.
- THE PLUMBING SUBCONTRACTOR SHALL FILL FLOOR DRAINS WITH WATER UPON COMPLETION OF WORK AND TESTING.
- SLOPE HORIZONTAL VENT PIPING TOWARDS DRAIN PIPING.
- ALL HOT AND COLD WATER PIPING SHALL BE INSULATED PER SPECIFICATIONS.
- PIPING IN EXPOSED CEILING AREAS SHALL BE ROUTED AS HIGH AS POSSIBLE IN JOIST WITH ALLOWANCE FOR SLOPE AS REQUIRED.
- ALL ABOVE GRADE PIPING SHALL BE RUN CONCEALED IN ALL ROOMS AND AREAS WHERE HUNG CEILING IS APPLIED.
- CONDENSATE PIPING SHALL BE 1-1/2" MINIMUM PVC. EXTERIOR PVC CONDENSATE PIPING SHALL BE PAINTED LIGHT GRAY. USE LONG RADIUS SWEEPS ON CONDENSATE PIPE.
- NOT USED.
- DOMESTIC WATER PIPE SIZES ARE BASED ON FLOW CONDITIONS OF 55 GPM AND 55 PSI AT THE MAIN. VERIFY FLOW CONDITIONS. IF ACTUAL FLOW CONDITIONS ARE DIFFERENT, CONTACT MECHANICAL ENGINEER.
- PROVIDE FIXTURES AS SPECIFIED OR AS OTHERWISE APPROVED BY ARCHITECT. SUBSTITUTES NOT ALLOWED WITHOUT ARCHITECT'S SPECIFIC APPROVAL.
- ALL SANITARY AND WASTE PIPING SHALL BE RODDED OUT AFTER INSTALLATION IS COMPLETE, PRIOR TO JOB TURNOVER.
- REFER TO SHEET P2.0 FOR MECHANICAL AND PLUMBING SYMBOLS AND ABBREVIATIONS LEGEND.
- ALL PENETRATIONS THRU FIRE-RESISTANCE RATED ASSEMBLIES SHALL BE SEALED IN ACCORDANCE WITH THE LOCAL CODE TO MAINTAIN FIRE RATING.
- PROVIDE SOLID UNISUPPORT (P1900). NO EXCEPTIONS. FIELD DRILL THE NECESSARY HOLES AS REQUIRED, COORDINATE WITH OWNER.

DEMOLITION GENERAL NOTES

- ALL DEMOLITION WORK SHALL BE EXECUTED IN COMPLIANCE WITH ALL APPLICABLE FEDERAL, STATE AND LOCAL CODES, LAWS AND REGULATIONS.
- DURING THE BIDDING PERIOD, EACH BIDDING CONTRACTOR SHALL VISIT THE SITE AND FACILITY TO VERIFY ALL EXISTING CONDITIONS, AND VERIFY THE SCOPE OF WORK INDICATED BY ALL CONTRACT DOCUMENTS. FAILURE TO DETERMINE AND/OR ANTICIPATE THE IMPACT OF THE SCOPE OF WORK ON EXISTING CONDITIONS SHALL NOT BE JUSTIFICATION FOR ADDITIONAL COMPENSATION. ANY DISCREPANCIES DISCOVERED IN THE CONTRACT DOCUMENTS SHALL BE IMMEDIATELY REPORTED TO THE OFFICE OF THE ARCHITECT.
- UNLESS NOTED OTHERWISE OR INSTRUCTED BY THE PROJECT CONSTRUCTION MANAGER, ALL DEMOLISHED MATERIAL AND EQUIPMENT IS TO BECOME THE PROPERTY OF THE CONTRACTOR AND SHALL BE REMOVED FROM THE SITE IN A SAFE AND LEGAL MANNER. NO ON SITE SALE OR STORAGE OF MATERIAL IS ALLOWED.
- ALL MATERIALS, EQUIPMENT, FIXTURES, SYSTEMS AND ACCESSORIES WHICH ARE TO REMAIN IN SERVICE SHALL BE CLEANED, REPAIRED, ADJUSTED, RECONDITIONED, AND PLACED INTO PROPER OPERATION, UNLESS OTHERWISE NOTED.
- CONTRACTOR SHALL FOLLOW THE PROGRESS OF THE GENERAL DEMOLITION AND REMODELING WORK TO ASSURE THE ACCESSIBILITY AND SAFETY OF EQUIPMENT AND SYSTEMS TO REMAIN IN SERVICE, AND TO PROVIDE FOR THE TIMELY REMOVAL AND/OR RELOCATION OF EQUIPMENT, PIPING, ETC.
- CONTRACTOR SHALL SEAL PENETRATIONS THROUGH FLOORS, WALLS, CEILING AND ROOFS WHERE AND/OR PLUMBING AND/OR MECHANICAL COMPONENTS ARE REMOVED AND THE EXISTING PENETRATION IS NOT USED FOR THE NEW INSTALLATION. CONTRACTOR SHALL REPAIR SURFACES TO MATCH ADJACENT AREAS.
- CONTRACTOR SHALL INSTALL PERMANENT CAPS WHERE DUCTWORK AND PIPING IS REMOVED AND THE EXISTING TAPS ARE NOT USED FOR THE NEW INSTALLATION. CONTRACTOR SHALL INSTALL TEMPORARY CAPS WHERE DUCTWORK AND PIPING IS REMOVED AND THE EXISTING TAPS WILL BE USED FOR THE NEW INSTALLATION TO PROTECT THE INTERIOR SURFACES UNTIL NEW DUCTWORK AND PIPING IS INSTALLED.
- CONTRACTOR SHALL PROVIDE ADEQUATE PROTECTION FOR ALL EXISTING CONSTRUCTION DURING THE DEMOLITION AND CONSTRUCTION PROCESS TO PREVENT DAMAGE TO EXISTING FINISHES OR MATERIALS TO REMAIN FOR NEW INSTALLATION. REPAIR DAMAGE CAUSED DURING WORK AT NO EXTRA COST TO THE OWNER.
- THIS DRAWING IS FOR GENERAL REFERENCE AND ORIENTATION. ALL EXISTING EQUIPMENT, DUCTWORK, ETC. SHOWN WERE ORIENTED PER ORIGINAL CONSTRUCTION DOCUMENTS, AND FIELD OBSERVATION WHEN POSSIBLE. ACTUAL LOCATIONS, SIZES, QUANTITY, AND CONFIGURATIONS MAY VARY FROM THAT SHOWN. CONTRACTOR SHALL VERIFY ALL FIELD CONDITIONS. ALL WORK PERFORMED SHALL MEET ALL REQUIREMENTS OF THE SPECIFICATIONS AND SHALL BE AS INDICATED ON ALL CONSTRUCTION DOCUMENTS.
- SEE ELECTRICAL, PLUMBING, MECHANICAL AND ARCHITECTURAL DRAWINGS FOR ADDITIONAL INFORMATION ON REMOVAL, REUSE, & RELOCATION OF EXISTING EQUIPMENT, PIPING, CONDUIT, DUCTWORK, ETC.

PLUMBING KEYED NOTES


- RECONNECT EXISTING FIXTURE TO EXISTING SANITARY AND VENT PIPING. VERIFY IN FIELD EXISTING SANITARY AND VENT PIPING SIZES, LOCATIONS, AND ELEVATIONS.
- RECONNECT EXISTING FIXTURE TO EXISTING COLD WATER PIPING. VERIFY IN FIELD EXISTING COLD WATER PIPING SIZES, LOCATIONS, AND ELEVATIONS.
- CONNECT NEW LAVATORY TO EXISTING COLD WATER, HOT WATER, SANITARY AND VENT PIPING. VERIFY IN FIELD EXISTING PIPING SIZES, LOCATIONS, AND ELEVATIONS.
- CONNECT NEW ELECTRIC WATER COOLER TO EXISTING COLD WATER, SANITARY, AND VENT PIPING. VERIFY IN FIELD EXISTING PIPING SIZES, LOCATIONS, AND ELEVATIONS.
- CONNECT TO EXISTING SANITARY AND VENT PIPING. VENT PIPING SHOWN OFFSET FOR CLARITY. VERIFY IN FIELD EXISTING SANITARY AND VENT PIPING SIZES, LOCATIONS, AND ELEVATIONS.

NOTE:
ALL WORK SHALL COMPLY WITH DRAWINGS AND SPECIFICATIONS. THIS IS A PROTOTYPICAL DESIGN. ANY FIELD CHANGES REQUIRE OWNER OR ARCHITECT APPROVAL.

ROOMS TO GO STORE EXPANSION AND REMODEL

18722 SOUTH DIXIE HIGHWAY, CUTLER BAY, FL 33157

Date 11/29/23
Description: ADDENDUM #2
No. 1

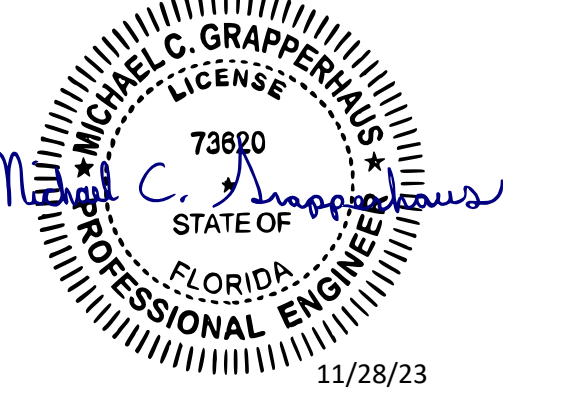

Drawn By/Checked By: JCM/MCG
Project Number 2101445
Bid Date 11/09/23
Permit 03/28/23
Owner Date 07/06/22

PLUMBING SCHEDULES AND DETAILS P1.0

PLUMBING KEYED NOTES

- 1 ROUTE NEW RTU CONDENSATE WASTE PIPE TO ROOF SCUPPER (TYPICAL ALL ROOFTOP UNITS).
- 2 CONDENSATE PIPING SHALL BE SUPPORTED ON MIFAB PIPESTANDS. SEE ROOF PIPING SUPPORT DETAIL ON SHEET P1.0 FOR SPECIFICATION. PROVIDE WITH MIFAB PIPE STRAP. CONNECT TO GUIDE HOLES AT THE TOP OF THE PIPE STAND WITH #8 STAINLESS STEEL SCREWS. LAY BLOCKING FLAT AND CENTER BELOW PIPING. DO NOT ATTACH PIPESTAND TO ROOF. TYPICAL AT ALL RTU'S.
- 3 CONNECT NEW SINK TO EXISTING COLD WATER, SANITARY, AND VENT PIPING. VERIFY IN FIELD EXISTING PIPING SIZES, LOCATIONS, AND ELEVATIONS. SEE SHEET P1.0 FOR POINT OF CONNECTION TO EXISTING PIPING, AND INSTANT FLOW WATER HEATER (WH-2) DETAIL.
- 4 ALL DOWNSPOUTS SHALL BE PIPED TO STORM - SEE DETAIL #9 ON SHEET P1.0, AS WELL AS CIVIL AND ARCHITECTURAL PLANS FOR MORE INFORMATION.
- 5 REPLACE EXISTING 6" SANITARY SEWER LINE BELOW NEW ADDITION. SEE ENLARGED DEMO PLAN FOR MORE INFORMATION.
- 6 REPLACE EXISTING UNDERGROUND 2" DOMESTIC WATER LINE BELOW NEW ADDITION. SEE ENLARGED DEMO PLAN FOR MORE INFORMATION.
- 7 CONNECT TO EXISTING SANITARY SEWER. VERIFY IN FIELD EXISTING PIPING SIZES, LOCATIONS, AND ELEVATIONS.
- 8 CONNECT TO EXISTING 2" DOMESTIC WATER SERVICE UPSTREAM OF EXISTING RISER AND HOUSE VALVE. VERIFY IN FIELD EXISTING PIPING SIZES, LOCATIONS, AND ELEVATIONS.
- 9 EXTEND 1-1/2" CONDENSATE PIPE TO CONNECT INTO EXISTING CONDENSATE PIPING ON ROOF. SEE CONDENSATE DETAIL ON SHEET P1.0 FOR MORE INFORMATION.
- 10 6" FIRE PROTECTION LINE INCOMING SERVICE BELOW GRADE. SEE CIVIL DRAWINGS FOR BACKFLOW DEVICE LOCATION AND CONTINUATION. FIRE PROTECTION CONTRACTOR'S WORK SHALL BEGIN AT 6" BLIND FLANGE 5'-0" OUTSIDE OF THE BUILDING PROVIDED BY CIVIL.
- 11 PROVIDE SHUT-OFF VALVE WITH SUPERVISORY SWITCH IN VERTICAL RISE.
- 12 LABEL NEW FIRE PROTECTION PIPING PRIOR TO CONNECTION WITH EXISTING RISER: "6" EXPRESS MAIN - NO FITTINGS ALLOWED"
- 13 CONNECT TO EXISTING FIRE RISER ABOVE FINISHED FLOOR, UPSTREAM OF ALL ACCESSORIES. FIELD VERIFY EXISTING ELEVATIONS AND RAISE RISER IF REQUIRED FOR RECONNECTION.
- 14 DEMO EXISTING UNDERGROUND 6" FIRE LINE UPSTREAM OF EXISTING FIRE RISER. SEE CIVIL FOR CONTINUATION.
- 15 DEMO EXISTING SANITARY PIPING AS INDICATED BY DASHED LINE. FIELD VERIFY EXISTING LOCATIONS AND ELEVATIONS.
- 16 DEMO EXISTING DOMESTIC COLD WATER PIPING AS INDICATED BY DASHED LINE. FIELD VERIFY EXISTING LOCATIONS AND ELEVATIONS. SEE CIVIL DRAWINGS FOR CONTINUATION.
- 17 ROUTE NEW 2" VENT PIPING AS HIGH AS POSSIBLE, AND DROP IN CONCEALED LOCATION TO NEW SINK-1 AND P-1. SEE ENLARGED PLANS ON SHEET P1.0 FOR CONTINUATION OF SANITARY AND VENT PIPING.
- 18 PUMP DISCHARGE PIPING SHALL BE 2" PVC SCHEDULE 80 PRESSURE PIPE WITH PVC SCHEDULE 80 PRESSURE FITTINGS, OR CAST IRON WHERE REQUIRED BY CODE. ROUTE NEW 2" SANITARY PIPING FROM P-1 AS HIGH AS POSSIBLE, AND DROP IN CONCEALED LOCATION TO CONNECT TO EXISTING SANITARY LINE. SEE ENLARGED PLANS ON SHEET P1.0 FOR CONTINUATION OF SANITARY AND VENT PIPING.
- 19 ROUTE 2" SANITARY FROM SINK-1 AT A SLOPE OF 1/4" TO P-1 INLET. SEE DRAIN PUMP (P-1) DETAIL ON SHEET P1.0 FOR MORE INFORMATION.

ALL WORK SHALL COMPLY WITH DRAWINGS AND SPECIFICATIONS. THIS IS A PROTOTYPICAL DESIGN. ANY FIELD CHANGES REQUIRE OWNER OR ARCHITECT APPROVAL.

ALL CONDENSATE PIPING SHALL BE PAINTED LIGHT GRAY. EXISTING PIPING SHALL BE PAINTED AND/OR TOUCHED UP TO "LIKE NEW" CONDITION.

USE LONG RADIUS SWEEPS ON CONDENSATE PIPES.

PROVIDE SOLID UNISTRUT SUPPORT (P1000) - NO EXCEPTIONS. FIELD DRILL THE NECESSARY HOLES AS REQUIRED. COORDINATE WITH OWNER.

SEE SHEET M1 ABBREVIATIONS:

2 ENLARGED PLUMBING DEMOLITION PLAN
SCALE: 3/32" = 1'-0"

CIVIL ENGINEERING DESIGN COORDINATION NOTICE



NOTICE TO ALL PARTIES HAVING AN INTEREST IN THIS CONSTRUCTION PROJECT:

- 1.) CIVIL ENGINEERING FOR THIS PROJECT IS BEING PERFORMED BY OTHERS.
- 2.) CONTRACTORS RELYING ON DOCUMENTS NOT COORDINATED WITH THE CIVIL ENGINEERING WORK SHALL DO SO AT THEIR OWN RISK.
- 3.) COORDINATION WITH THE CIVIL ENGINEERING DOCUMENTS HAS BEEN COMPLETED ONLY AS SHOWN BELOW.

CIVIL ENGINEERING CONSULTANT IS: CKE_GROUP_INCORPORATED
WESTON_FL

CIVIL SHT. DWG. NO.	CIVIL SHEET DWG. TITLE	REV. NO.	REV. DATE	REV. NO.	REV. DATE
C-3	UTILITY_PLAN	1	02/06/23	BID	11/6/23

COORDINATION CHECKED BY		INITIAL	DATE	INITIAL	DATE
DISCIPLINE: PLUMBING		JCM	02/10/23	JCM	11/28/23

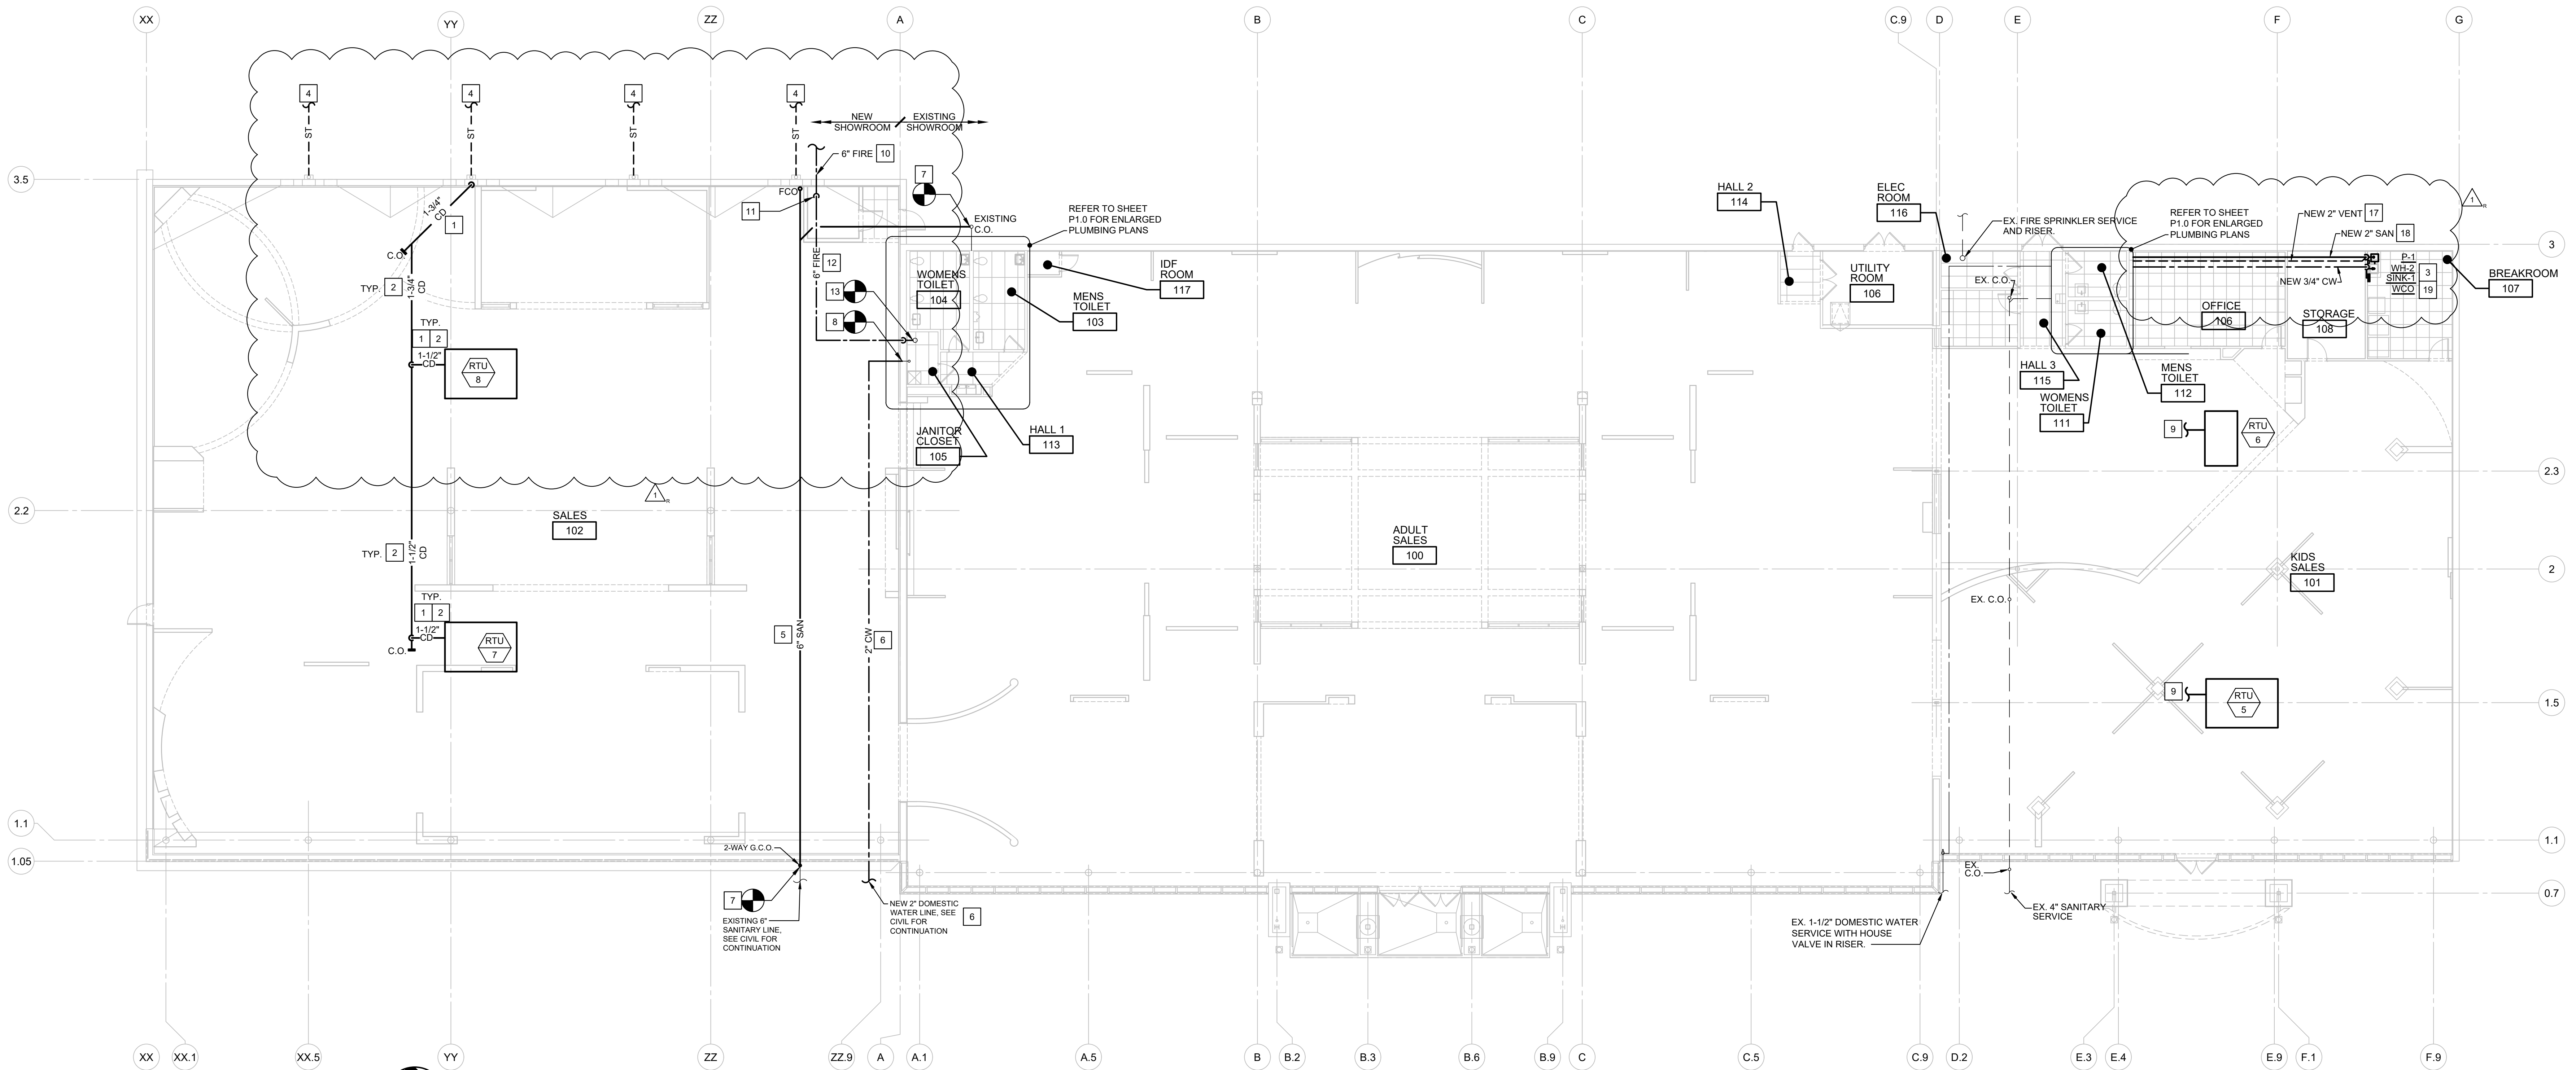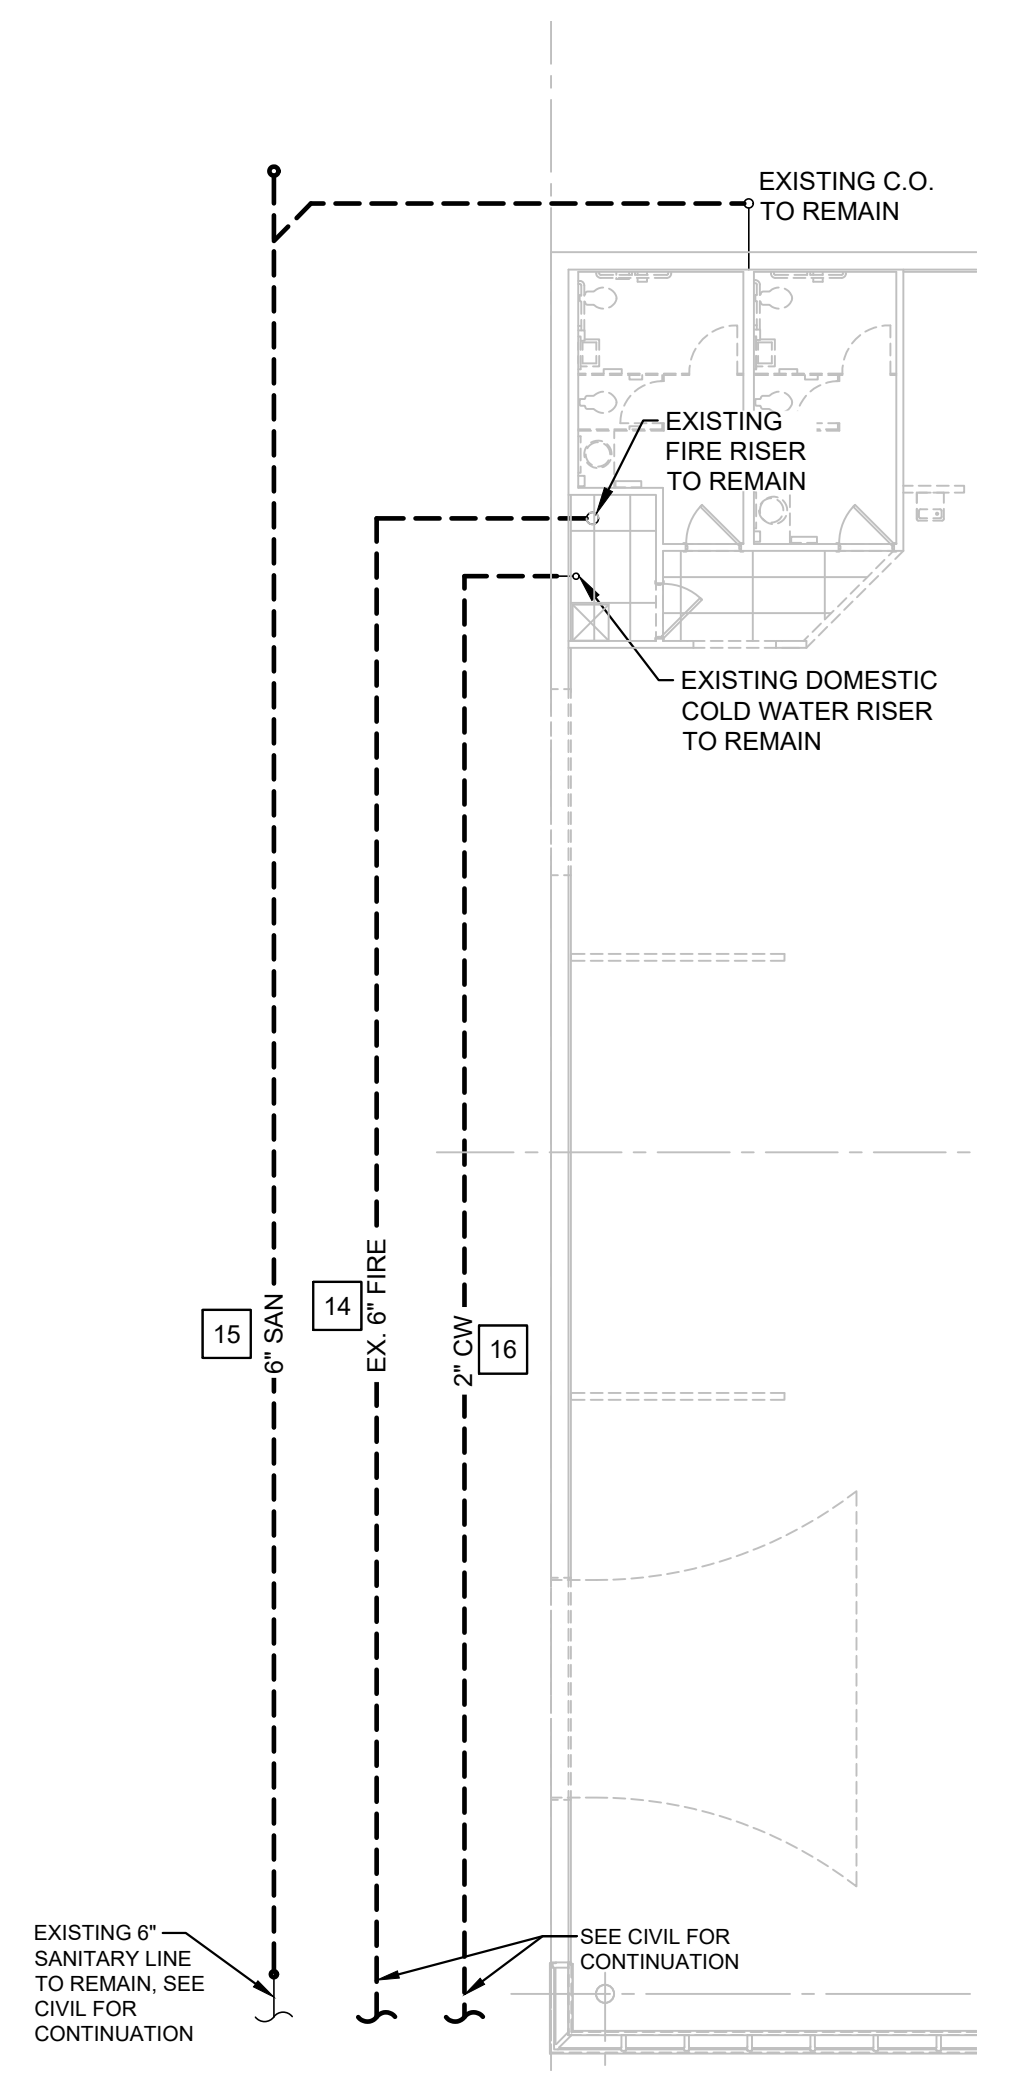

1 PLUMBING PLAN
SCALE: 3/32" = 1'-0"


ROOMS TO GO

STORE EXPANSION AND REMODEL

18722 SOUTH DIXIE HIGHWAY,
CUTLER BAY, FL 33157

CONSTR. DOC. & REVISIONS

No.	Description	Date
1	ADDENDUM #2	11/29/23

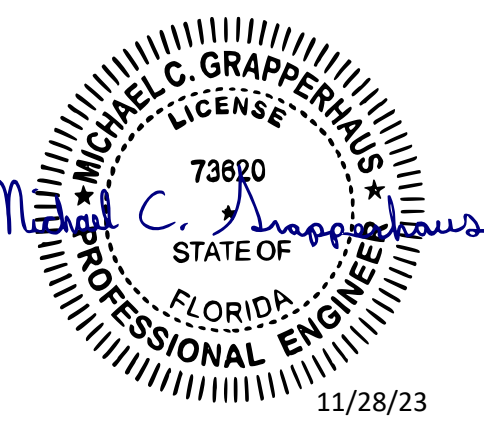


Michael C. Grapperhaus
LIC #73880
EXP. 02/28/25


Drawn By/Checked By: JCM/MCG
Project Number: 2101445
Bid Date: 11/09/23
Permit: 03/28/23
Owner Date: 07/06/22

PLUMBING PLAN
P2.0


GENERAL NOTES FOR DETAIL E2.2:
 ALL CEILING LOW VOLTAGE WIRING SHALL BE INSTALLED TO FOLLOW STEEL ELEMENTS AS SHOWN ON DETAIL.
 WIRE COLOR SHALL BE WHITE UNLESS REQUIRED BY CODE OTHERWISE.
 TIE WRAP LOW VOLTAGE WIRES WITH ZIP TIES TO THE STRUCTURAL STEEL ELEMENTS - ZIP TIES SHALL BE WHITE.

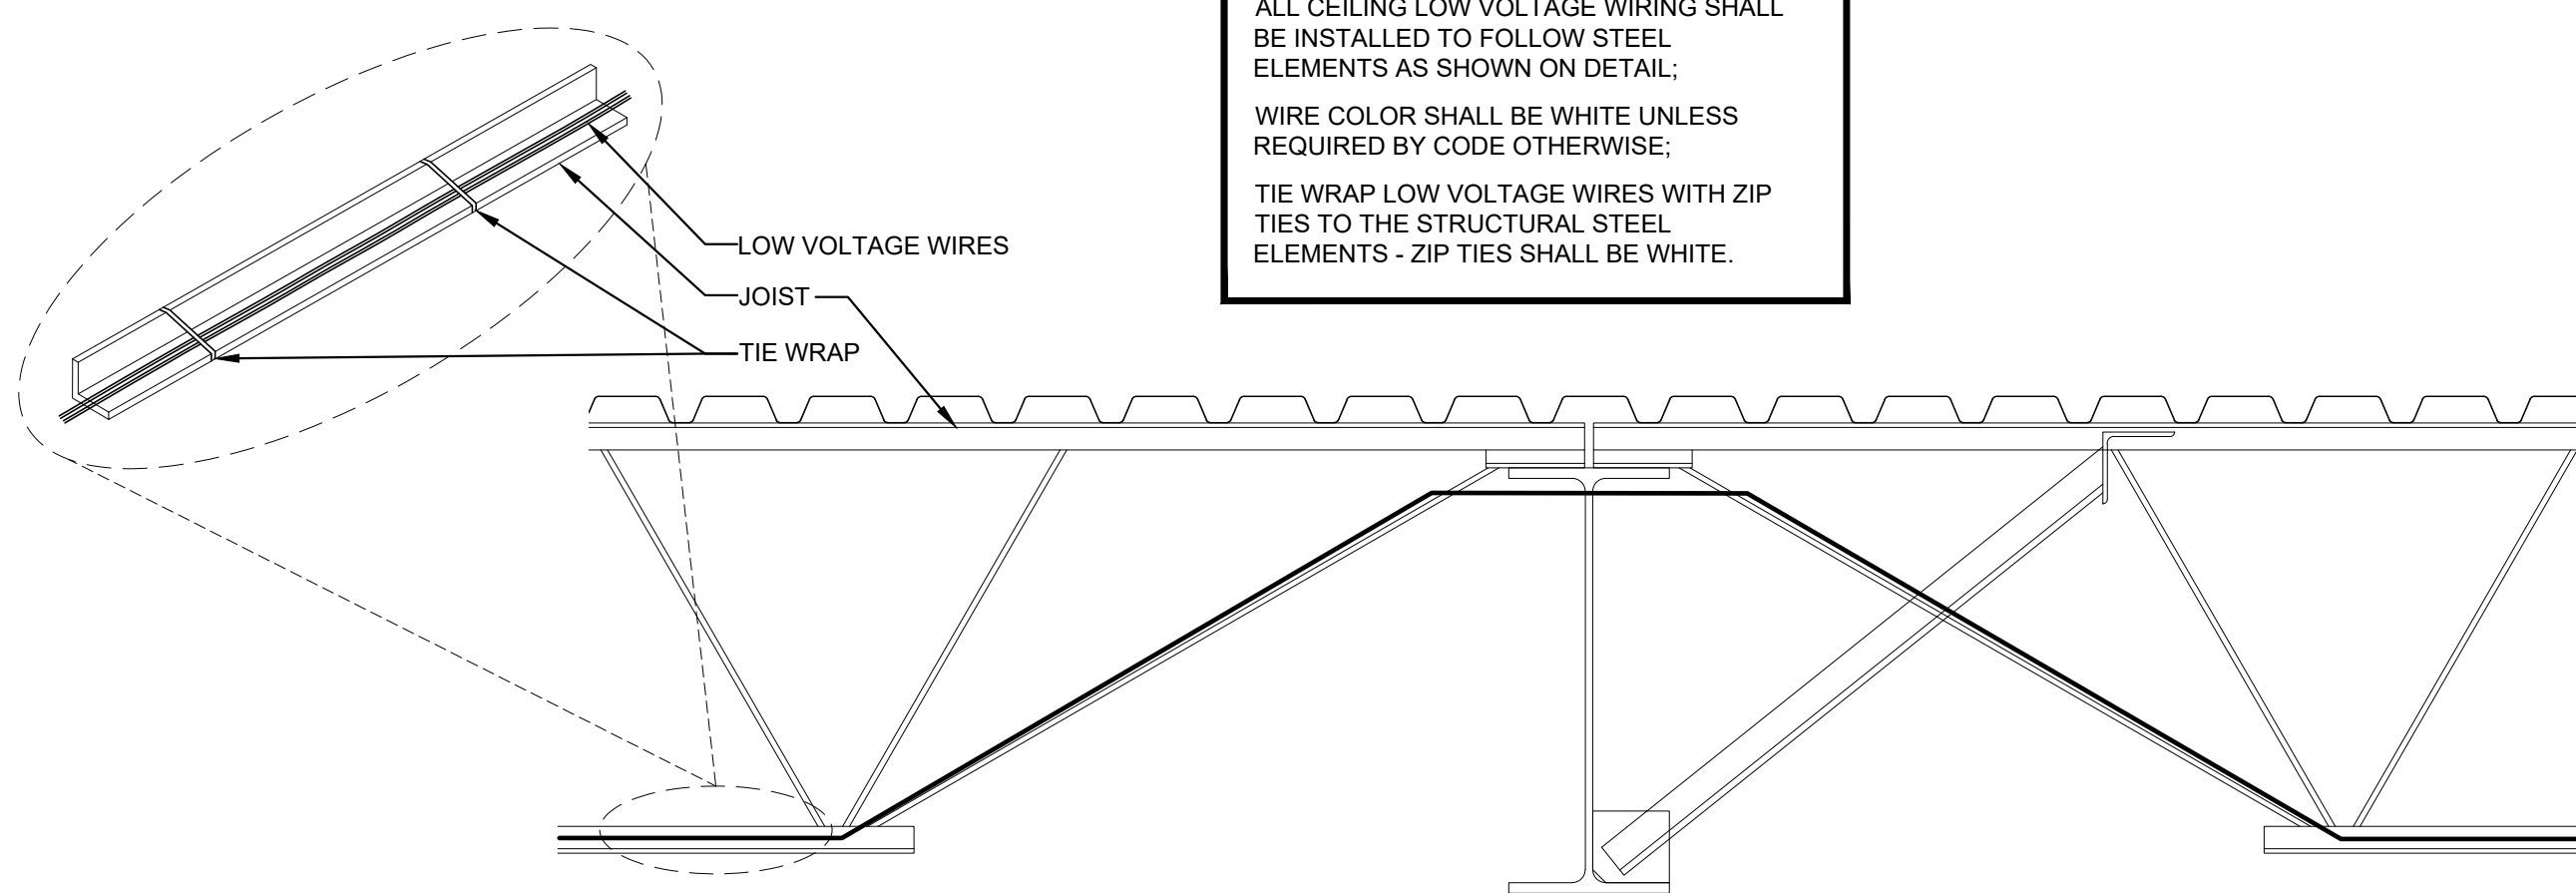


1 LOW VOLTAGE WIRING INSTALLATION
 E2.2 SCALE: NOT TO SCALE

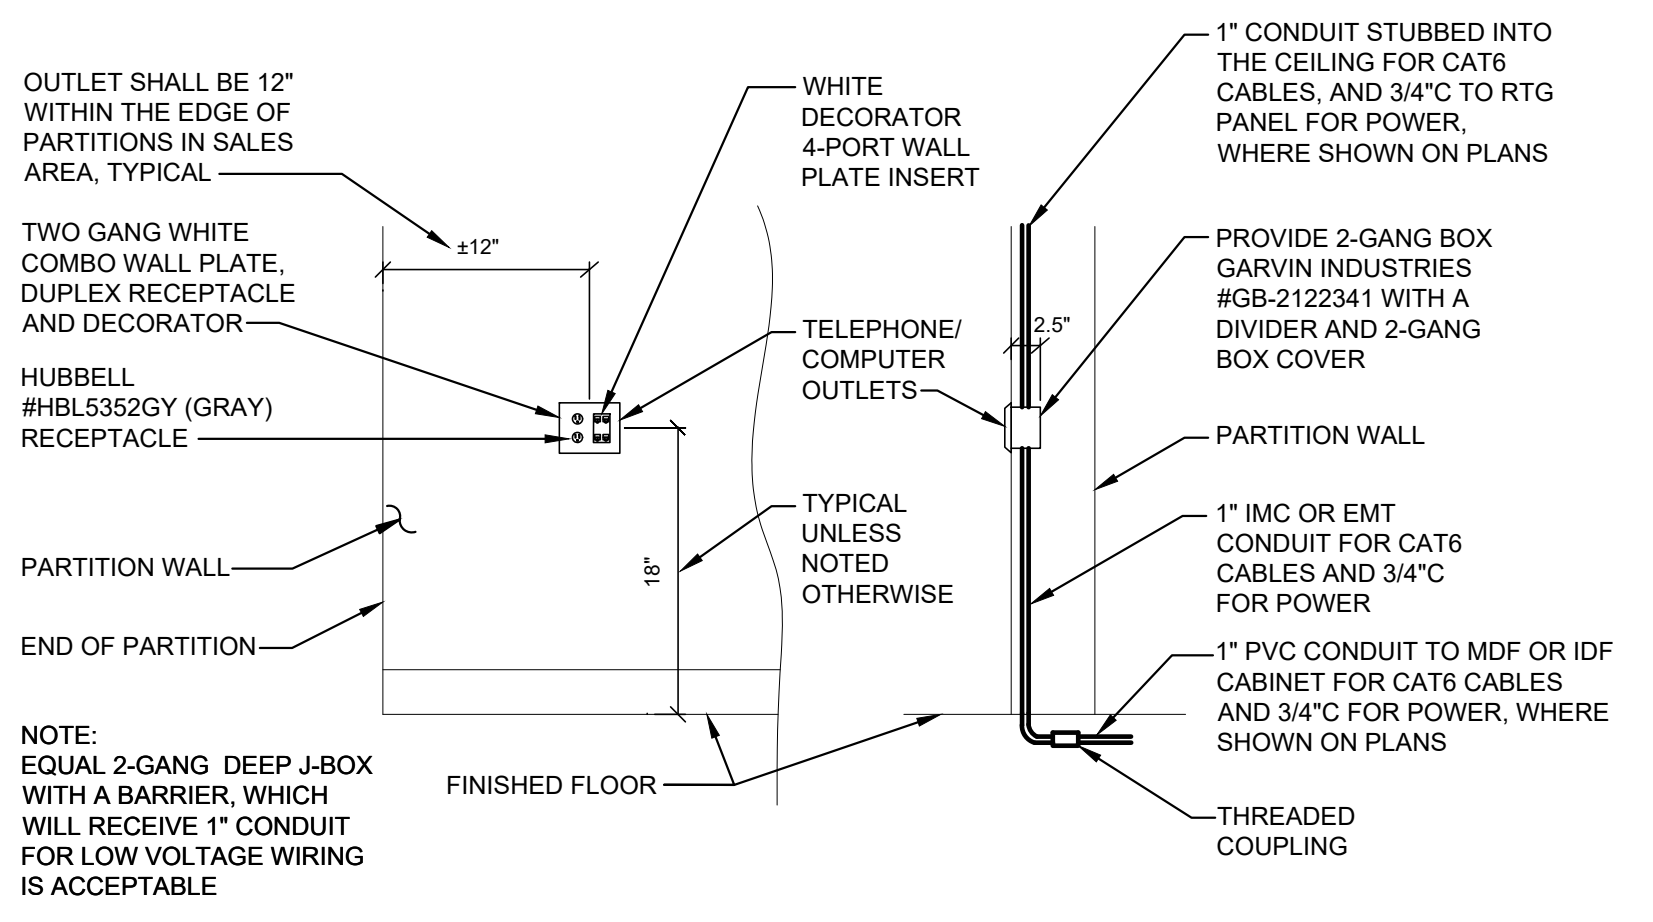


2 TELEPHONE/COMPUTER OUTLETS - ELEVATION
 E2.2 SCALE: NOT TO SCALE

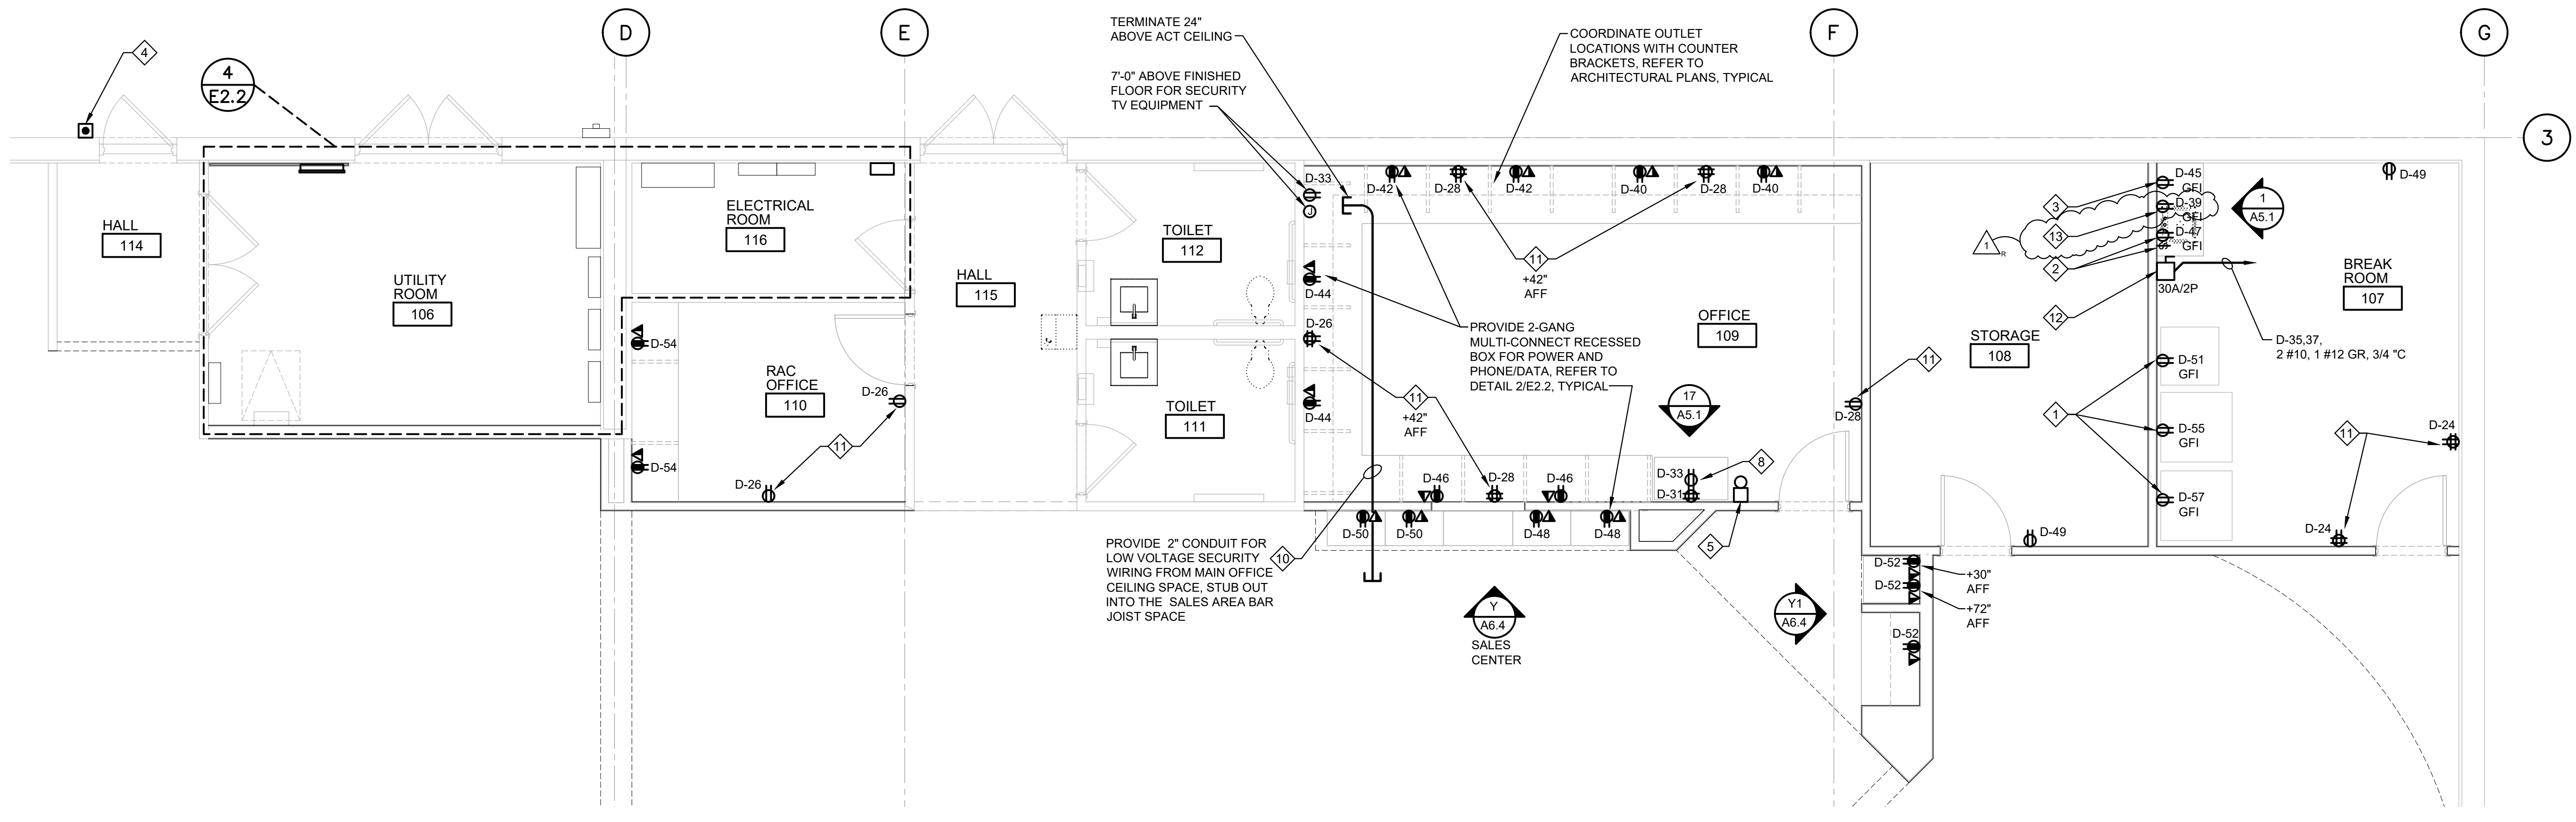

3 OFFICE AREA POWER PLAN
 E2.2 SCALE: 1/4"=1'-0"

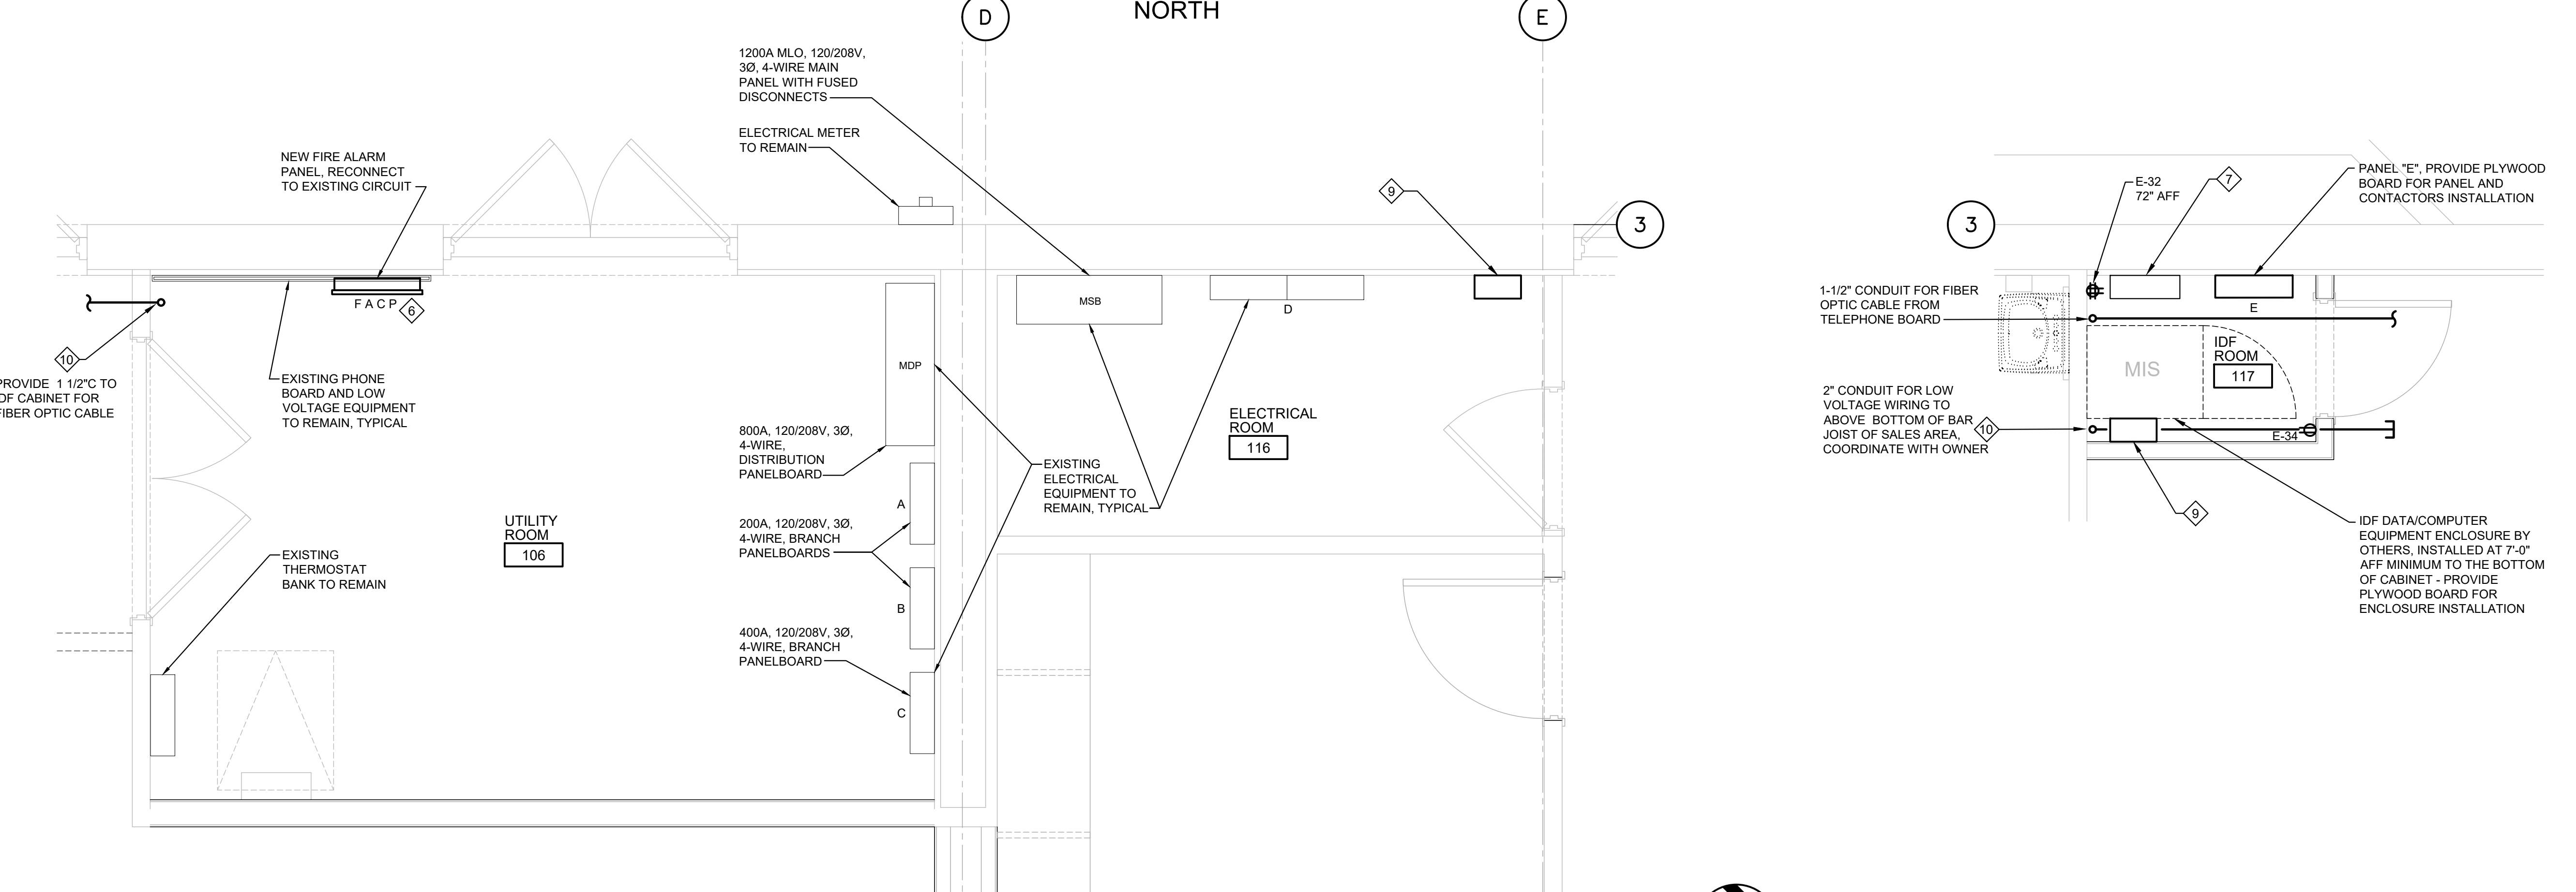

4 ELECTRICAL ROOM POWER PLAN
 E2.2 SCALE: 1/2"=1'-0"

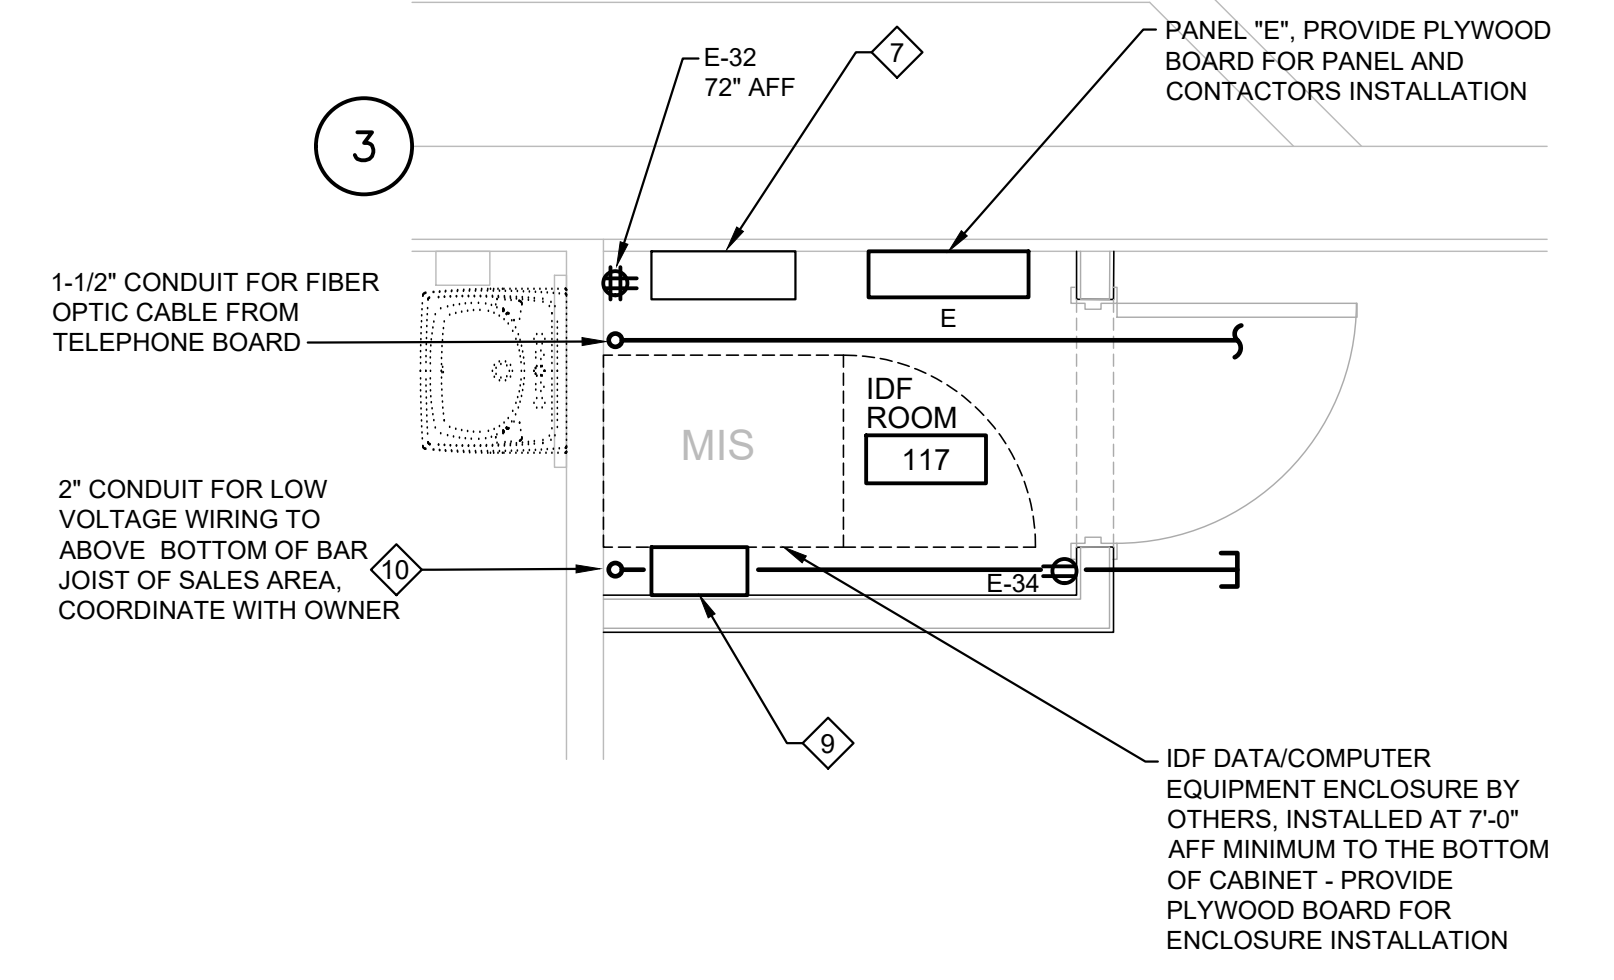

5 IDF CLOSET POWER PLAN
 E2.2 SCALE: 1/2"=1'-0"

GENERAL NOTES:

- NEW ELECTRICAL EQUIPMENT LAYOUT IS FOR SQUARE D EQUIPMENT. COORDINATE LAYOUT AND CLEARANCES IF DIFFERENT MANUFACTURER IS USED. PANEL CLEARANCES SHALL BE PROVIDED ACCORDING TO NEC ARTICLE 110.26, 110.32 AND 110.33.
- ALL EXISTING ELECTRICAL EQUIPMENT SHALL REMAIN UNLESS NOTED OTHERWISE.
- PROVIDE 3/4" FIRE RATED B/C GRADE PLYWOOD TO 8'-0" ABOVE FINISHED FLOOR IN ELECTRICAL CLOSET AND IDF CLOSET FOR NEW EQUIPMENT AS REQUIRED, REFER TO ARCHITECTURAL DRAWINGS.
- MOUNT NEW CONTACTORS BELOW OR ABOVE PANELS SERVED.
- THERMOSTAT BANK ENCLOSURE SHALL BE LOCATED WITHIN 10' OF MIS HUB (MDF OR IDF RACK/ENCLOSURE) TO ENSURE CONNECTION BETWEEN THERMOSTATS AND MIS HUB. COORDINATE WITH OWNER.

KEY NOTES:


- RECEPTACLES FOR VENDING AND REFRIGERATOR.
- MOUNT RECEPTACLE BELOW SINK FOR CONNECTION TO GARBAGE DISPOSAL. RECEPTACLE SHALL BE CONTROLLED BY A FRACTIONAL HORSE POWER RATED TOGGLE SWITCH, MOUNTED 8" ABOVE COUNTER.
- MOUNT RECEPTACLES FOR COFFEE MAKER AND MICROWAVE 8" ABOVE THE COUNTER.
- PROVIDE PUSH BUTTON FOR OFFICE #109 BUZZER, FLUSH MOUNTED IN WALL ADJACENT TO MANAGER ENTRY DOOR.
- ADJUSTABLE BUZZER FLUSH MOUNTED IN A BOX 6" BELOW CEILING, POWERED FROM LOW VOLTAGE TRANSFORMER, CONTROLLED BY PUSH BUTTON AT RECEIVING DOOR. PROVIDE WHITE LOUVERED WALL PLATE. COORDINATE EXACT LOCATION WITH RTG PROJECT MANAGER.
- NEW FIRE ALARM CONTROL PANEL FACP. REMOVE HVAC SMOKE DETECTORS SWITCHES (IF REQUIRED) TO BE LOCATED IN ELECTRICAL ROOM ABOVE FIRE ALARM CONTROL PANEL FACP.
- THERMOSTAT BANK FOR ROOF TOP UNITS, ROUTE 1" CONDUIT AND STUB-UP INTO THE SALES AREA BAR JOIST SPACE; CONDUIT SHALL STUB OUT IN SALES SPACE IMMEDIATELY ADJACENT TO BAR JOIST OR ROOF STEEL, SO THAT WHEN WIRES ARE PULLED THEY CAN FOLLOW STEEL.
- RECEPTACLES FOR TABLET BATTERY CHARGING STATIONS, DUPLEX AT 30" AND QUAD AT 42" ABOVE FINISH FLOOR. REFER TO ELEVATIONS ON SHEET A5.1.
- PROVIDE HOFFMAN ENCLOSURE FOR SALES LIGHTING MANUAL CONTROLS, REFER TO DETAIL 3E4.2.
- CONDUIT SHALL STUB OUT IN SALES SPACE IMMEDIATELY AND/OR ADJACENT TO BAR JOIST OR ROOF STEEL, SO THAT WHEN WIRES ARE PULLED THEY CAN FOLLOW STEEL. PROVIDE PLASTIC BUSHINGS. COORDINATE EXACT LOCATION OF PROVIDED CONDUIT FOR LOW VOLTAGE WIRING WITH OWNER PRIOR TO INSTALLMENT.
- RECEPTACLE CONTROLLED BY TIME CLOCK IN COMPLIANCE WITH ASHRAE 90.1 2016, SECTION 8 - (8.4.2). REFER TO PANEL SCHEDULE C ON SHEET E4.1 AND CONTACTOR SCHEDULE ON SHEET E4.2.
- INSTANT WATER HEATER, MOUNT DISCONNECT ABOVE THE CEILING. REFER TO PLUMBING PLAN FOR EXACT LOCATION AND POWER REQUIREMENTS. PROVIDE ALL FINAL CONNECTIONS PER MANUFACTURER'S SPECIFICATIONS.
- RECEPTACLE BELOW COUNTER FOR DRAIN PUMP. REFER TO PLUMBING PLANS FOR MORE INFORMATION.

ROOMS TO GO STORE EXPANSION AND REMODEL
 18722 SOUTH DIXIE HIGHWAY,
 CUTLER BAY, FL 33157

CONSTR. DOC. & REVISIONS

No.	Description	Date
1	ADD #2	11/29/23

CASCO PROFESSIONAL SERVICES, LLC
 ENGINEERING LICENSE
 NUMBER CA29655

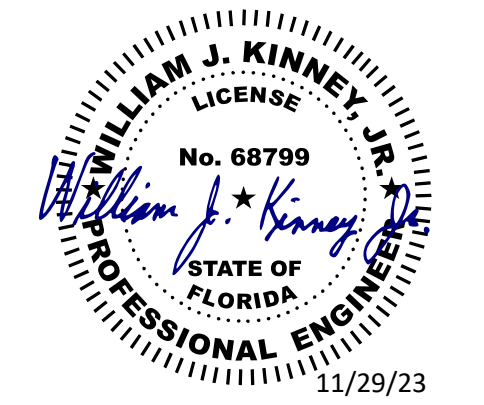

EXP. DATE 02/28/25
 LIC #68799
 WILLIAM J. KINNEY

Drawn By/Checked By: ZT
 Project Number: 2101445
 Bid Date: 11/09/23
 Permit: 03/28/23
 Owner Date: 07/06/22

POWER PLAN
E2.2

Panel MSB Electrical Room 111. Capacity: 1,140A. Includes table with columns for MOUNT, SURFACE, LOCATION, and a detailed schedule of electrical components like RTU, SPARE, and PANEL 'D'.

Panel MDP Electrical Room 107. Capacity: 600A. Includes table with columns for MOUNT, SURFACE, LOCATION, and a detailed schedule of electrical components like BLANK, PANEL 'B', and PANEL 'A'.

Panel E Electrical Closets. Capacity: 200A. Includes table with columns for MOUNT, SURFACE, LOCATION, and a detailed schedule of electrical components like ADULT SHOWROOM REC and SPARE.

Panel D Electrical Room 111. Capacity: 200A. Includes table with columns for MOUNT, SURFACE, LOCATION, and a detailed schedule of electrical components like SHOWROOM TRACK LTG, SPARE, and various receptacles.

Panel A Electrical Room 107. Capacity: 60A. Includes table with columns for MOUNT, SURFACE, LOCATION, and a detailed schedule of electrical components like SHOWROOM TRACK LTG, SPARE, and various receptacles.

Panel B Electrical Room 107. Capacity: 200A. Includes table with columns for MOUNT, SURFACE, LOCATION, and a detailed schedule of electrical components like STOREFRONT TRACK LTG, SALES REC, and various receptacles.

Panel C Electrical Room 107. Capacity: 400A. Includes table with columns for MOUNT, SURFACE, LOCATION, and a detailed schedule of electrical components like FACP, RTU, and various receptacles.


EXISTING PANEL SCHEDULE NOTES. 1. ALL BREAKERS IN EXISTING PANELBOARDS ARE EXISTING TO REMAIN UNLESS SHOWN IN HEAVY LINE WEIGHT. 2. PANEL SCHEDULES ARE SHOWN TO AID THE CONTRACTOR IN PROVIDING NEW TYPED DIRECTORY CARDS FOR ALL EXISTING PANELBOARDS TO BE REWORKED AS SHOWN ON THIS SHEET.

MINIMUM WIRE & CONDUIT SIZES FOR CIRCUIT BREAKERS AND FUSES. Table with columns for AMP, CONDUCTOR, GROUND, and CONDUIT.

VOLTAGE DROP SCHEDULE. Table with columns for RUN DISTANCE IN FEET and WIRE SIZE AWG.

CONSTR. DOC. & REVISIONS. Date: 11/29/23. Description: 1. ADD #2.

CASCO PROFESSIONAL SERVICES, LLC. ENGINEERING LICENSE NUMBER CA29655.

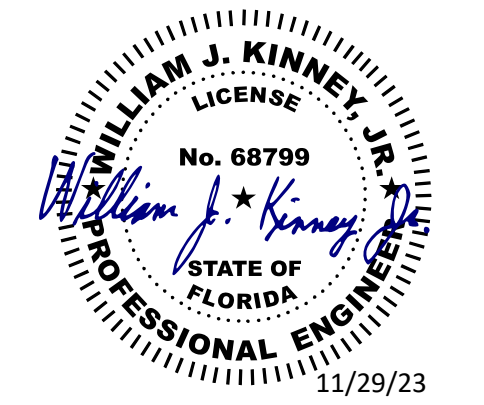

Drawn By/Checked By: ZT. Project Number: 2101445. Bid Date: 11/09/23. Permit: 03/28/23. Owner Date: 07/06/22.

PANEL SCHEDULES E4.1